
AUSTIN HEIGHTS FIRE STATION - FACADE REMOVAL PROJECT

428 NELSON STREET, COQUITLAM, BC, V3K 3P1 MH PROJECT NO. 2100820.00
ISSUED FOR TENDER
NOVEMBER 14, 2023

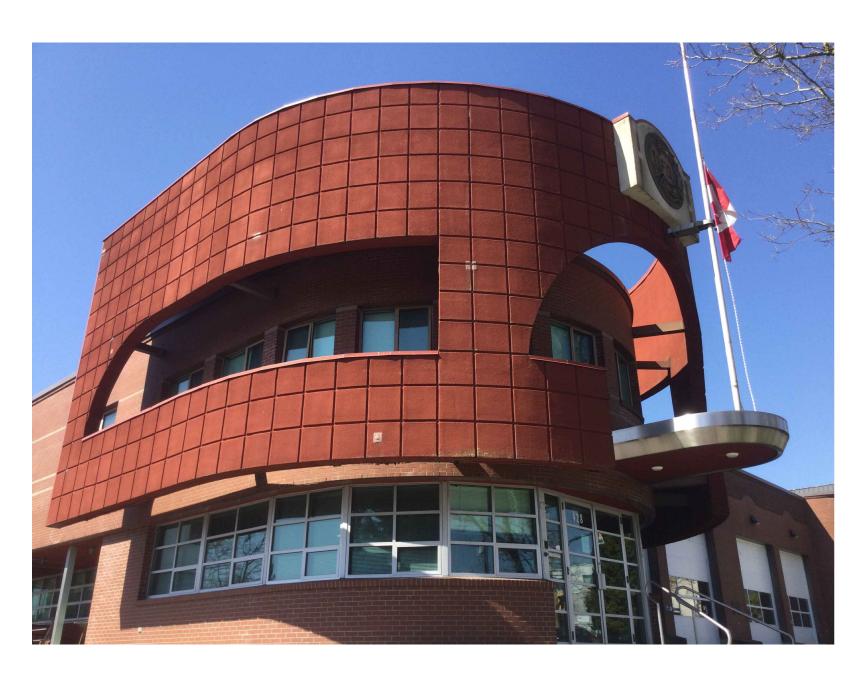

DRAWING LIST:

GENERAL ARRANGEMENT

G0.000 DRAWINGS LIST G0.001 GENERAL NOTES

G0.002 SYMBOLS, LEGENDS & ASSEMBLY LIST

A1.100 SITE PLAN

A1.101 GROUND FLOOR PLAN
A1.102 UPPER FLOOR PLAN
A2.400 FLEVATIONS


A2.100 ELEVATIONS

DETAILS

A5.200 BEAM TO WALL DETAIL A5.201 ANTENNA COVER DETAIL

A5.202 CORNER DETAIL

E.G.B.C. PERMIT No.: 1001424

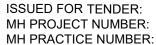

2023-11-14 210300000 1001424



MORRISON HERSHFIELD

SUITE 310 - 4321 STILL CREEK DR. BURNABY BC, V5C 6S7 604-454-0402 (Tel.) 604-454-0403 (fax) www.morrisonhershfield.com

GENERAL NOTES:

0.00	DRAWINGS ARE TO BE READ IN CONJUNCTION WITH WRITTEN SPECIFICATIONS
0.01	DO NOT SOLELY RELY ON SCALE DRAWINGS. CONTRACTOR IS TO VERIFY DIMENSIONS ON SITE.
0.02	DRAWINGS AND PLANS PREPARED BY MH ARE BASED ON INFORMATION TAKEN FROM ORIGINAL ARCHITECTURAL DRAWINGS DATED MARCH 1988.
0.03	FORM FLASHING TO MAINTAIN MINIMUM 6% SLOPE, UNLESS OTHERWISE NOTED.
0.04	ALL TERMINATIONS IN METAL FLASHING TO HAVE FOLDED END DAMS. FLASHING DOWNTURN LEG TO COVER CLADDING MINIMUM 2" UNLESS OTHERWISE NOTED. ALL JOINTS TO BE S-LOCK OR STANDING SEAM. MAINTAIN $\frac{1}{4}$ " GAP BETWEEN DOWN LEG OF FLASHING & CLADDING.
0.05	TYPICAL SEALANT JOINT TO BE MINIMUM $rac{3}{8}$ " WIDE UNLESS NOTED OTHERWISE.
0.06	IF ANY DISCREPANCIES IN THE DOCUMENTS ARE FOUND, REQUEST THE CONSULTANT TO CLARIFY THE DISCREPANCIES PRIOR TO COMMENCING ANY RELATED WORK.
0.07	NOTIFY THE CONSULTANT IMMEDIATELY AND REQUEST A REVIEW IF ANY ADDITIONAL DAMAGE OF EXISTING AREAS OUTSIDE THE CONTRACT IS DISCOVERED. DO NOT COMMENCE ANY RELATED OR NEARBY WORK WITHOUT CONSULTANT'S APPROVAL.
0.08	CONTRACTOR IS RESPONSIBLE FOR SAFETY ON JOB SITE DURING CONSTRUCTION
0.09	PROVIDE MOCK-UP OF ALL DETAILS FOR APPROVAL PRIOR TO PROCEEDING WITH SUBSEQUENT INSTALLATION
0.10	ANY DAMAGE CAUSED TO THE INTERIOR FINISHES AS A RESULT OF ONGOING CONSTRUCTION TO BE REPLACED WITH NEW TO MATCH EXISTING BY THE CONTRACTOR. CONTRACTOR TO REVIEW AND KEEP RECORD OF EXISTING CONDITIONS PRIOR TO PROJECT START-UP.
0.11	CLEAN UP ALL AREAS AFFECTED BY THE WORK TO THE SATISFACTION OF THE OWNER UPON PROJECT COMPLETION.
0.12	PROVIDE NEW SEALANTS BETWEEN CLADDING ASSEMBLIES WHERE REMOVED TO COMPLETE THE WORK.
0.13	NEW MASONRY UNIT TO MATCH EXISTING TYPE, DIMENSIONS, AND COLOR AS CLOSE TO THE EXISTING AS POSSIBLE.

3	Issued for Tender	2023-11-14
2	Issued for Permit	2023-11-14
1	Issued for 90% Client Review	2023-05-19
ersion	Description	YYYY-MM-DD

E.G.B.C. PERMIT No.: 1001424



FACADE REMOVAL PROJECT AUSTIN HEIGHTS FIRE STATION 428 NELSON STREET, COQUITLAM, BC, V3K 3P1 MH No. 201030000

GENERAL NOTES


Scale

Designed		Drawn		Checked			
CJT		MIK		CJT			
DWG No.		Version	Date				
G0.001		3	2	023-10-20			

DETAIL HATCHING LEGEND



RIGID & SEMI-RIGID INSULATION

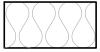

BATT INSULATION



INTERIOR GYPSUM WALLBOARD THICKNESS AS SPECIFIED

SYMBOLS LEGEND



ASSEMBLY TYPE REFERENCE



REVISION TAG



REVISIONS CLOUD

ABBREVIATIONS LIST

AIR/MOISTURE BARRIER A/M

C/W COMPLETE WITH

DWG. DRAWING EXIST. **EXISTING**

GWB GYPSUM WALL BOARD

MIN. MINIMUM

N.I.C. NOT IN CONTRACT O.C. ON CENTRE

PΤ PRESSURE TREATED

REV. REVERSED

RE&RE REMOVE & REINSTALL R.O. ROUGH OPENING R.W.L. RAINWATER LEADER S.A.M. SELF ADHESIVE MEMBRANE

S.M. SHEATHING MEMBRANE

SIM. SIMILAR

S.O.G. SLAB-ON-GRADE T&G **TONGUE & GROOVE** T.B.C. TO BE CONFIRMED T.O.W. TOP OF WALL

TYP. TYPICAL

U.N.O. UNLESS NOTED OTHERWISE

ADD. ADDENDUM

L.A.M. LIQUID APPLIED MEMBRANE

B&B **BOARD & BATTEN**

ASSEMBLIES

WALL ASSEMBLY (EXISTING)

EXTERIOR

- BRICK MASONRY VENEER
- RAINSCREEN CAVITY
- WATER RESISTANT BARRIER
- CONCRETE BLOCK WALL
- STEEL STUD FRAMING W/BATT INSULATION
- POLYETHYLENE (AIR/VAPOUR BARRIER)
- PAINTED DRYWALL INTERIOR

(W2) FACADE ASSEMBLY (EXISTING)

EXTERIOR (OUTWARD FACADE)

- ACRYLIC FINISH COAT
- BASE COATING WITH GLASS-FIBER REINFORCING MESH
- EXPANDED POLYSTYRENE (EPS) INSULATION BOARD
- PLYWOOD
- STEEL FRAMING WITH FASTENERS
- PAPER-FACED GYPSUM
- EXPANDED POLYSTYRENE (EPS) INSULATION BOARD
- BASE COATING WITH GLASS-FIBER REINFORCING MESH
- ACRYLIC FINISH COAT INTERIOR (INNER FACADE)

EXTERIOR (INWARD FACING)

3 Issued for Tender 2023-11-14 2 Issued for Permit 2023-11-14 Issued for 90% Client Review 2023-05-19 YYYY-MM-DD Version Description

Stamp

E.G.B.C. PERMIT No.: 1001424




MORRISON HERSHFIELD


FACADE REMOVAL PROJECT AUSTIN HEIGHTS FIRE STATION 428 NELSON STREET, COQUITLAM, BC, V3K 3P1 MH No. 201030000


SYMBOLS, LEGENDS & **ASSEMBLY LIST**

Scale


Designed	Drawn		Checked	
CJT	М	IK	CJT	
DWG No.	Version	Date		
G0.002	3	2	023-10-20	

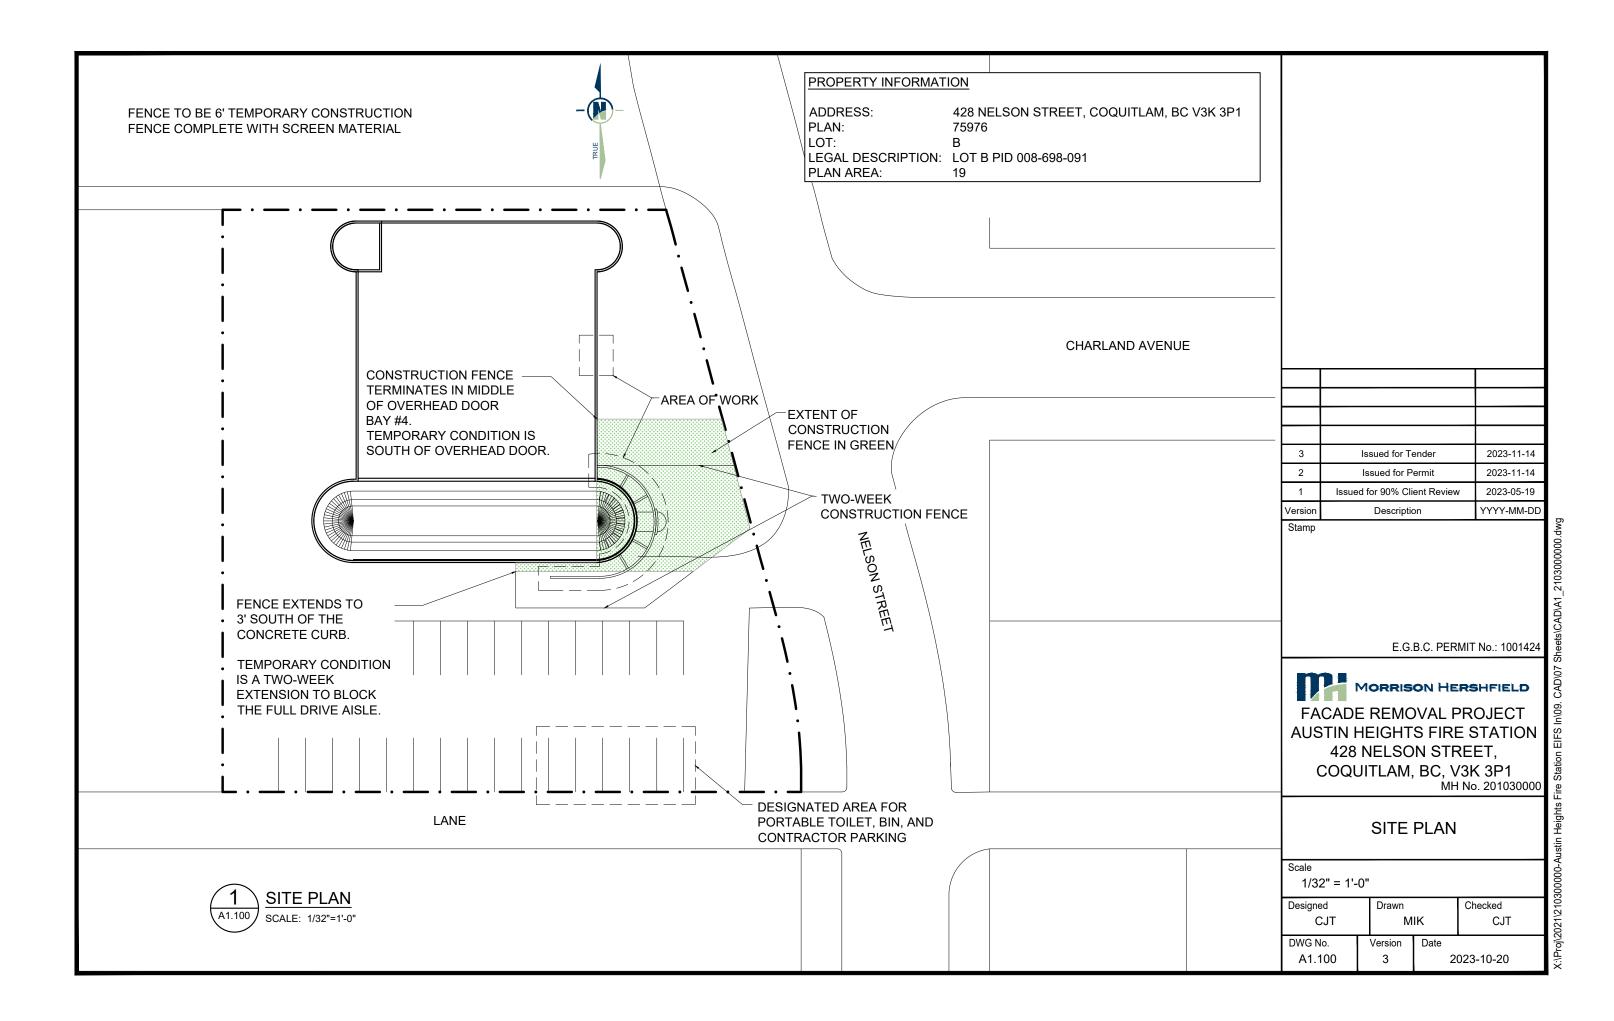


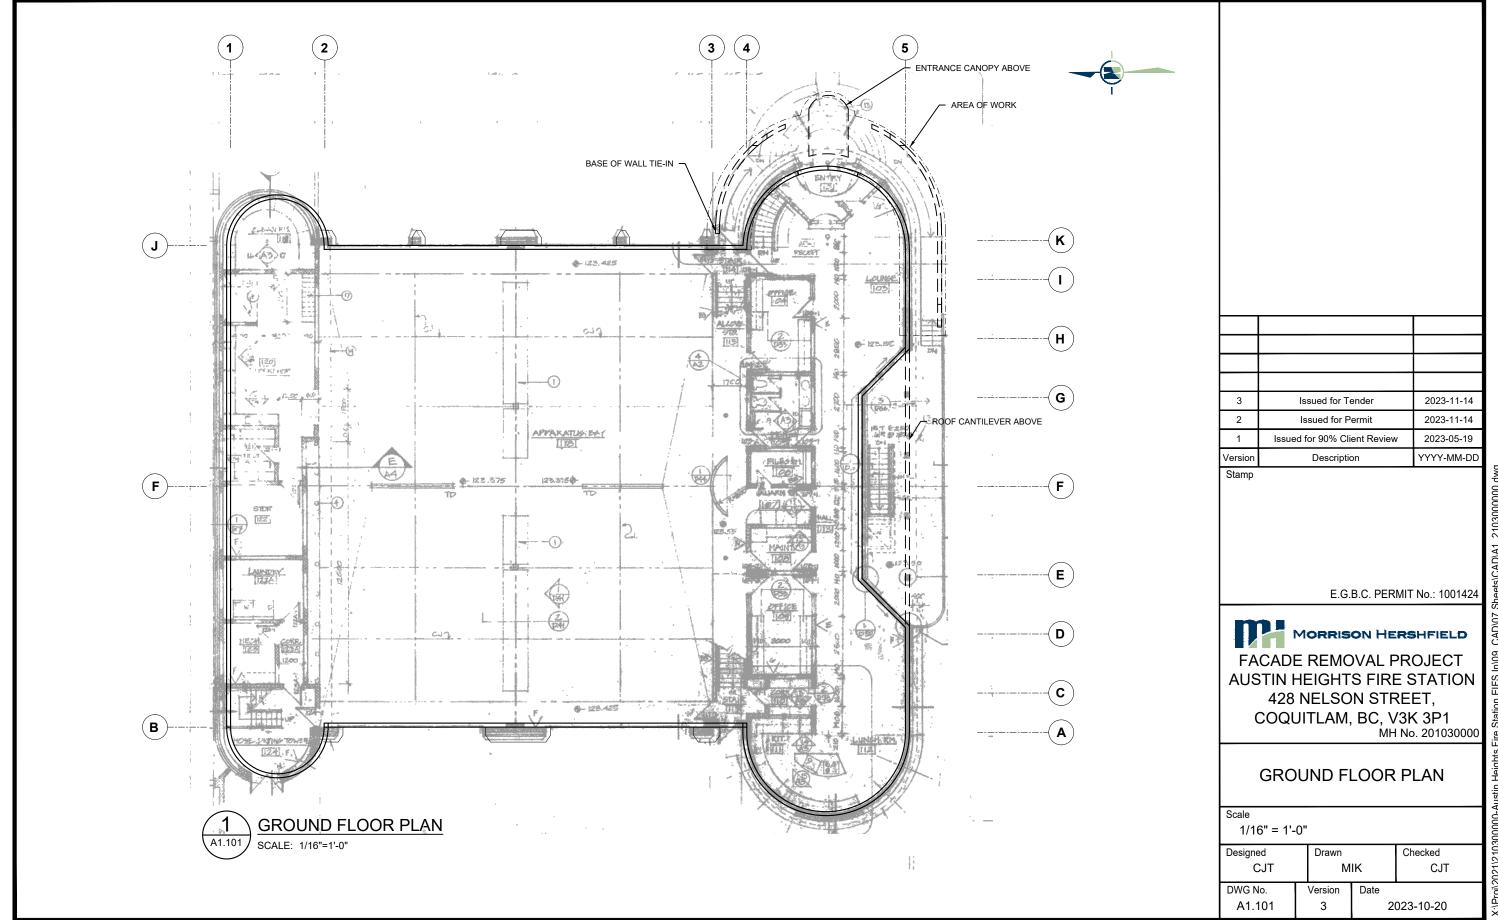


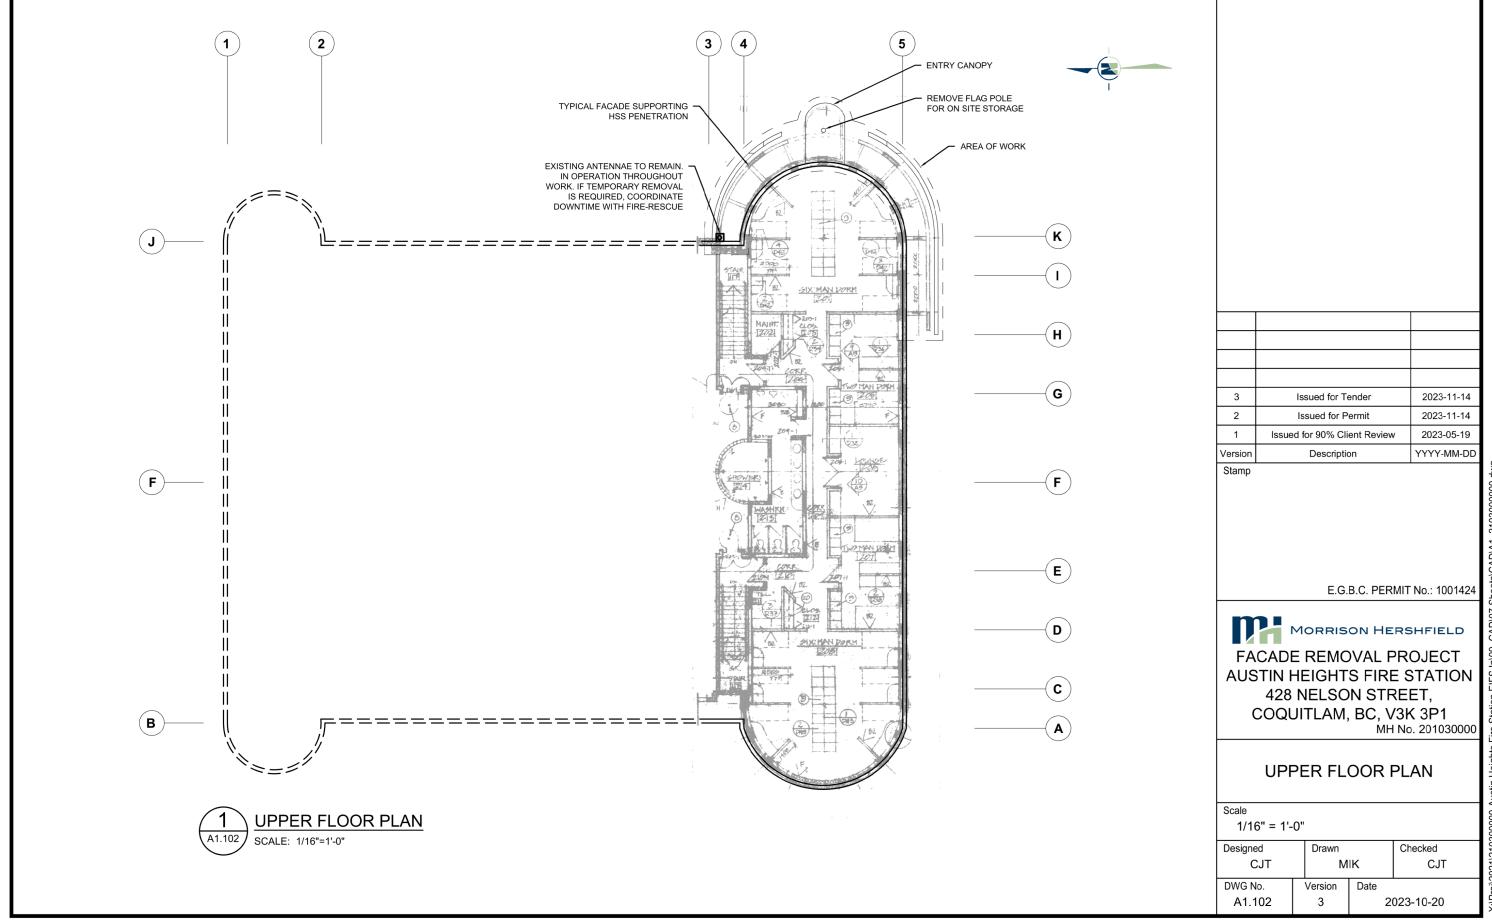

oj/2021/210300000-Austin Heights Fire Station EIFS In\09. CAD\07 Sheets\CAD\A1_2103000000.dwg

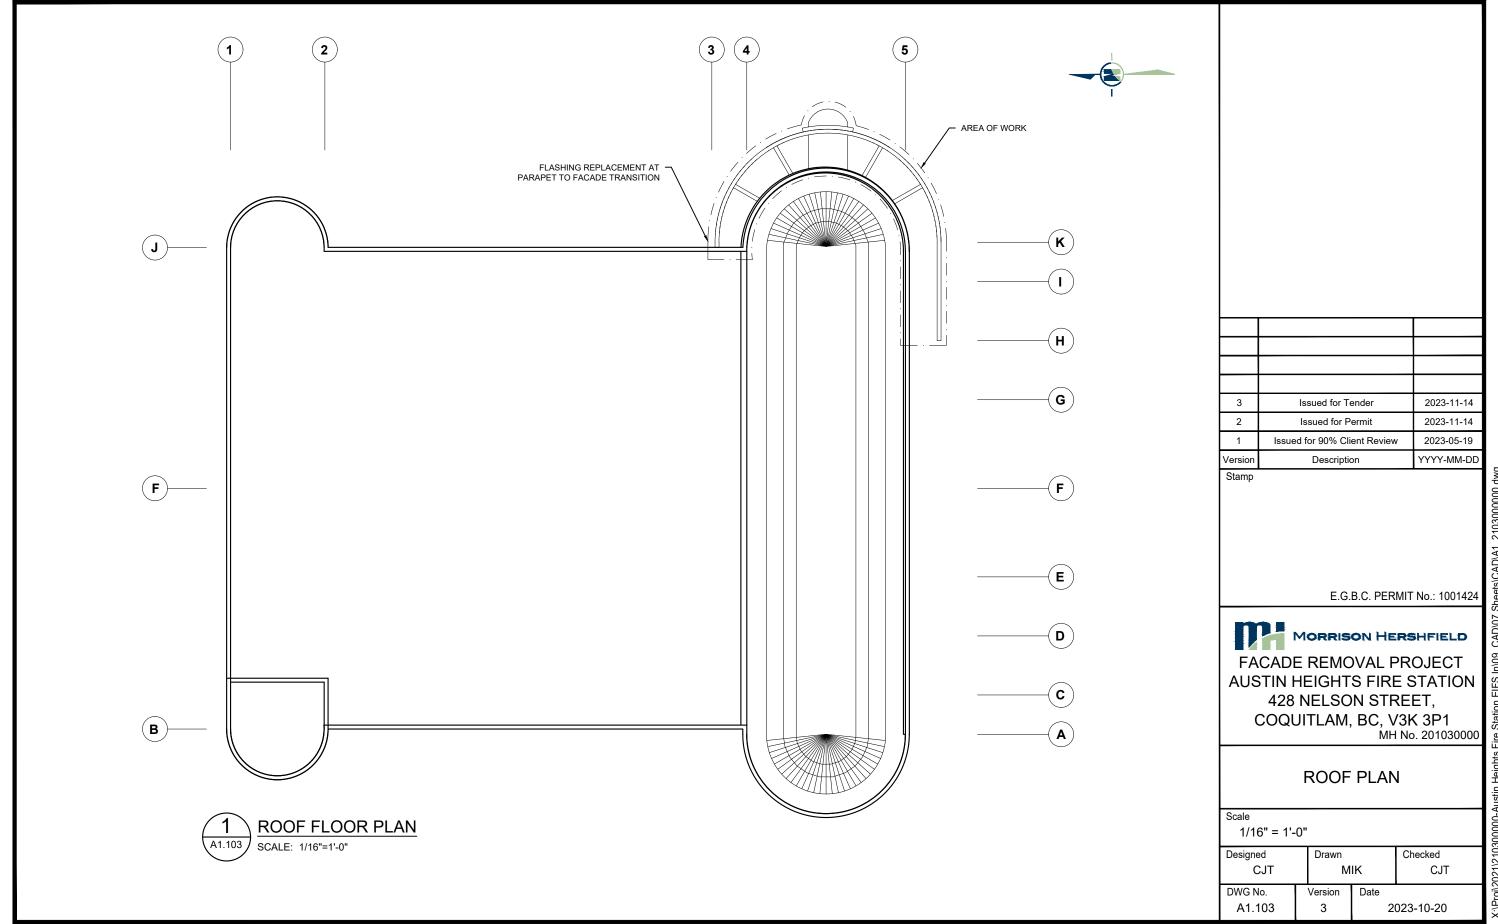


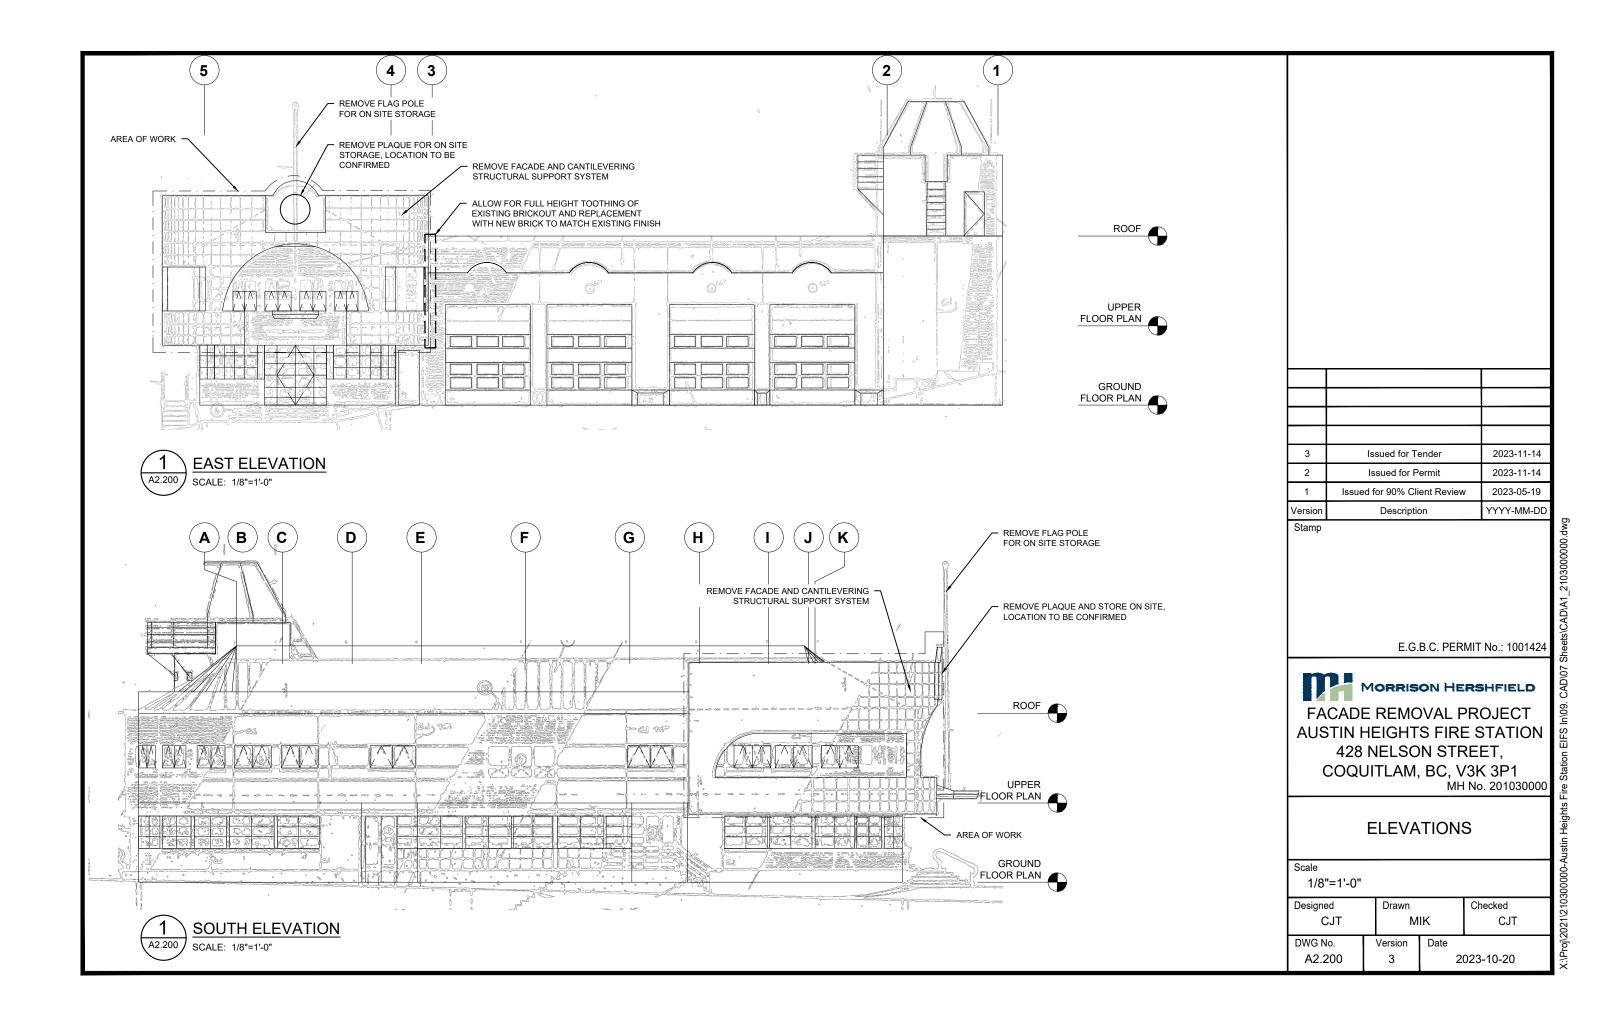

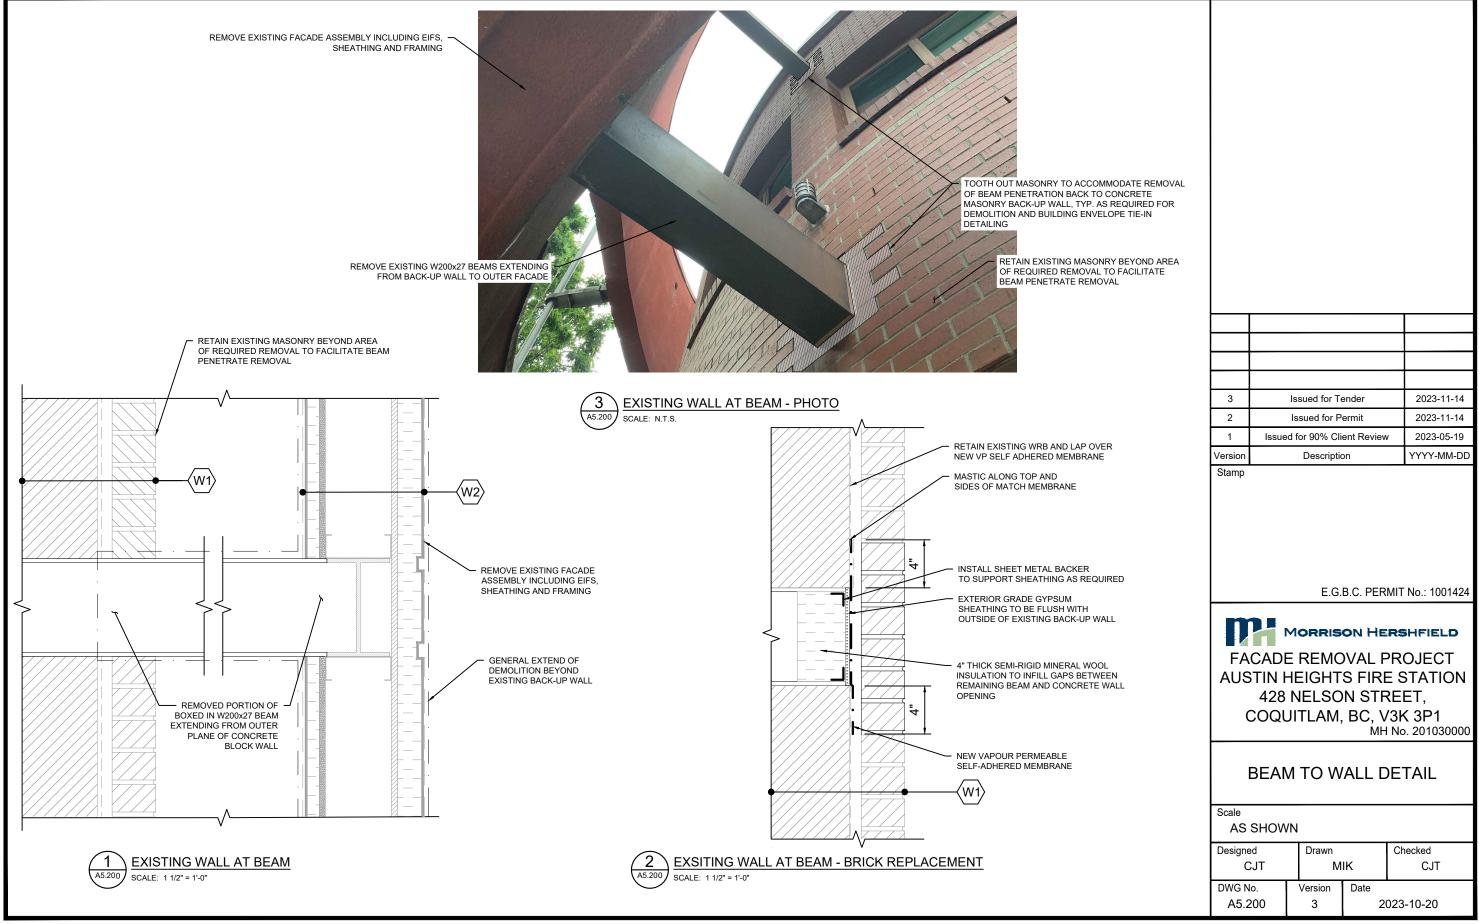

oj/2021/210300000-Austin Heights Fire Station EIFS In\09. CAD\07 Sheets\CAD\45_2103000000.dwg

ANTENNAE TO REMAIN IN OPERATION THROUGHOUT CONSTRUCTION. IF TEMPORARY DISCONNECT IS REQUIRED, COORDINATE DOWNTIME WITH FIRE-RESCUE

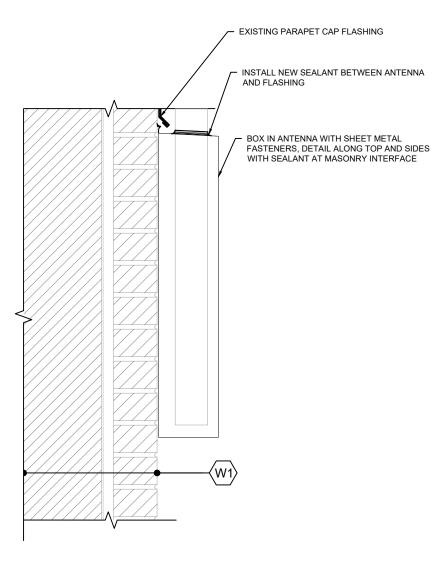



A5.201 ANTENNA SCALE: N.T.S. ANTENNA COVER FLASHING SWING - PHOTO

3 Issued for Tender 2023-11-14 Issued for Permit 2023-11-14 Issued for 90% Client Review 2023-05-19 Description YYYY-MM-DD Version

Stamp

E.G.B.C. PERMIT No.: 1001424



MORRISON HERSHFIELD

FACADE REMOVAL PROJECT AUSTIN HEIGHTS FIRE STATION 428 NELSON STREET, COQUITLAM, BC, V3K 3P1 MH No. 201030000


ANTENNA COVER DETAIL

Scale

AS SHOWN

ı							
	Designed		Drawn		Checked		
	CJT		MIK		CJT		
	DWG No.	Version		Date			
	A5.201		3	2	023-10-20		


ANTENNA COVER FLASHING SWING A5.201 SCALE: 1 1/2" = 1'-0"

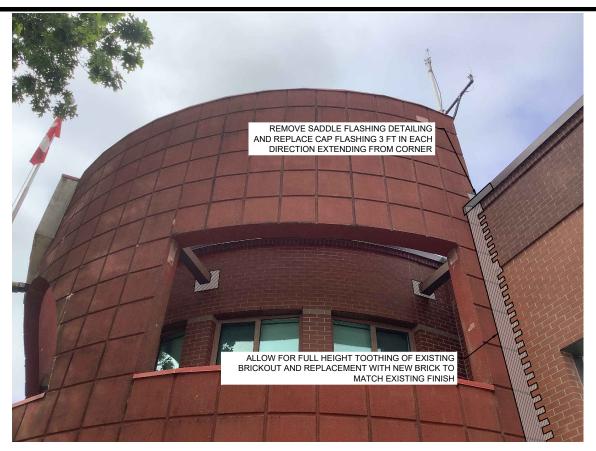



CORNER DETAIL - PHOTO SCALE: N.T.S.

CORNER DETAIL PHOTO - ENLARGED SCALE: N.T.S.

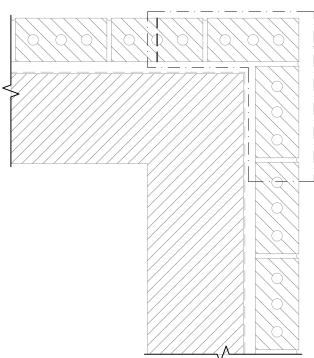

ALLOW FOR FULL HEIGHT TOOTHING OF EXISTING BRICKOUT AND REPLACEMENT WITH NEW BRICK TO MATCH EXISTING

3	Issued for Tender	2023-11-14
2	Issued for Permit	2023-11-14
1	Issued for 90% Client Review	2023-05-19
Version	Description	YYYY-MM-DD

Stamp

E.G.B.C. PERMIT No.: 1001424



MORRISON HERSHFIELD

FACADE REMOVAL PROJECT AUSTIN HEIGHTS FIRE STATION 428 NELSON STREET, COQUITLAM, BC, V3K 3P1 MH No. 201030000

CORNER DETAIL

Scale AS SHOWN

AO OHOWN					
Designed		Drawn		Checked	
CJT		MIK		CJT	
DWG No.		Version	Date		
A5.202		3	2	023-10-20	

CORNER DETAIL
SCALE: 1 1/2" = 1'-0"