

## **For Board of Variance**

February 10, 2025

- Our file: 01-0340-20/03-017/1 Doc #: 5596663.v2
- To: Manager Legislative Services
- From: Manager Building Permits Approvals

Subject: Brief to Board of Variance - February 25, 2025

#### For: Board of Variance

#### ITEM #1

Applicant No.:	24 124405 BV			
Site Address:	3717 Lincoln Avenue			
Zoning:	RS-2 One-Family Suburban Residential			
Environmentally Sensitive Lands:	Yes			
ROW/Covenants:	No			
Legal Description:	Lot 48 Sections 5 and 8 Township 40 NWLD Plan NWP2320			

### Proposal

This application proposes to vary the minimum required height from 11 metres to 14.23 metres, to permit a Single Family Dwelling. A Building Permit application was submitted on October 1, 2024 for a single family dwelling with a secondary suite and a barn.

The property is at the boundary of Coquitlam and Port Coquitlam. This property currently consists of a mobile home, temporary covered areas, sitting areas, storage areas, and a small building with fencing inhabited by llamas, is located in the Northeast Coquitlam Area Plan and is designated Agricultural in the Citywide Official Community Plan (Attachment 2). The property is located within the Agricultural Land Reserve (ALR).

The applicant has indicated that the current height restrictions for single family dwelling structures in the RS-2 zone present a hardship due to the limitations imposed by the floodplain. To meet the mandatory flood protection requirements, the habitable area must be above 6.44 m (above mean sea level datum). The Zoning Bylaw defines height as measured from the lower of existing or finished grade to the highest peak of the roof, resulting in the 11-metre height maximum being measured from the existing lot grade. Combined with the proposed steep pitched roof, this results in an overall height of 14.23 m from existing grade, which exceeds the maximum allowable height of 11 metres by 3.23 m.

### ITEM #1 cont'd

### Variance Requested

The applicant requests the following variance for the Board's consideration:

Pursuant to s.540 of the *Local Government Act*, the provisions of the *City of Coquitlam Zoning Bylaw No. 3000, 1996* as amended is requested to be varied and supplemented as follows:

Part 10, One-Family Residential Zones, Section 1002(10)(a), the height for one-family residential use must not exceed 11.0 metres for buildings and structures having a roof slope with a pitch of 3 in 12 or greater for an area of at least 80% of all roof surfaces.

### Development Proposal Building Height – Section 1002(10)(a)

Height	Bylaw Requirement	Proposed	Variance Required	
Buildings and structures for one-family residential use having a roof slope with a pitch of 3 in 12 or greater for an area of at least 80% of all roof surfaces	uildings and structures or one-family residential se having a roof slope vith a pitch of 3 in 12 or reater for an area of at east 80% of all roof		Yes, variance of 3.23 metres	

## Considerations

Based on information submitted with the application, and staff review of the requested variances, matters that the Board may wish to take into account when considering their decision include:

- The RAPR report, currently pending approval from the Province, identifies a required front setback of 30.38. While one side of the one-family dwelling meets this requirement, the east side encroaches into the front setback by 20 cm.
- The RAPR report confirms that the barn is located outside of the 5 m Streamside Protection Environment Area (SPEA) from the western ditch. However, the Zoning Bylaw stipulates a 15 m setback for agricultural use.
- The site plan does not identify designated off-street parking for the secondary suite.

The above considerations will be addressed during the building permit review process and may require the applicant to revise the siting of the proposed structures.

In accordance with the *Local Government Act*, the Board will also want to consider the hardship as expressed by the applicant and any input received from the neighbours.

### ITEM #1 cont'd

If the Board grants this variance, the applicant will be required to comply with all other Zoning Bylaw requirements and satisfy all British Columbia Building Code requirements.


If the Board declines this application, the applicant could apply for a Development Variance Permit.

n Bohtempo WB/ce

#### **Attachments:**

- 1. Architectural Plans (# 5583987)
- 2. Existing OCP Land Use Designations (# 5596970)
- 3. Adjacent Zoning (# 5597010)
- 4. Topographic Survey Plan (# 5583990)
- 5. Bylaw No. 3000, 1996, Schedule G (# 5597028)
- 6. Applicant Rationale (# 5599623)



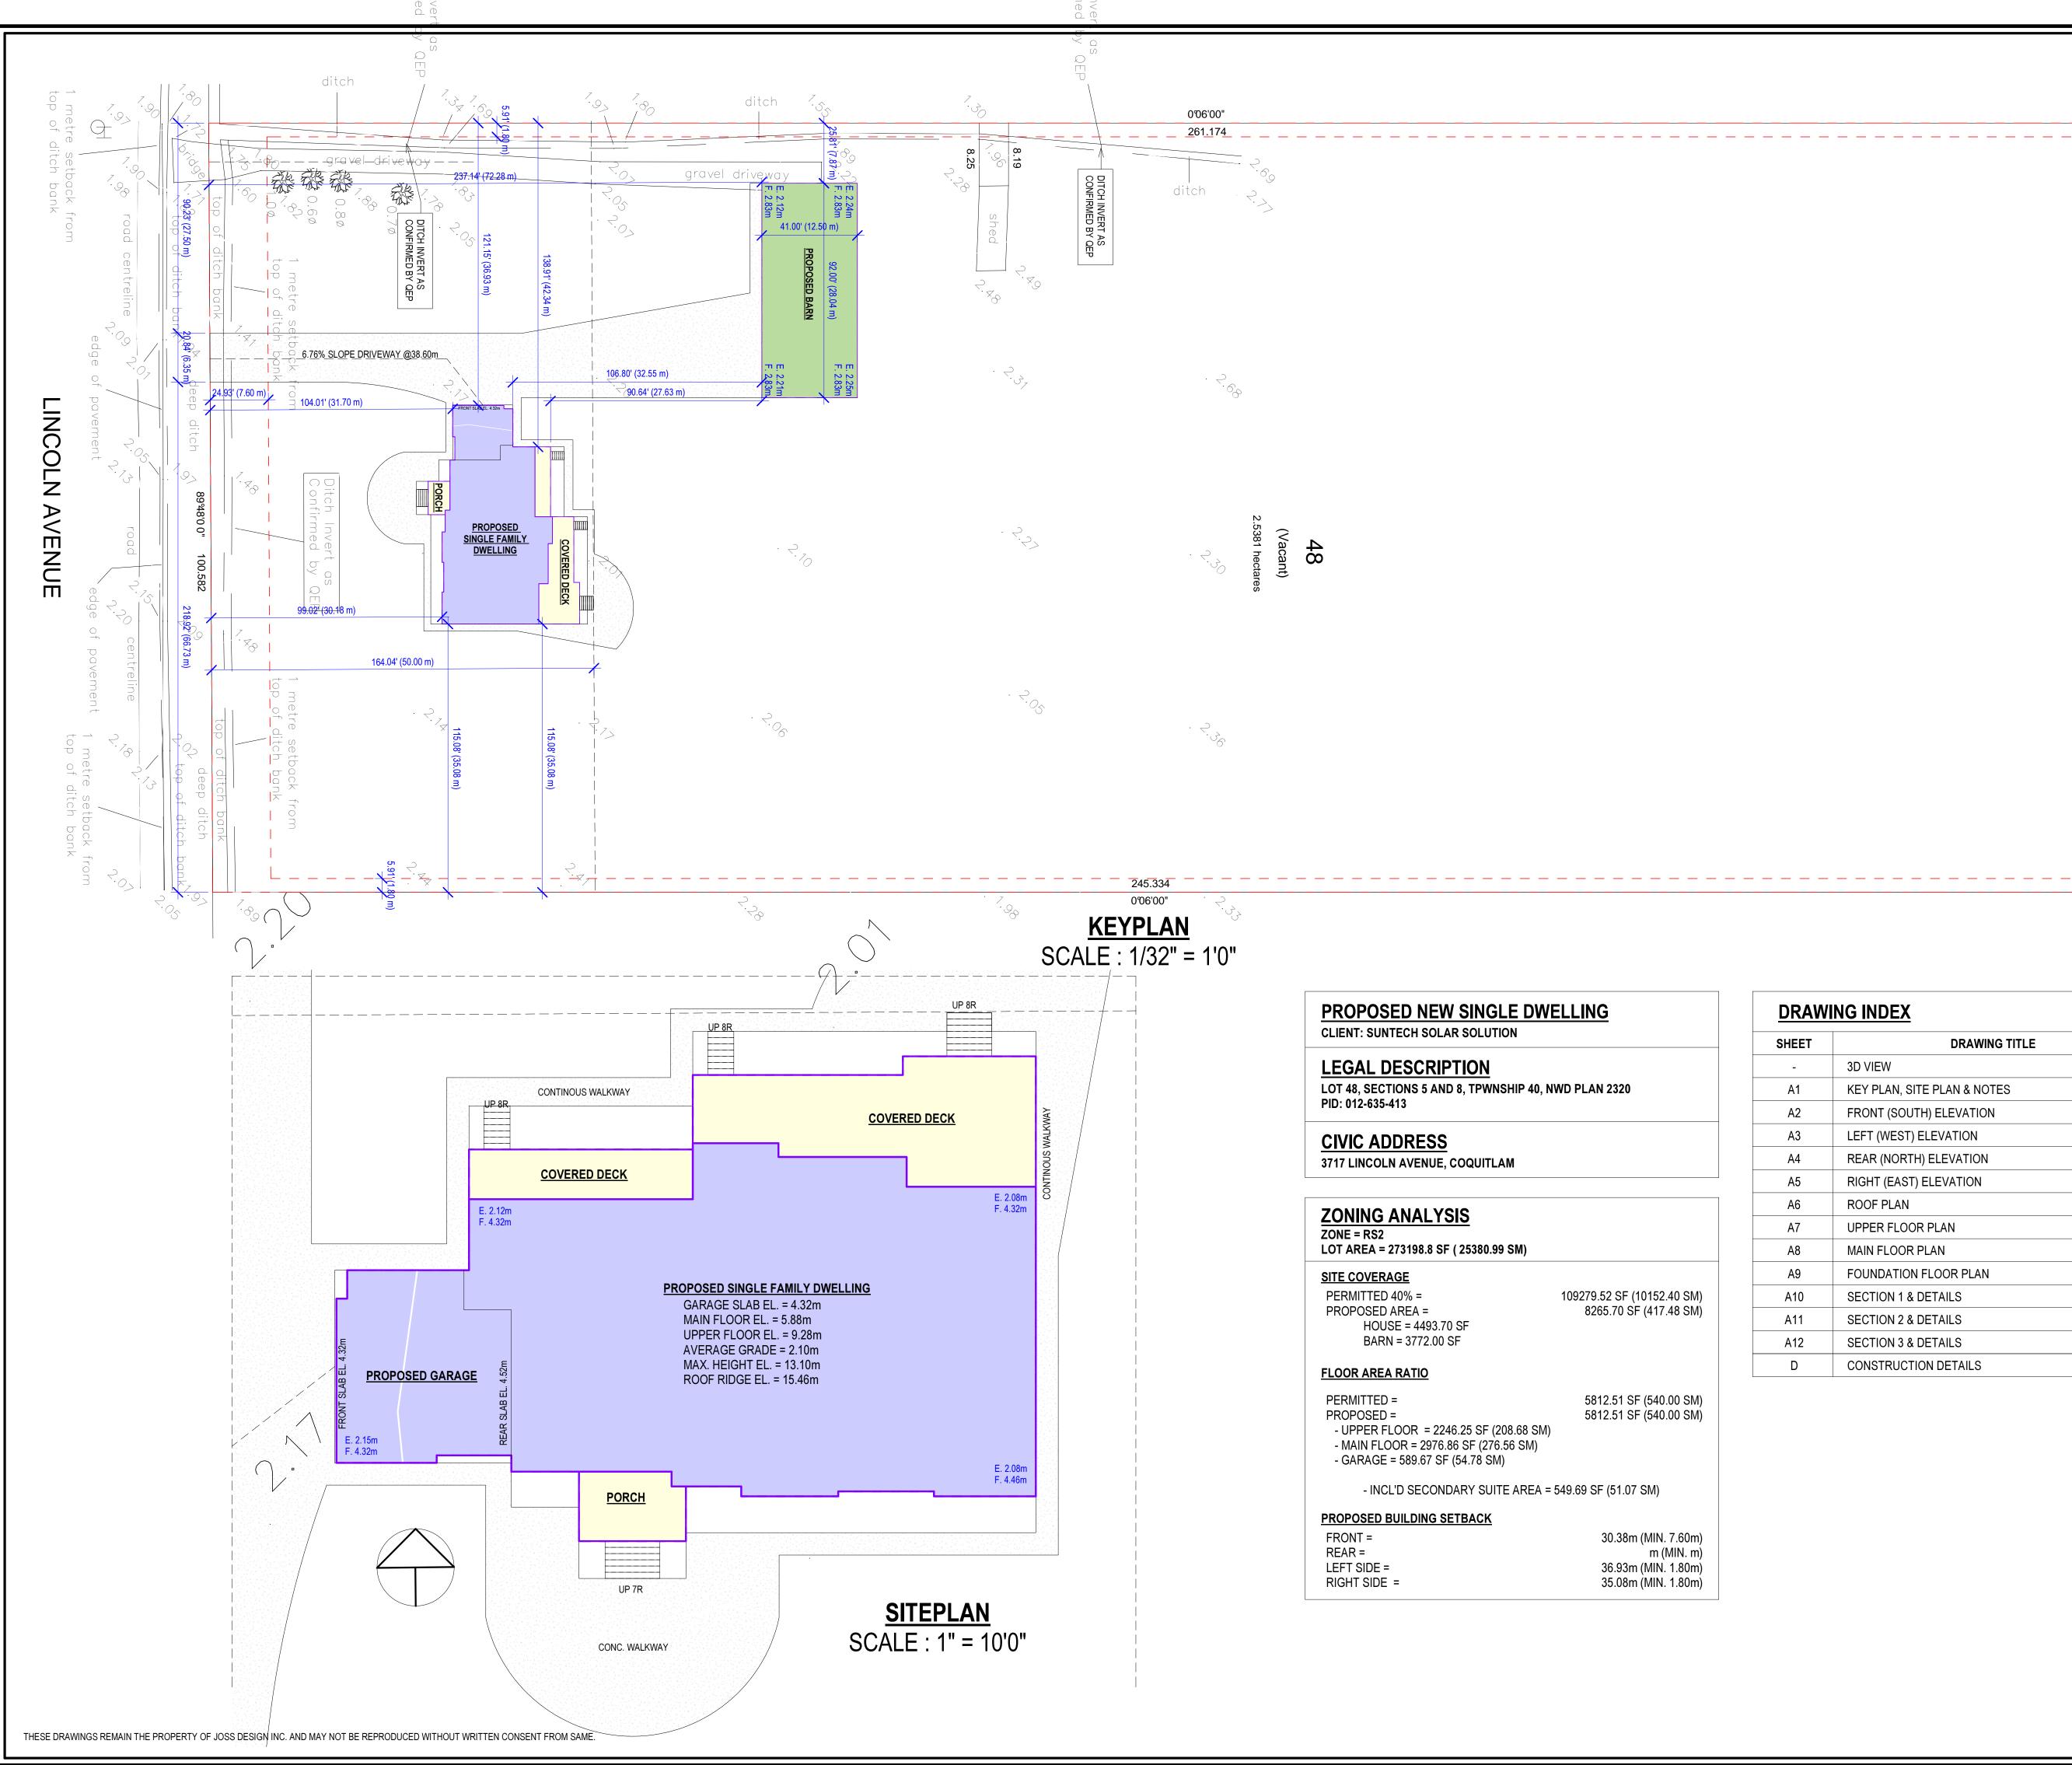

## Attachments1, Page 2 of 13

THESE DRAWINGS HAVE BEEN PREPARED BY JOSS DESIGN INC. TO CONFORM TO CURRENT RESIDENTIAL STANDARDS OF THE BRITISH COLUMBIA BUILDING CODE (B.C.B.C.) 2024 AND THE SPAN BOOK 2004 EDITION. THE BUILDER IS RESPONSIBLE FOR ENSURING THAT ALL CONSTRUCTION CONFORMS TO PROVINCIAL AND LOCAL BUILDING CODES AND BY-LAWS.

IT IS THE CONTRACTOR'S RESPONSIBILITY TO CHECK AND VERIFY ALL DIMENSIONS, MATERIALS, AND SPECIFICATIONS PRIOR TO CONSTRUCTION. ANY ERROR OR OMISSIONS SHALL BE BROUGHT TO OUR ATTENTION IMMEDIATELY SO THAT CORRECTIONS CAN BE MADE AND PLANS REPLACED.

DO NOT SCALE DRAWINGS. JOSS DESIGN INC. WILL NOT BE RESPONSIBLE FOR DEPARTURES FROM AND/OR CHANGE TO THESE PLANS.

## STRUCTURAL SPECIFICATIONS

 $\Box$ 

Π

0

Ň

Π

SL

OUGH

EXTERIOR WALLS ARE DRAWN 6" THICK ASSUMING 1/2" PLYWOOD SHEATHING ON 5-1/2" STUDS. ALL INTERIOR WALLS ARE DRAWN 4" OR 6" THICK FOR 2x4 OR 2x6 STUD WALLS.

DIMENSIONS TO BE TAKEN FROM OUTSIDE FACE OF SHEATHING FOR EXTERIOR WALLS AND CENTRE OR FACE OF STUDS FOR INT. WALLS AS SHOWN.

ALL HEIGHT DIMENSIONS ON FLOOR PLANS ARE FROM TOP OF FLOOR PLYWOOD.

APPLICATION OF MATERIALS MUST CONFORM TO THE TABLES PROVIDED IN THE SPAN BOOK 2004 EDITION.

BUILDING FRAMES SHALL BE ANCHORED TO THE FOUNDATION WALLS BY FASTENING A SILL PLATE TO THE FOUNDATION WALL WITH 13MM ANCHOR BOLTS SPACED AT 1800MM ON CENTER, UNLESS OTHERWISE NOTED.

FLOOR JOISTS SPANNING MORE THAN 2100MM ARE TO BE BRIDGED AT MID SPAN OR AT 2100MM ON CENTRE BY 38x38 DIAGONAL BRIDGING. ALL SUBFLOORS TO BE 15. 5MM T&G PLYWOOD, GLUED AND NAILED TO THE JOISTS.

WINDOW AND DOOR SIZES ARE APPROXIMATE AND CONTRACTOR SHALL CHECK WITH WINDOW AND DOOR SUPPLIER FOR ACTUAL ROUGH OPENINGS.

ALL LINTELS ARE TO BE 2-38x135 D. FIR NO. 2 OR BETTER, UNLESS OTHERWISE STATED, AND SHALL BE SUPPORTED ON A MINIMUM 38MM BEARING.)

BUILDER TO CHECK SNOW LOAD AND RAIN LOAD GUIDELINES FOR THEIR MUNICIPALITY PRIOR TO CONSTRUCTION.

TOP OF EXTERIOR FOUNDATION WALLS TO BE MIN 8" ABOVE FINISHED GRADE.

ALL GUARDRAILS TO BE 42" IN HEIGHT AND 4" VERTICAL SPACING . ALL GUARDRAILS MUST CONFORM TO ALL RELEVANT REQUIREMENT TO SECTION 9.8.8 OF THE B.C.B.C. 2024.

CONTRACTOR MUST VERIFY ALL SERVICE LINES PRIOR TO CONSTRUCTION.

FOOTINGS MUST PENETRATE BELOW FROST LINE AND BE ON SOLID BEARING.

EXPOSED SHEET METAL FLASHING SHALL BE OF GALVINIZED STEEL.

CAULKING AND FLASHING TO BE PROVIDED AS PER B.C.B.C. 2024.

**INSULATION AND VENTILATION** 

ATTIC ROOF SPACE SHALL BE VENTED WITH ROOF TYPE, EAVE TYPE AND/OR GABLE TYPE VENTS TO A MINIMUM OF 1:300 OF THE INSULATED CEILING AREA. ROOFS CONSTRUCTED WITH ROOF JOISTS SHALL BE VENTED TO A MINIMUM OF 1:150 OF THE INSULATED CEILING AREA.

VENTS SHALL BE UNIFORMLY PLACED AROUND THE BUILDING. CRAWLSPACES MAY ALSO BE HEATED BY A FORCED AIR HEATING SYSTEM OR VENTS TO AN ADJACENT BASEMENT AND SHALL BE VENTED TO ACCORDING TO SECTION 9.32 OF THE B.C.B.C. 2024.

CEILING INSULATION SHALL BE INSTALLED SO AS NOT TO RESTRICT AIR FLOW THROUGH ROOF VENTS TO ATTIC SPACES.

ATTIC SPACES AND CRAWLSPACES TO HAVE A MINIMUM 500x700 ACCESS HATCHWAY.

**MISCELLANEOUS** 

THE INSTALLATION OF PLUMBING, HEATING AND ELECTRICAL EQUIPMENT AND MATERIALS SHALL BE IN ACCORDANCE WITH MANUFACTURERS SPECIFICATIONS AND THE APPLICABLE SECTIONS OF THE B.C.B.C. STANDARDS.

ENGINEERED GLASS IS REQUIRED WHEN USED AS GUARD.

SCOUR PROTECTION PER SUBDIVISION REQUIREMENT. CONSTRACTOR'S RESPONSIBILITY TO CHECK WITH GEOTECH ENGINEER.

WINDOW IN STAIRWAY MUST PROVIDE MINIMUM 900 MM BETWEEN SILLANDADJACENT FLOOR, OTHER WISE MUST BE EITHER ENGINEERED OR GUAR DED FROM INSIDE.



B500 - 20020 84 AVENUE, LANGLEY, BC EMAIL: INFO@JOSSDESIGN.CA TEL : 778 323-8873

DRAWN JS SEPTEMBER 4, 2024\_BP 3717 LINCOLN AVENUE, COQUITLAM

PROJECT SCALE 1/8"=1'-0"

**KEY PLAN, SITE PLAN &** NOTES

DRAWING TITLE

## 3D VIFW


	3D VIEW
	KEY PLAN, SITE PLAN & NOTES
	FRONT (SOUTH) ELEVATION
	LEFT (WEST) ELEVATION
	REAR (NORTH) ELEVATION
	RIGHT (EAST) ELEVATION
	ROOF PLAN
	UPPER FLOOR PLAN
	MAIN FLOOR PLAN
	FOUNDATION FLOOR PLAN
)	SECTION 1 & DETAILS
	SECTION 2 & DETAILS
2	SECTION 3 & DETAILS

DRAWING TITLE

CONSTRUCTION DETAILS

A1



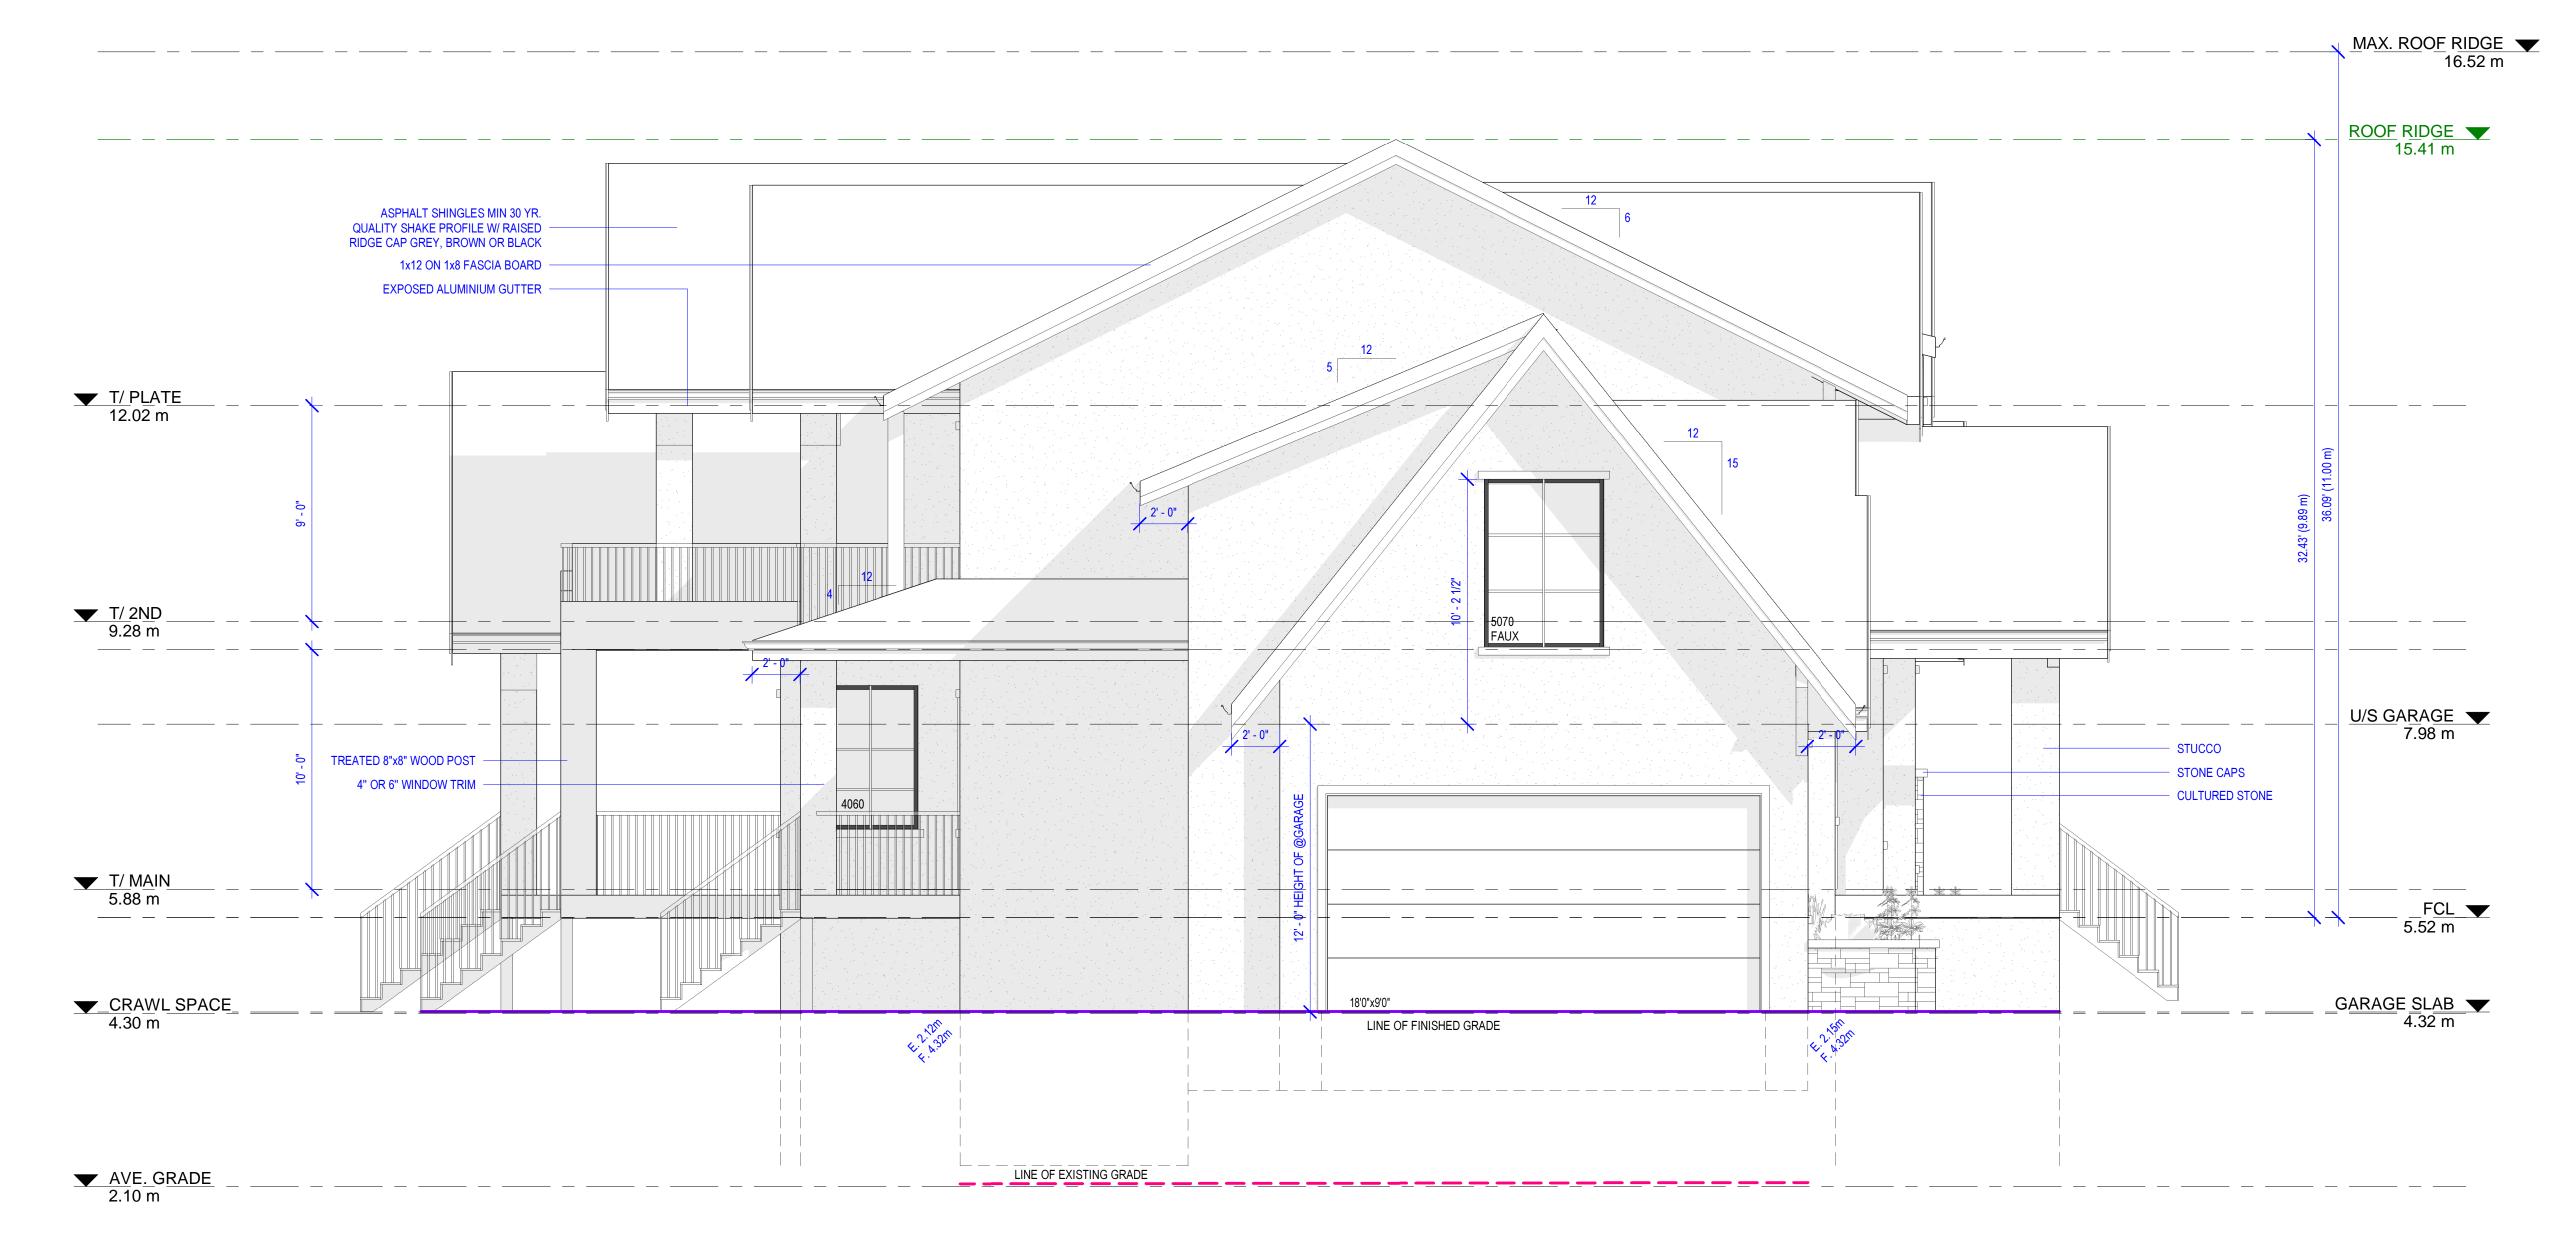

## <u>LEFT (WEST) ELEVATION</u>

## THESE PLANS CONFORM TO THE THE B.C. BUILDING CODE 2024

A3

DRAWING TITLE

SHEET NUMBER

ELEVATION

SCALE 1/4"=1'-0" LEFT (WEST)

PROJECT

COQUITLAM

3717 LINCOLN AVENUE,

DRAWN JS SEPTEMBER 4, 2024\_BP

B500 - 20020 84 AVENUE, LANGLEY, BC EMAIL: INFO@JOSSDESIGN.CA TEL : 778 323-8873








Attachment 1, Page 4 of 13



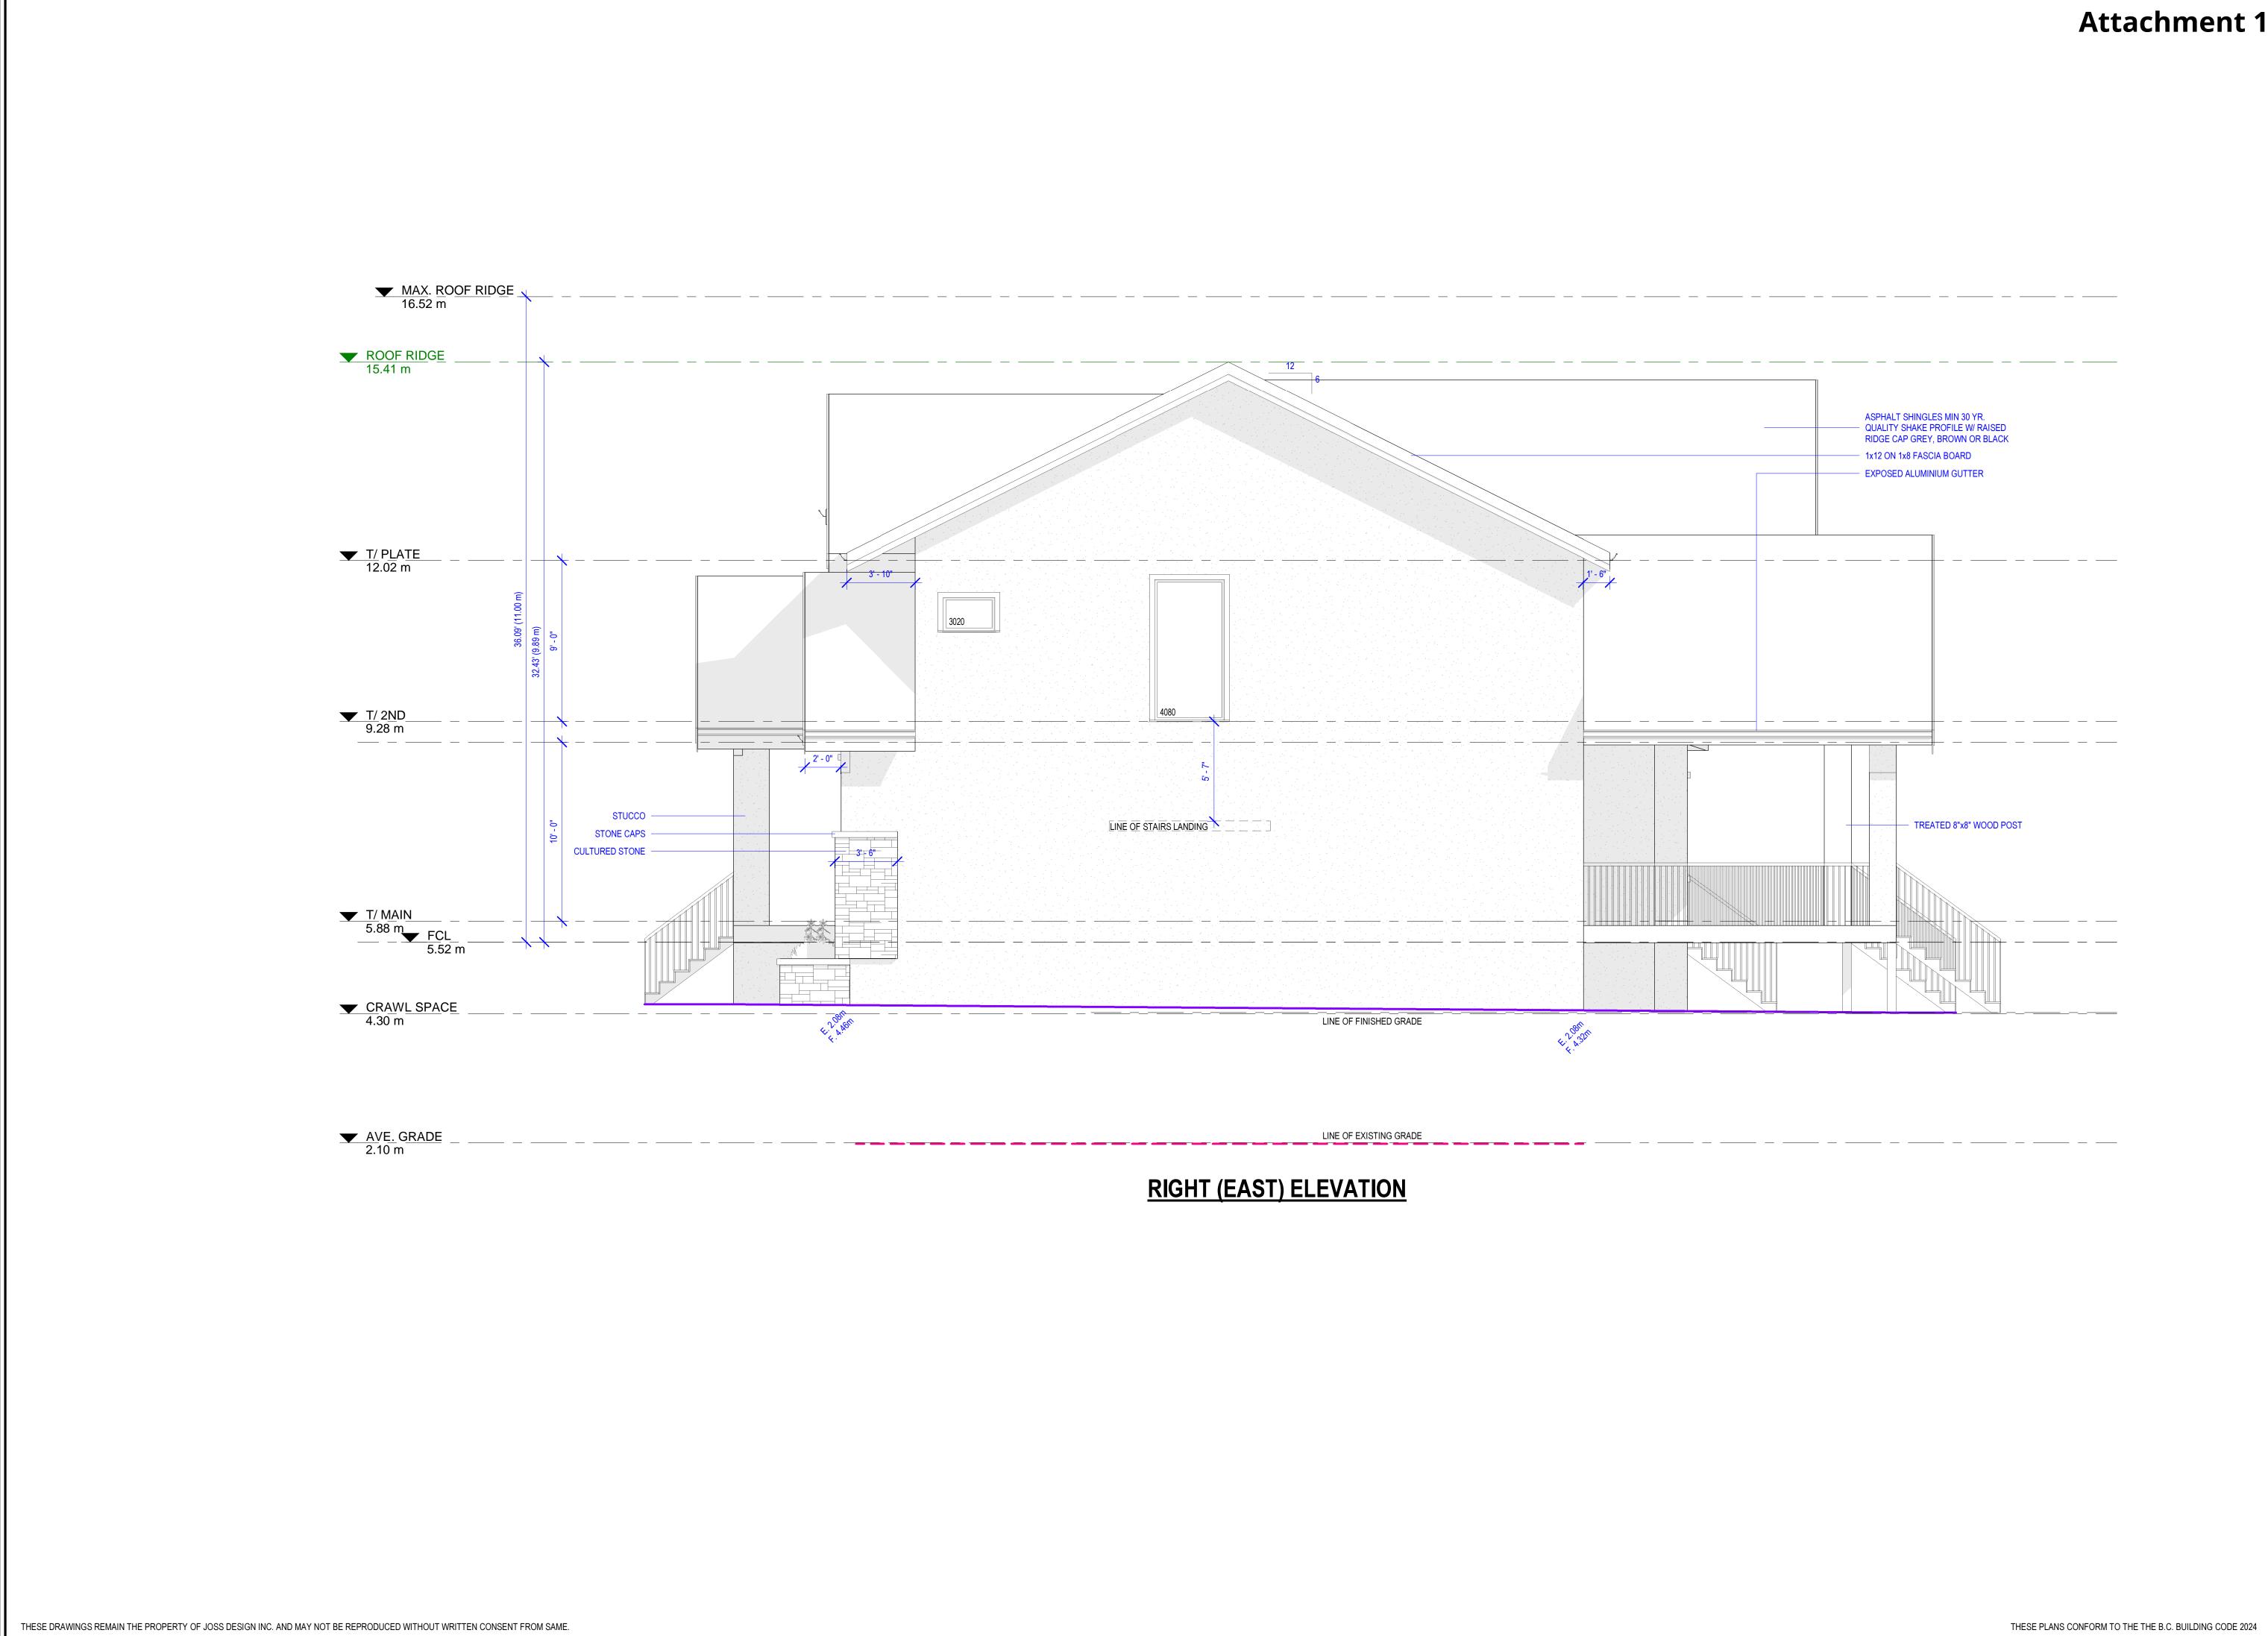

# Attachment 1, Page 6 of 13



DRAWN JS SEPTEMBER 4, 2024\_BP 3717 LINCOLN AVENUE, COQUITLAM

A5

PROJECT

SCALE 1/4"=1'-0"


RIGHT (EAST)

ELEVATION

DRAWING TITLE

SHEET NUMBER

B500 - 20020 84 AVENUE, LANGLEY, BC EMAIL: INFO@JOSSDESIGN.CA TEL : 778 323-8873

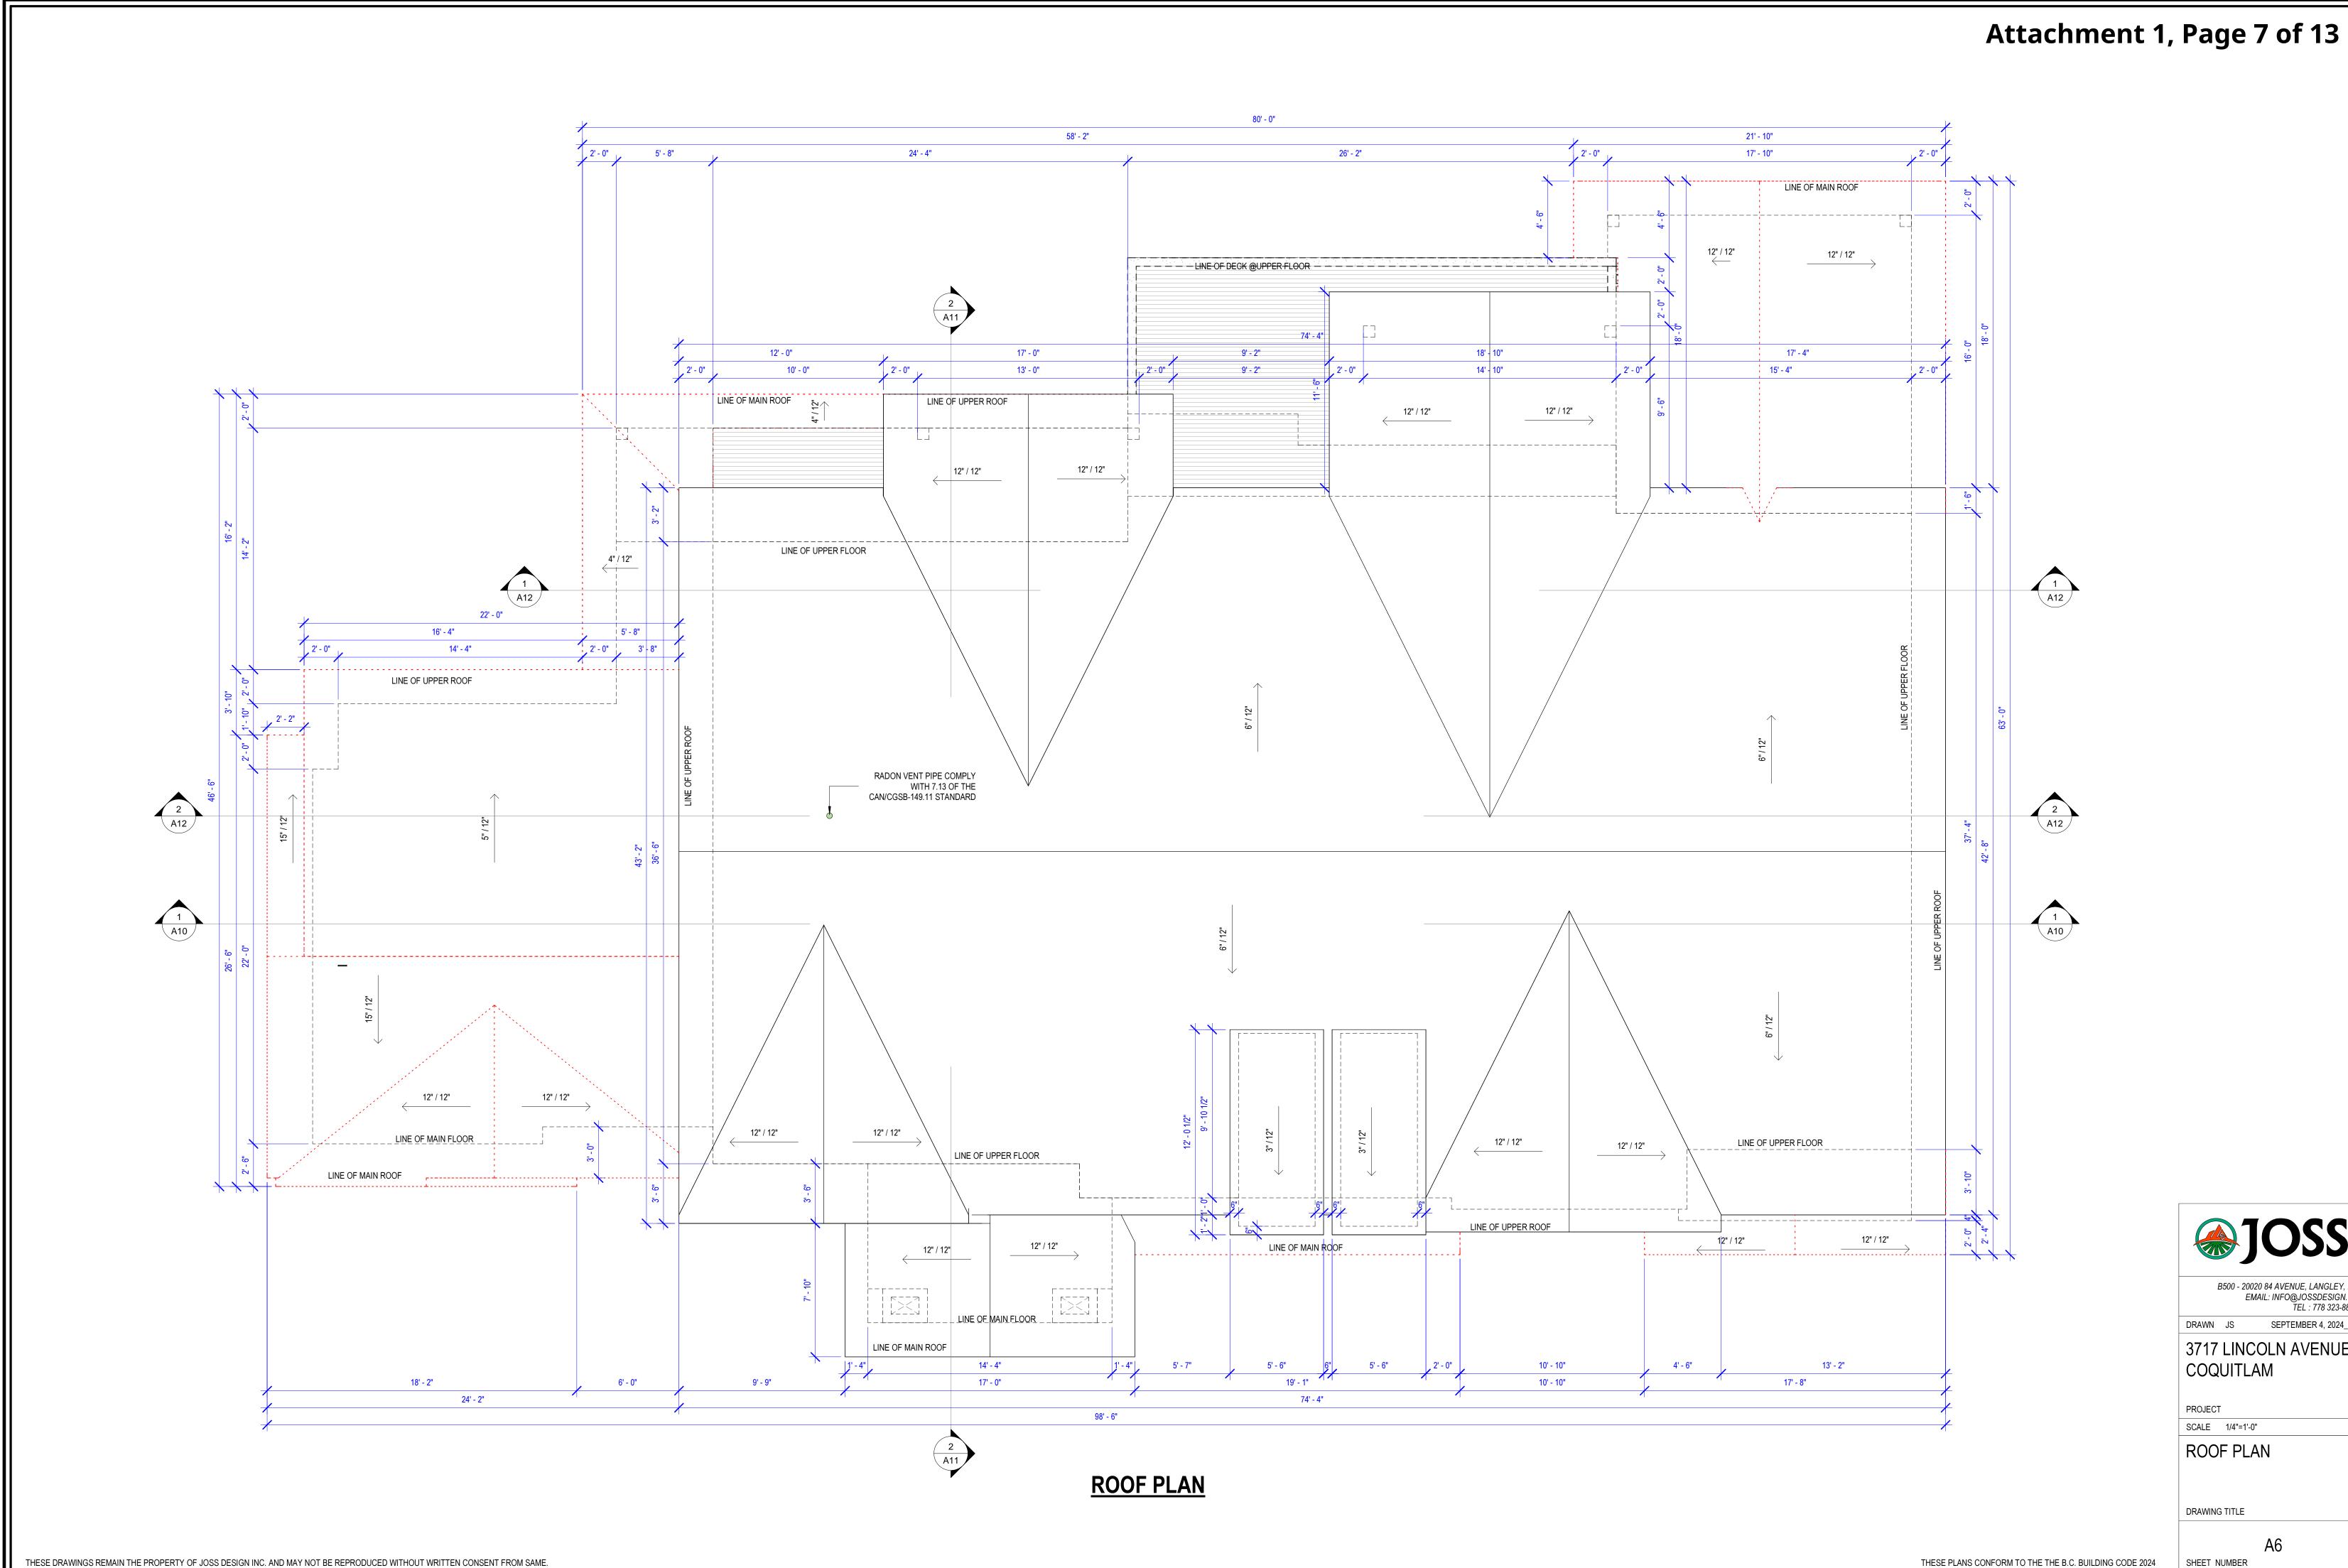

## THESE PLANS CONFORM TO THE THE B.C. BUILDING CODE 2024

SHEET NUMBER

DRAWING TITLE

ROOF PLAN

PROJECT SCALE 1/4"=1'-0"


COQUITLAM

# 3717 LINCOLN AVENUE,

A6

B500 - 20020 84 AVENUE, LANGLEY, BC EMAIL: INFO@JOSSDESIGN.CA TEL : 778 323-8873 DRAWN JS SEPTEMBER 4, 2024\_BP



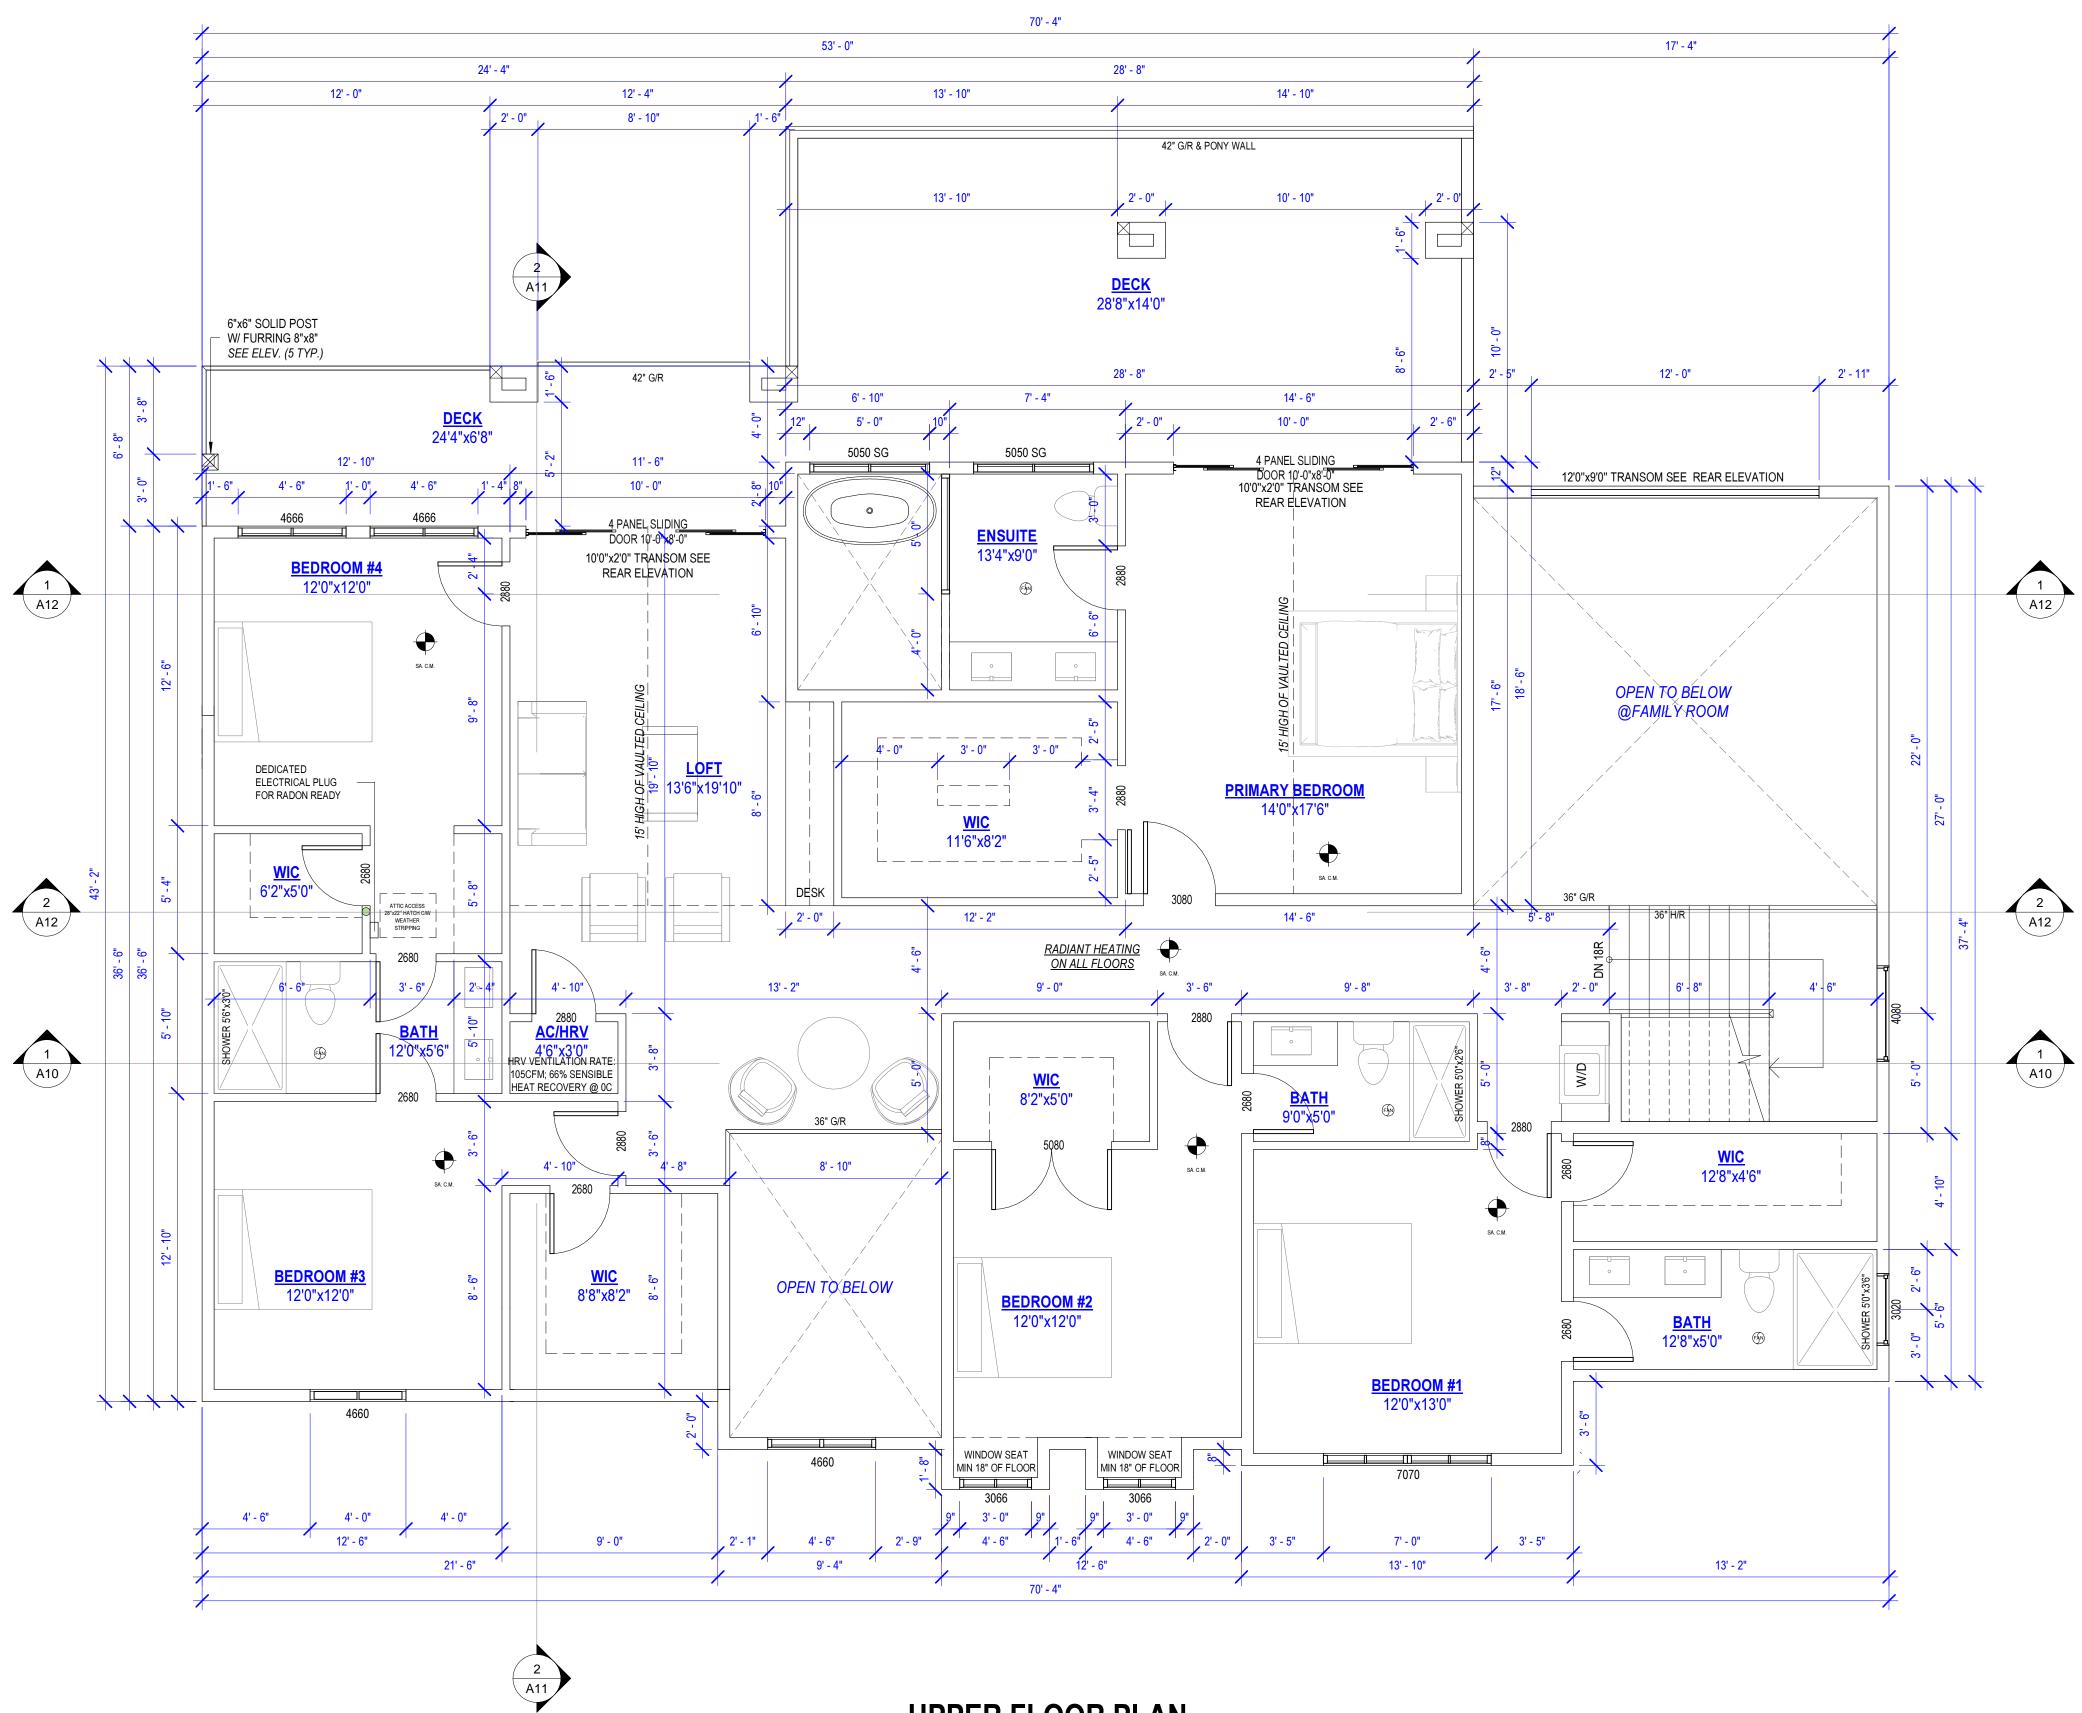

UPPER FLOOR AREA = 2246.25 SF - STAIRS AREA = 99.18 SF - DECK AREA = 563.58 SF

## THESE PLANS CONFORM TO THE THE B.C. BUILDING CODE 2024

SHEET NUMBER

DRAWING TITLE

UPPER FLOOR PLAN

A7

PROJECT SCALE 1/4"=1'-0"


## COQUITLAM

DRAWN JS SEPTEMBER 4, 2024\_BP

B500 - 20020 84 AVENUE, LANGLEY, BC EMAIL: INFO@JOSSDESIGN.CA TEL : 778 323-8873



# Attachment 1, Page 8 of 13

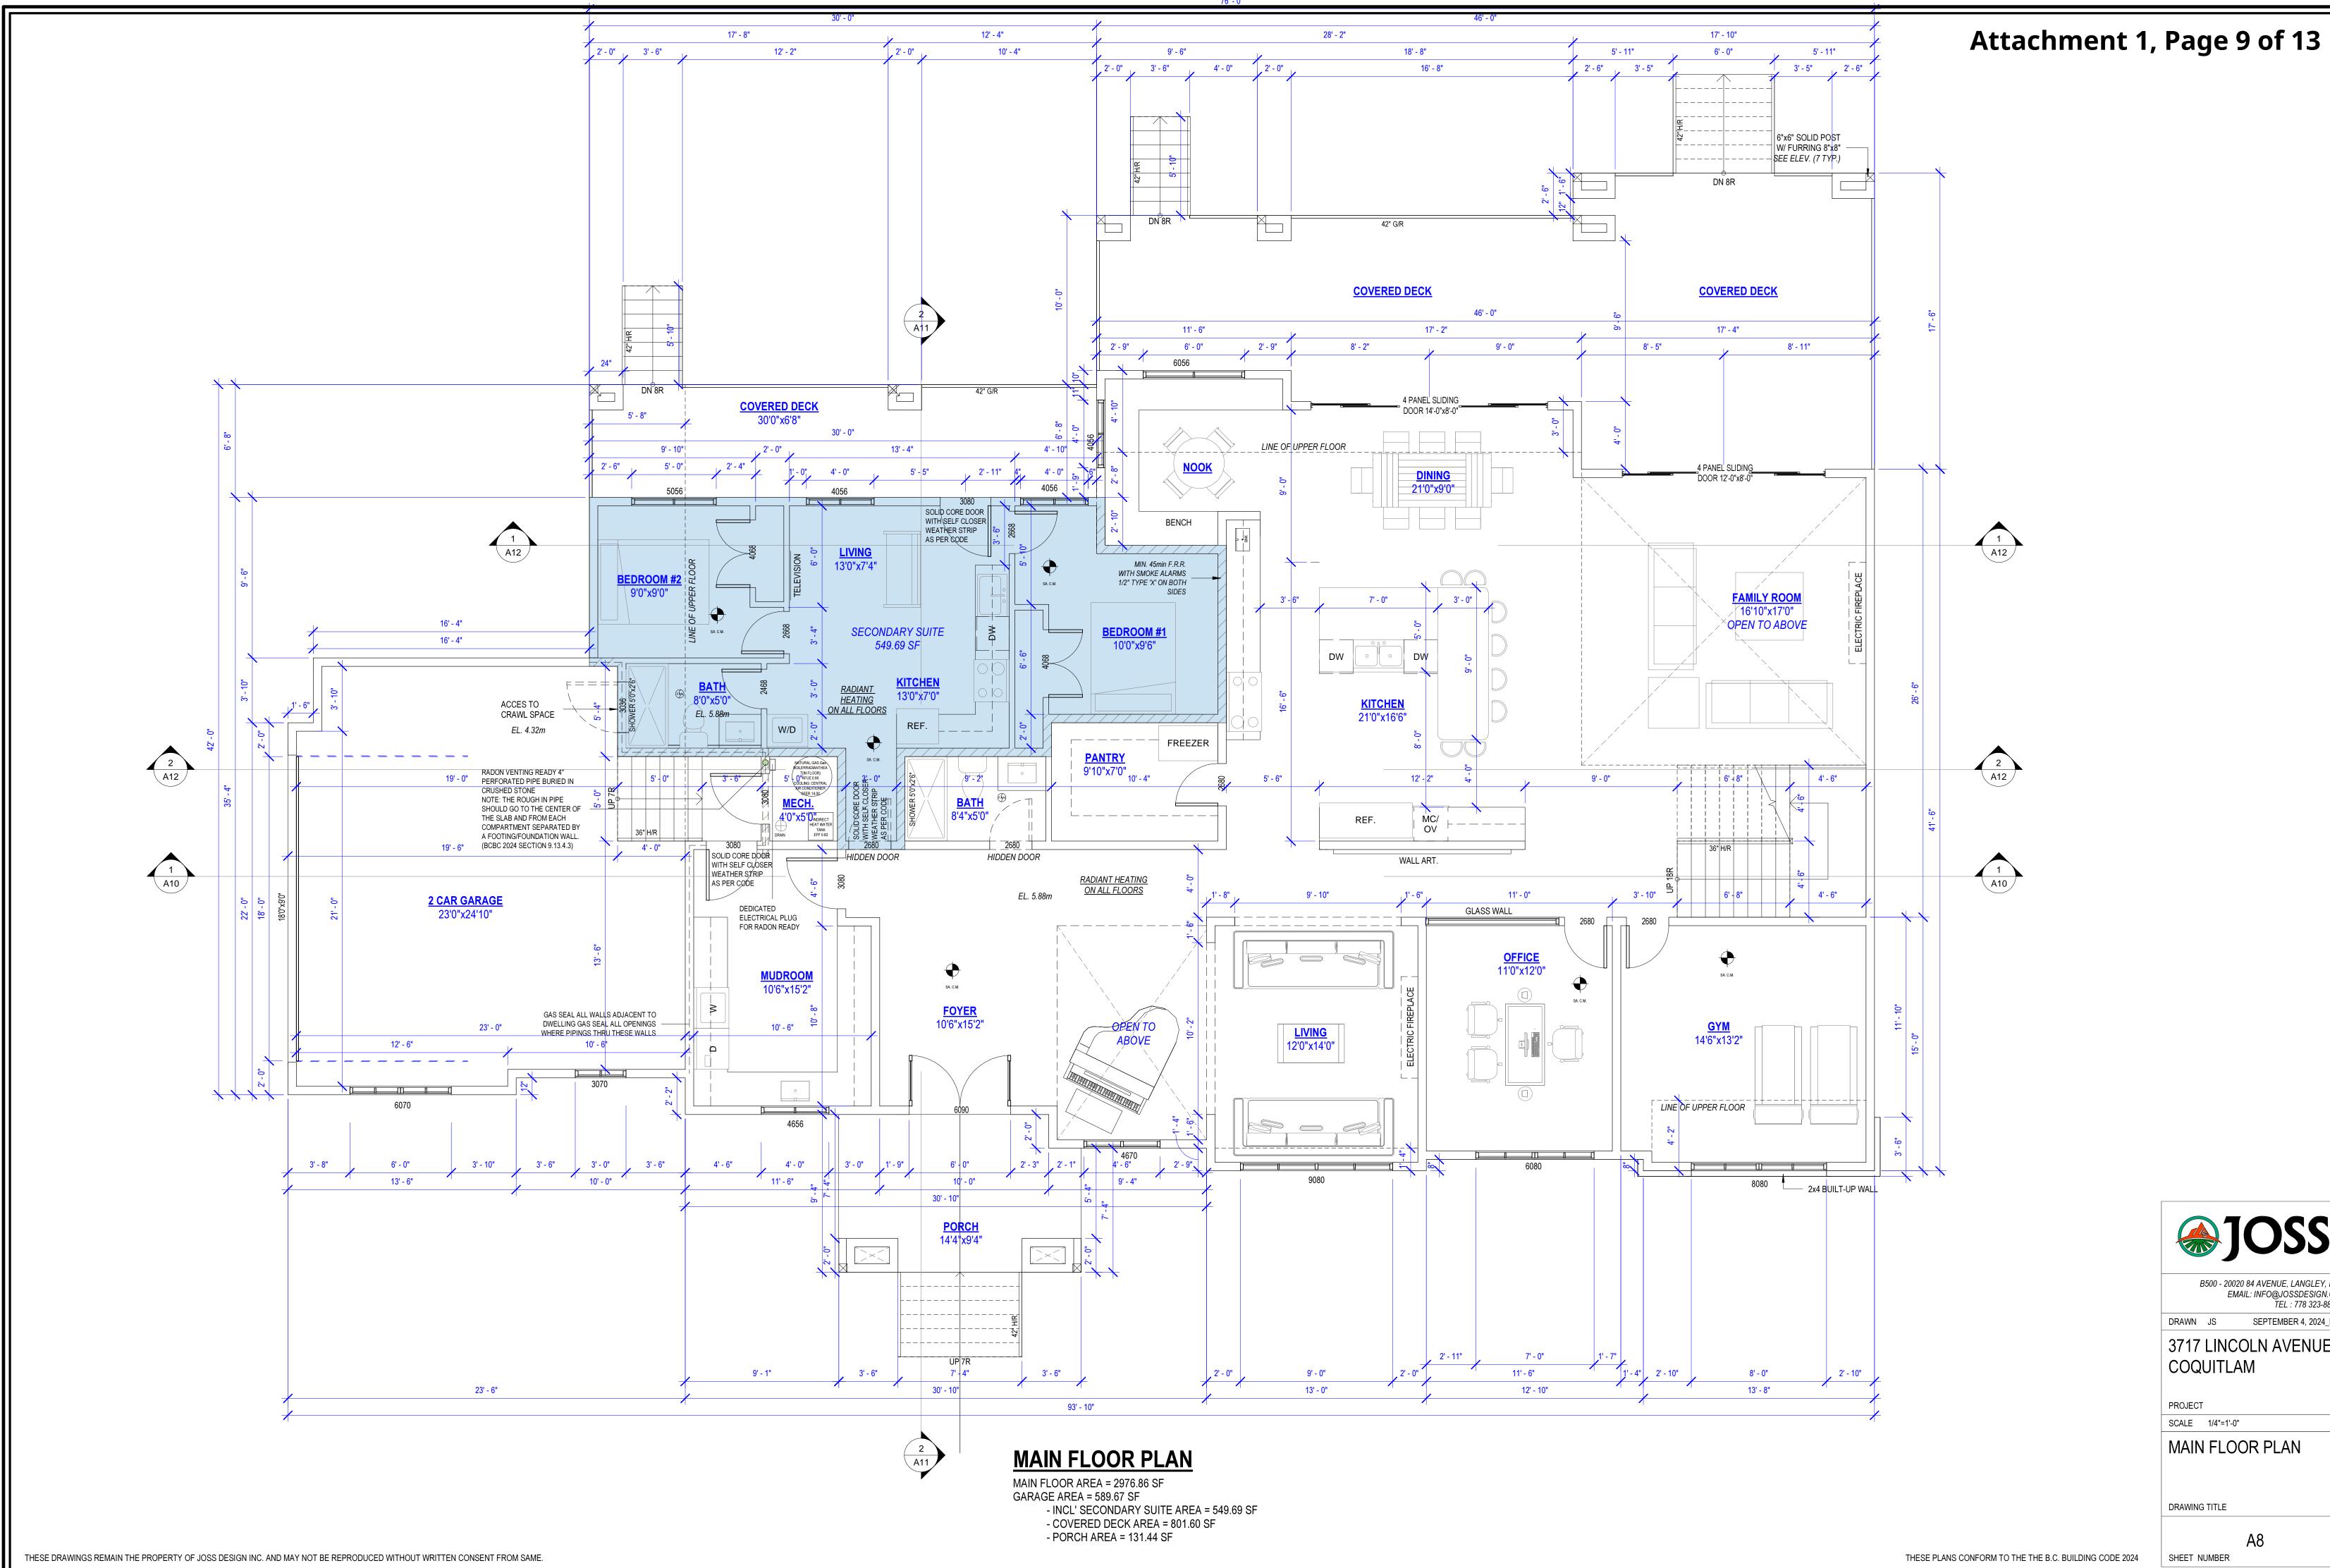

SHEET NUMBER

DRAWING TITLE

## MAIN FLOOR PLAN

A8

PROJECT SCALE 1/4"=1'-0"


## COQUITLAM

# 3717 LINCOLN AVENUE,

B500 - 20020 84 AVENUE, LANGLEY, BC EMAIL: INFO@JOSSDESIGN.CA TEL : 778 323-8873 DRAWN JS SEPTEMBER 4, 2024\_BP





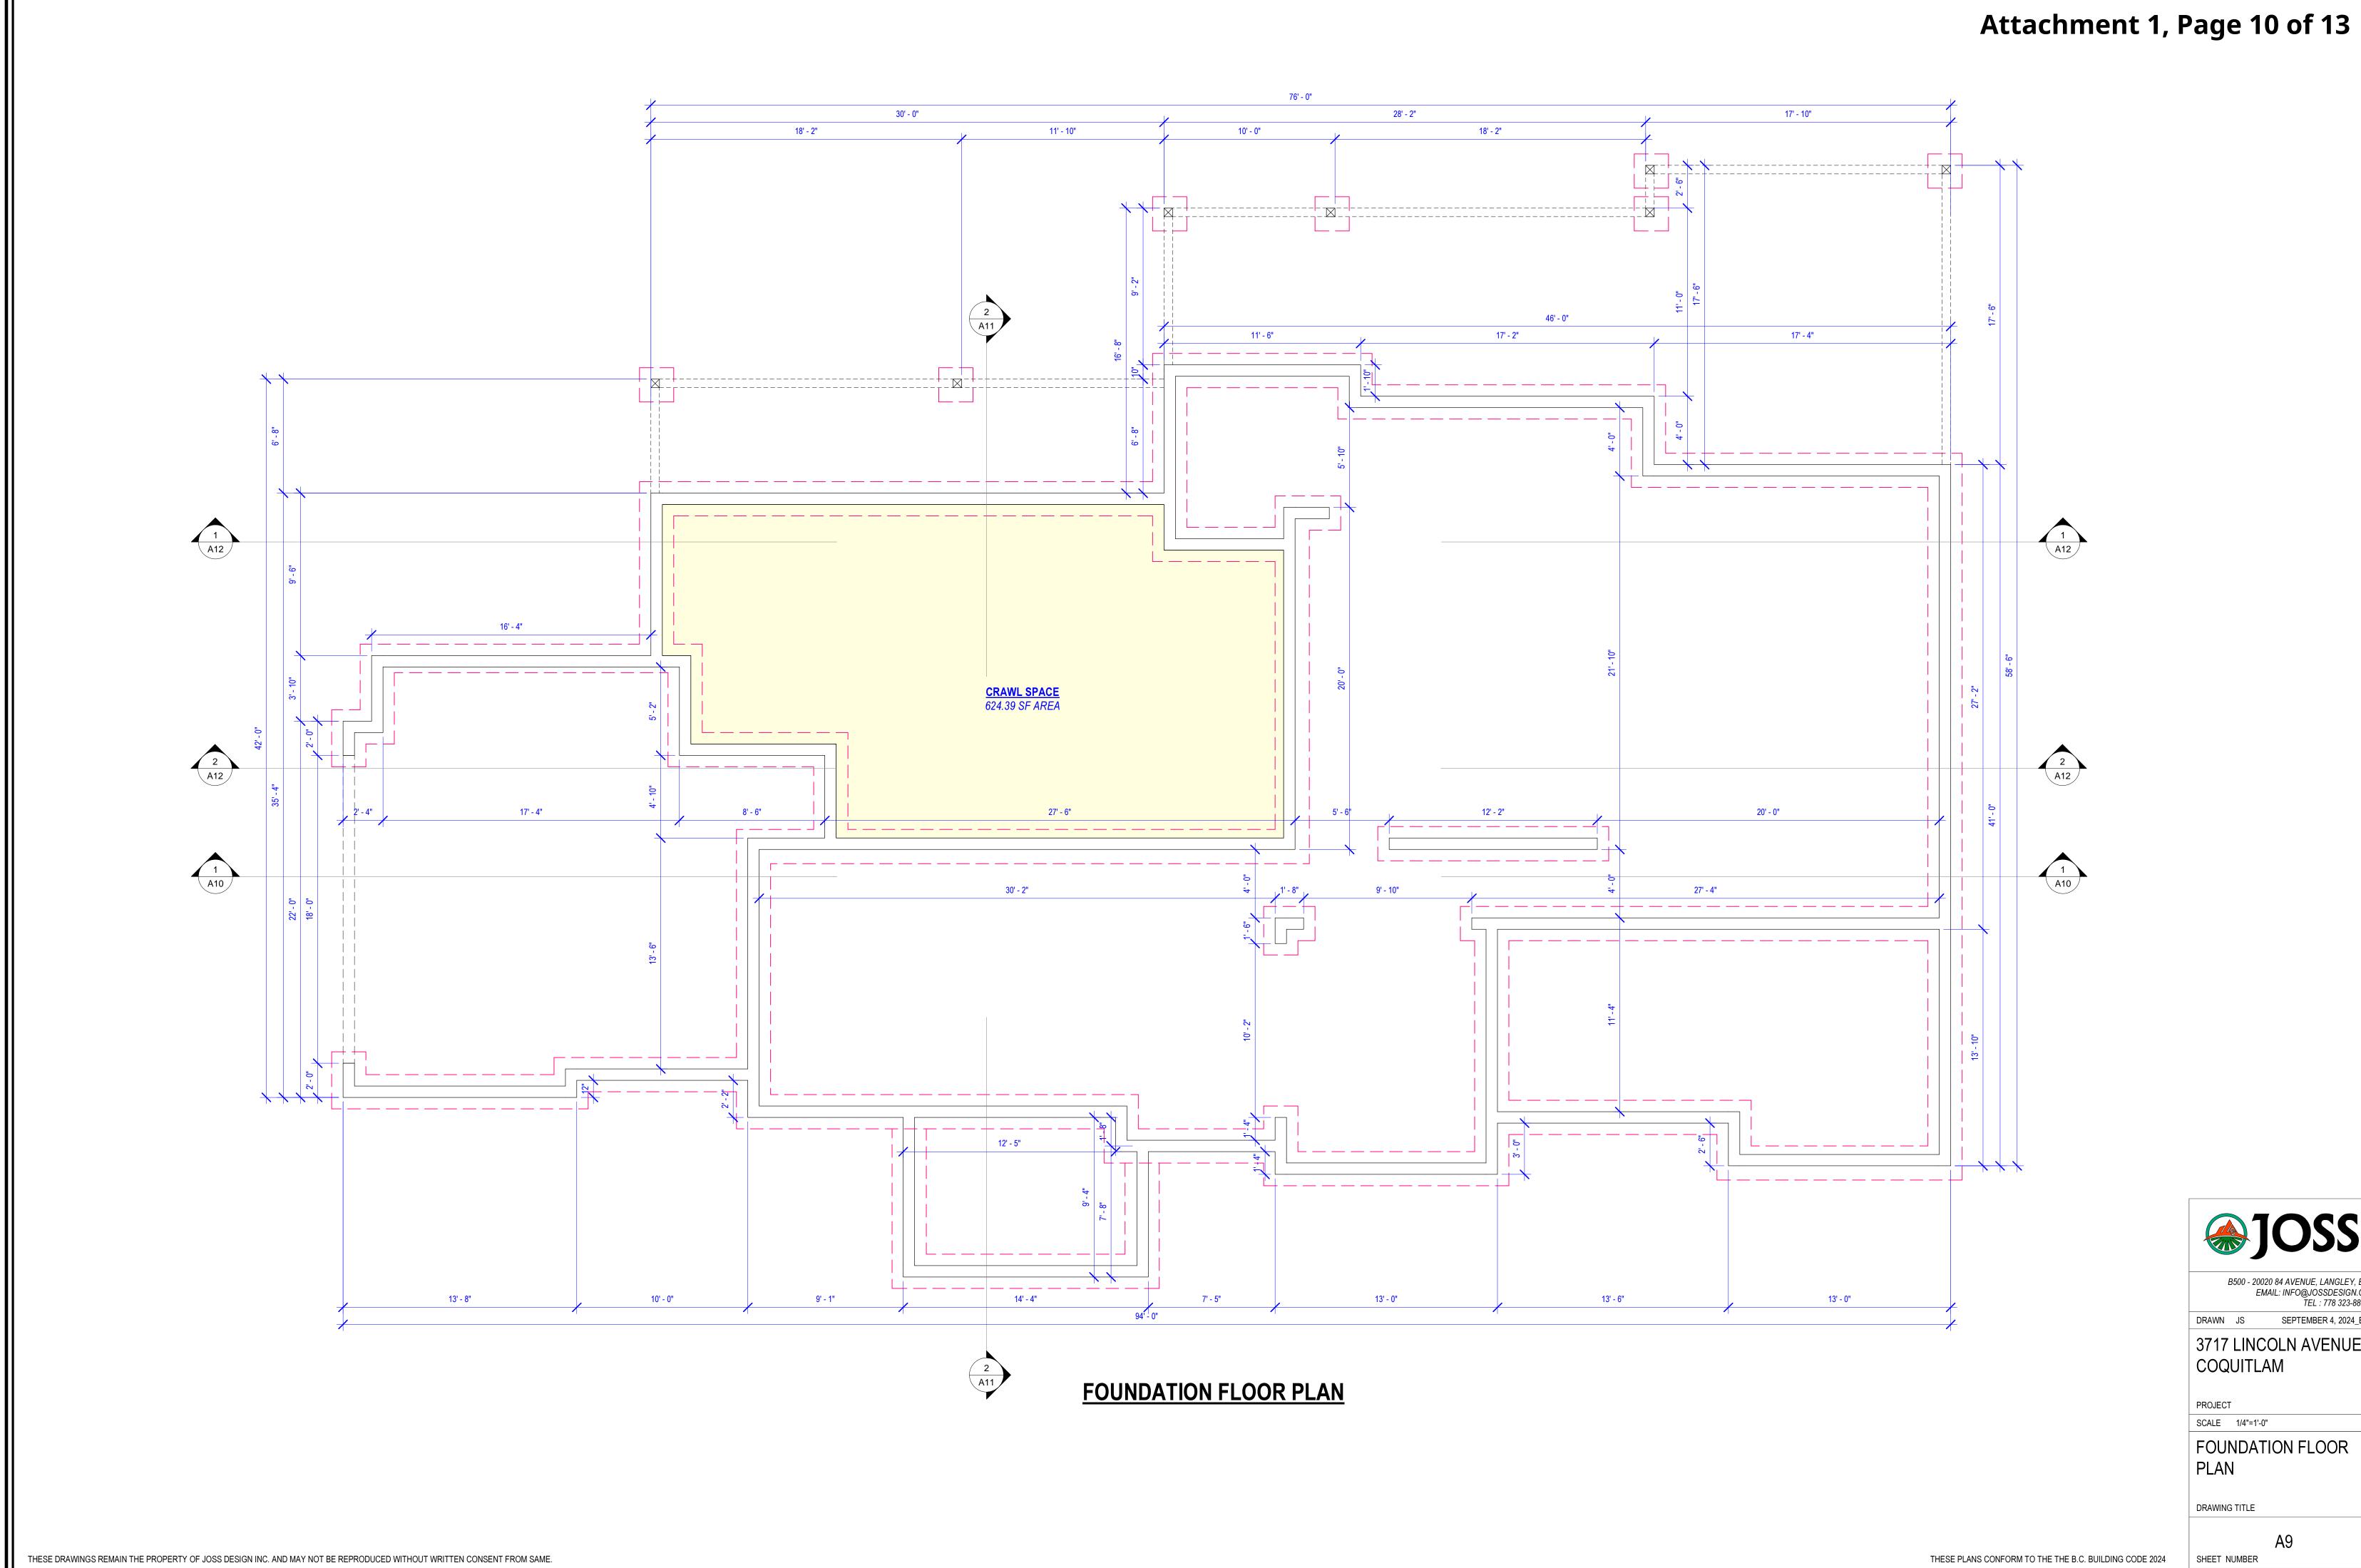



SHEET NUMBER

DRAWING TITLE

## SCALE 1/4"=1'-0" FOUNDATION FLOOR PLAN

A9


PROJECT

# COQUITLAM

DRAWN JS SEPTEMBER 4, 2024\_BP 3717 LINCOLN AVENUE,


B500 - 20020 84 AVENUE, LANGLEY, BC EMAIL: INFO@JOSSDESIGN.CA TEL : 778 323-8873




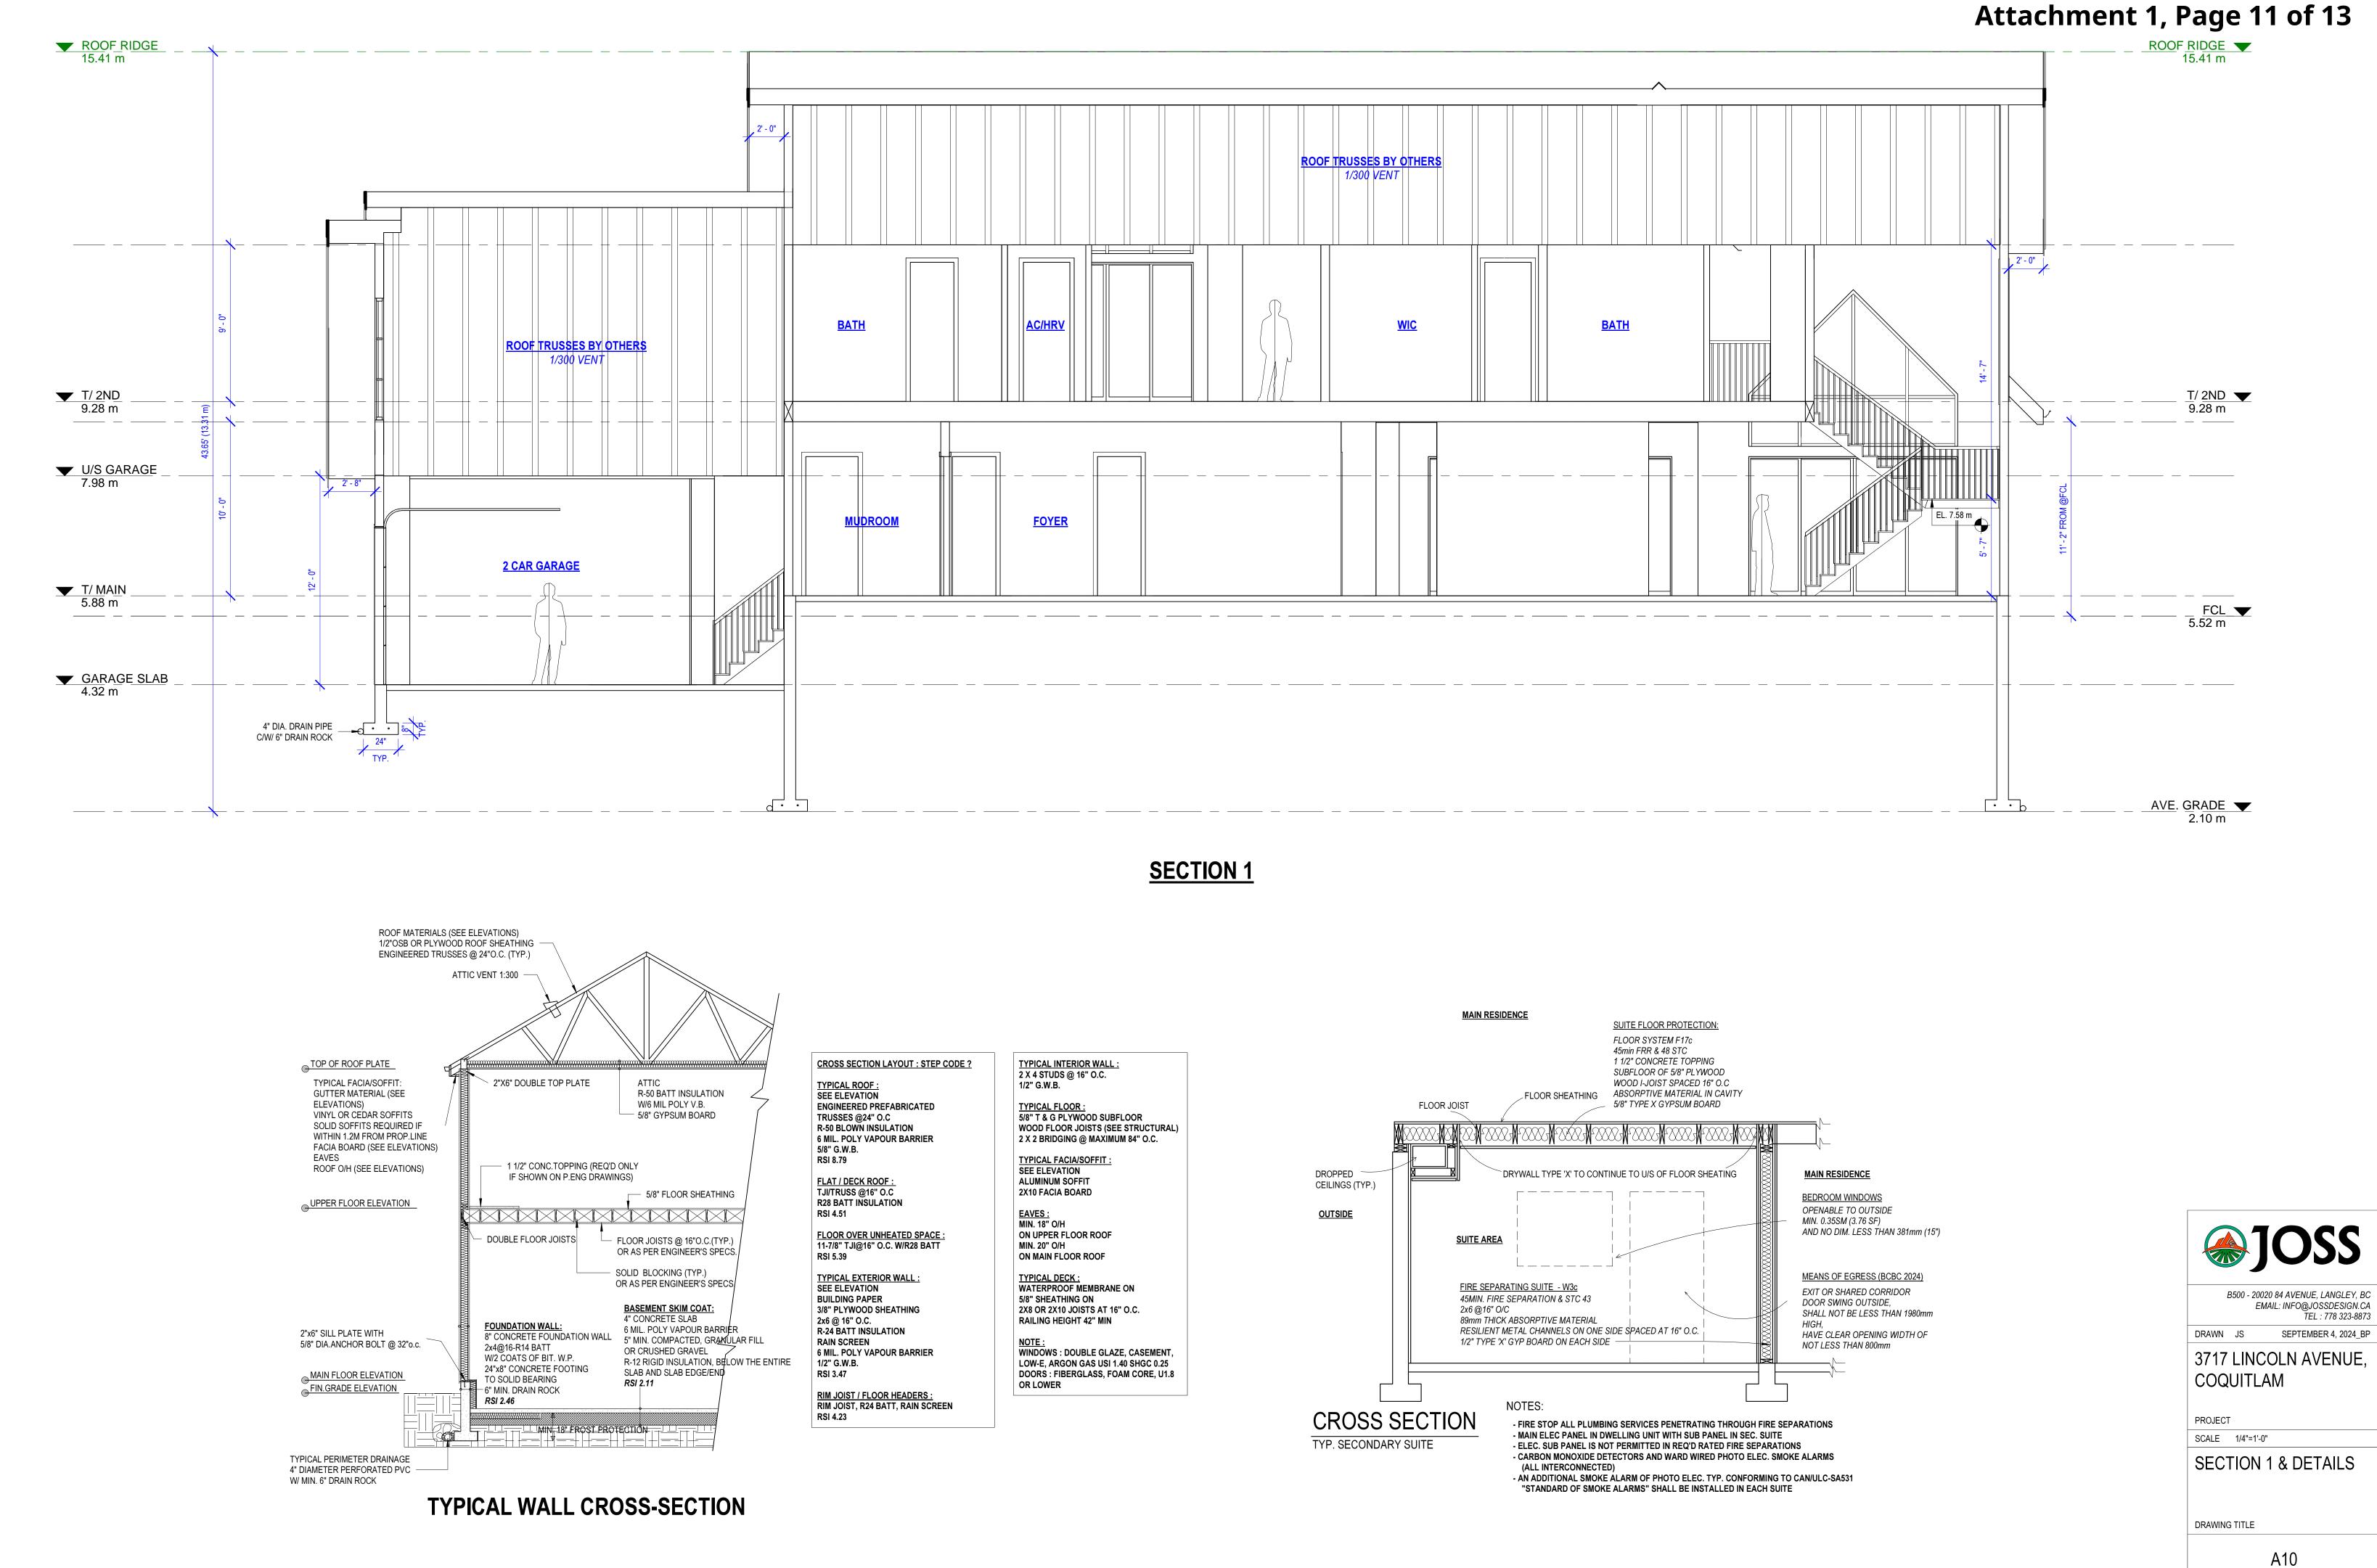

THESE PLANS CONFORM TO THE THE B.C. BUILDING CODE 2024

SHEET NUMBER

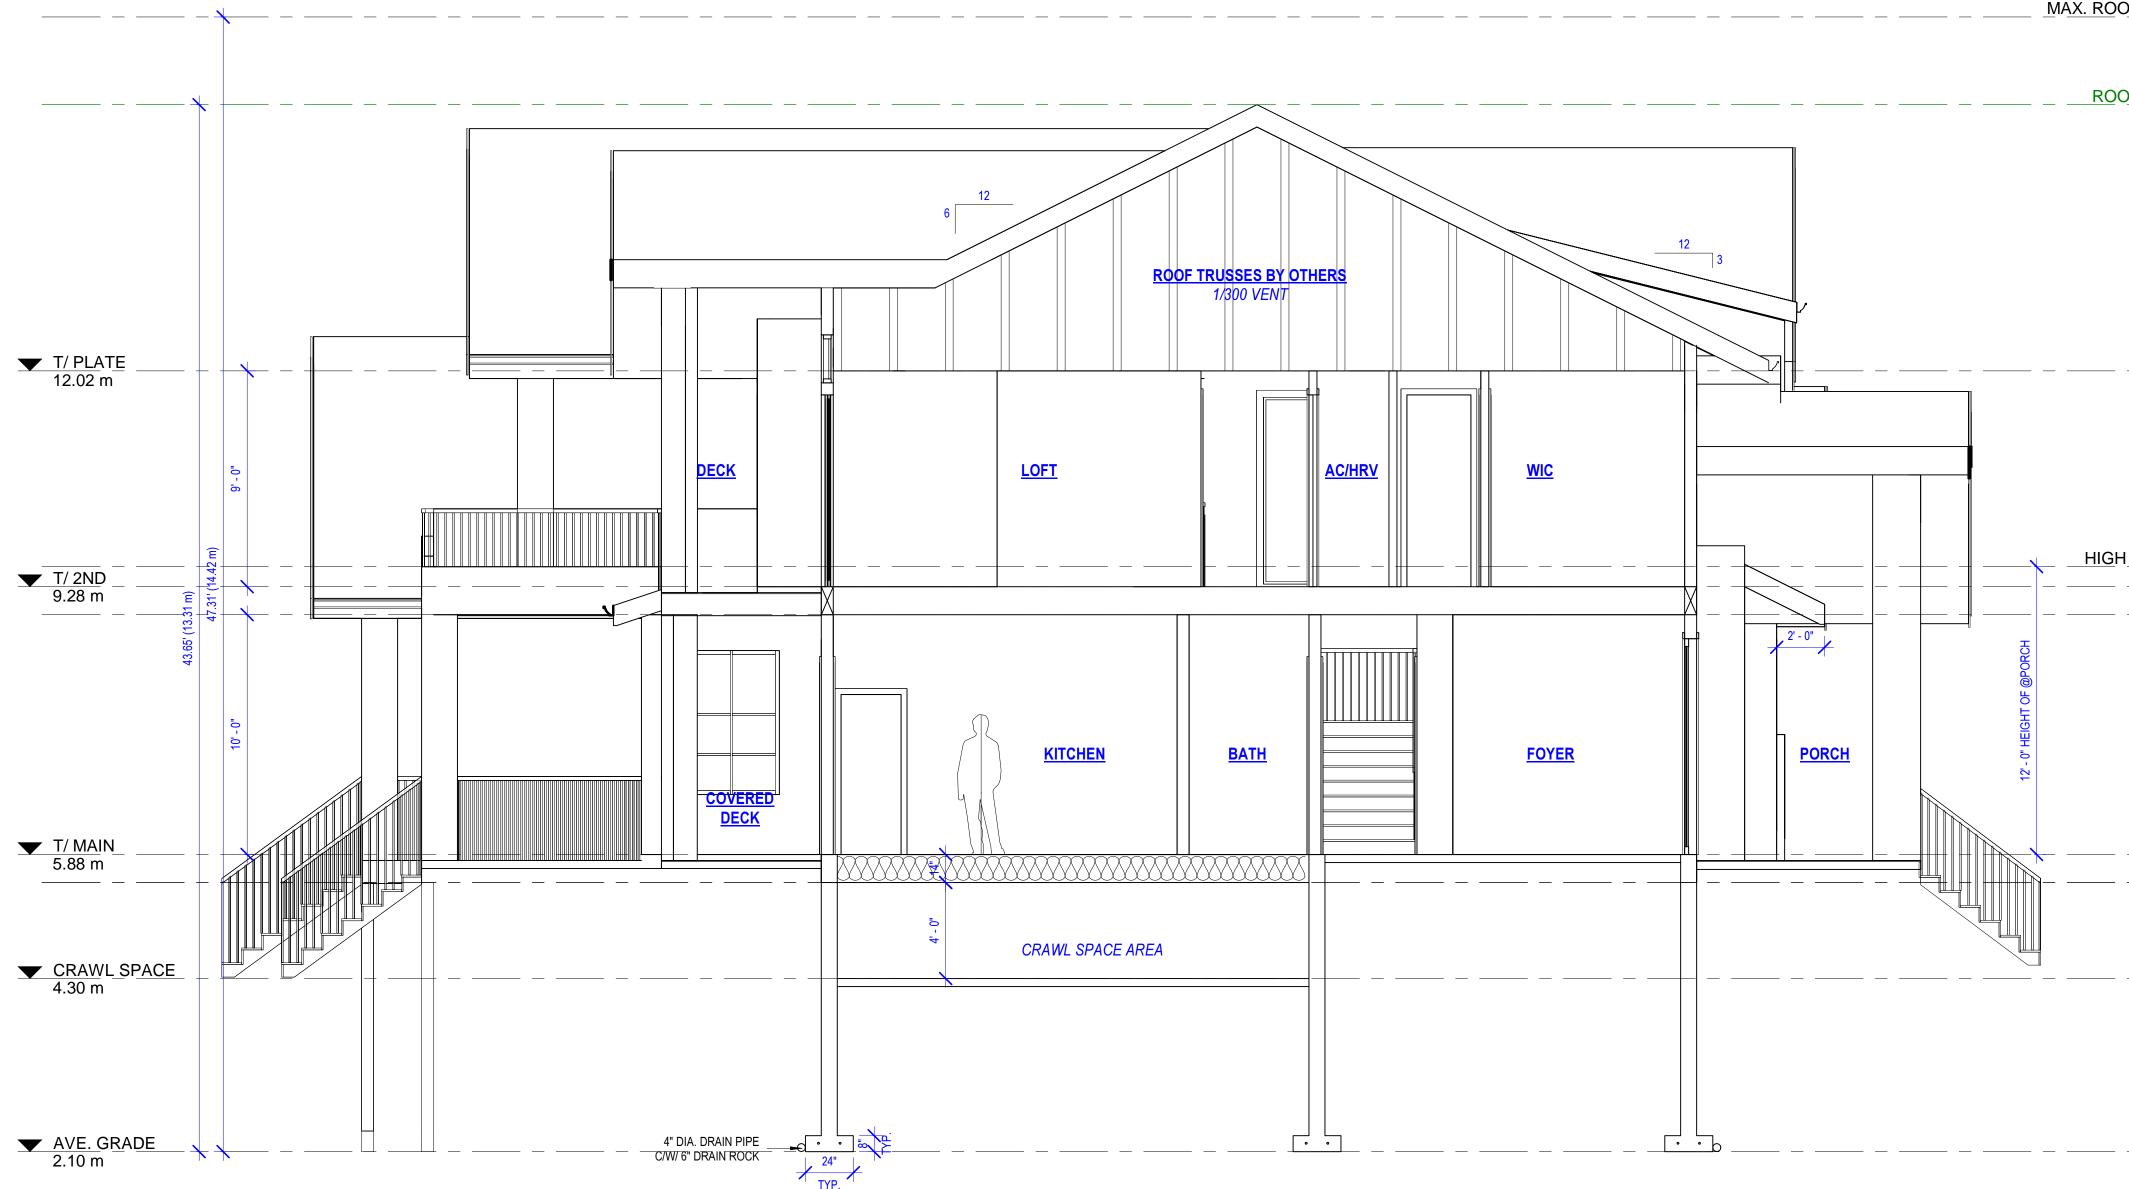

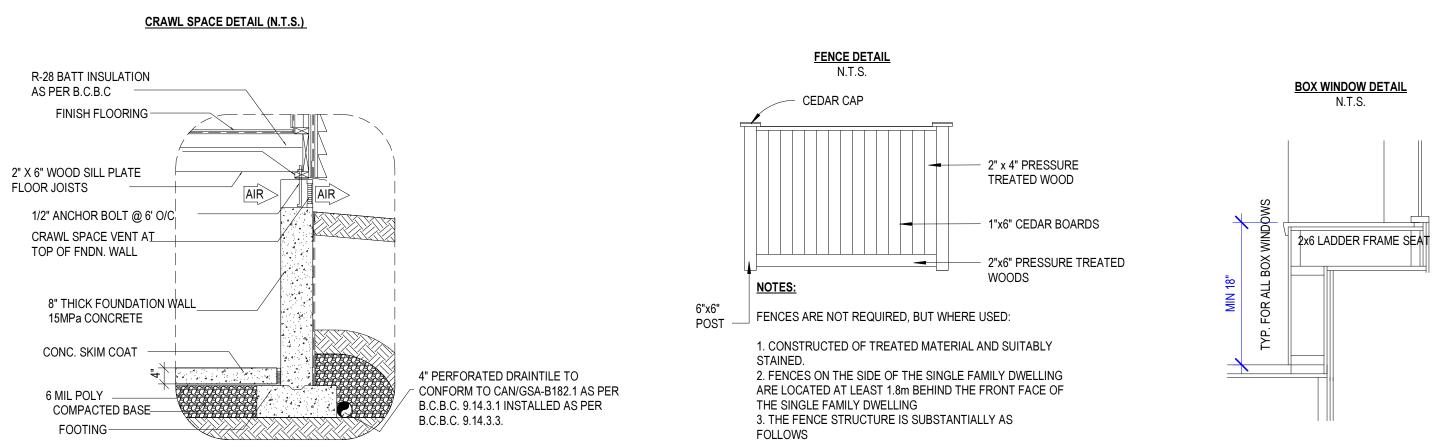

## **SECTION 2**

SHEET NUMBER

DRAWING TITLE

SECTION 2 & DETAILS

A11

PROJECT SCALE 1/4"=1'-0"

COQUITLAM

# 3717 LINCOLN AVENUE,

B500 - 20020 84 AVENUE, LANGLEY, BC EMAIL: INFO@JOSSDESIGN.CA TEL : 778 323-8873 DRAWN JS SEPTEMBER 4, 2024\_BP

HIGH CEILING 9.53 m FCL 5.52 m  $\square$ \_\_\_\_\_




2x12 STRINGER 10" 1" NOSING


SPINDLES OF HANDRAIL TO EXTEND DOWN TO TREAD SHOE

└─ 7.875" RISE

- 1" PLYWOOD TREADS

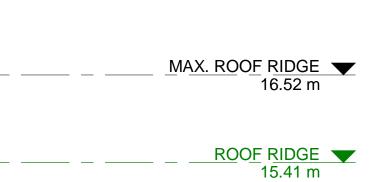



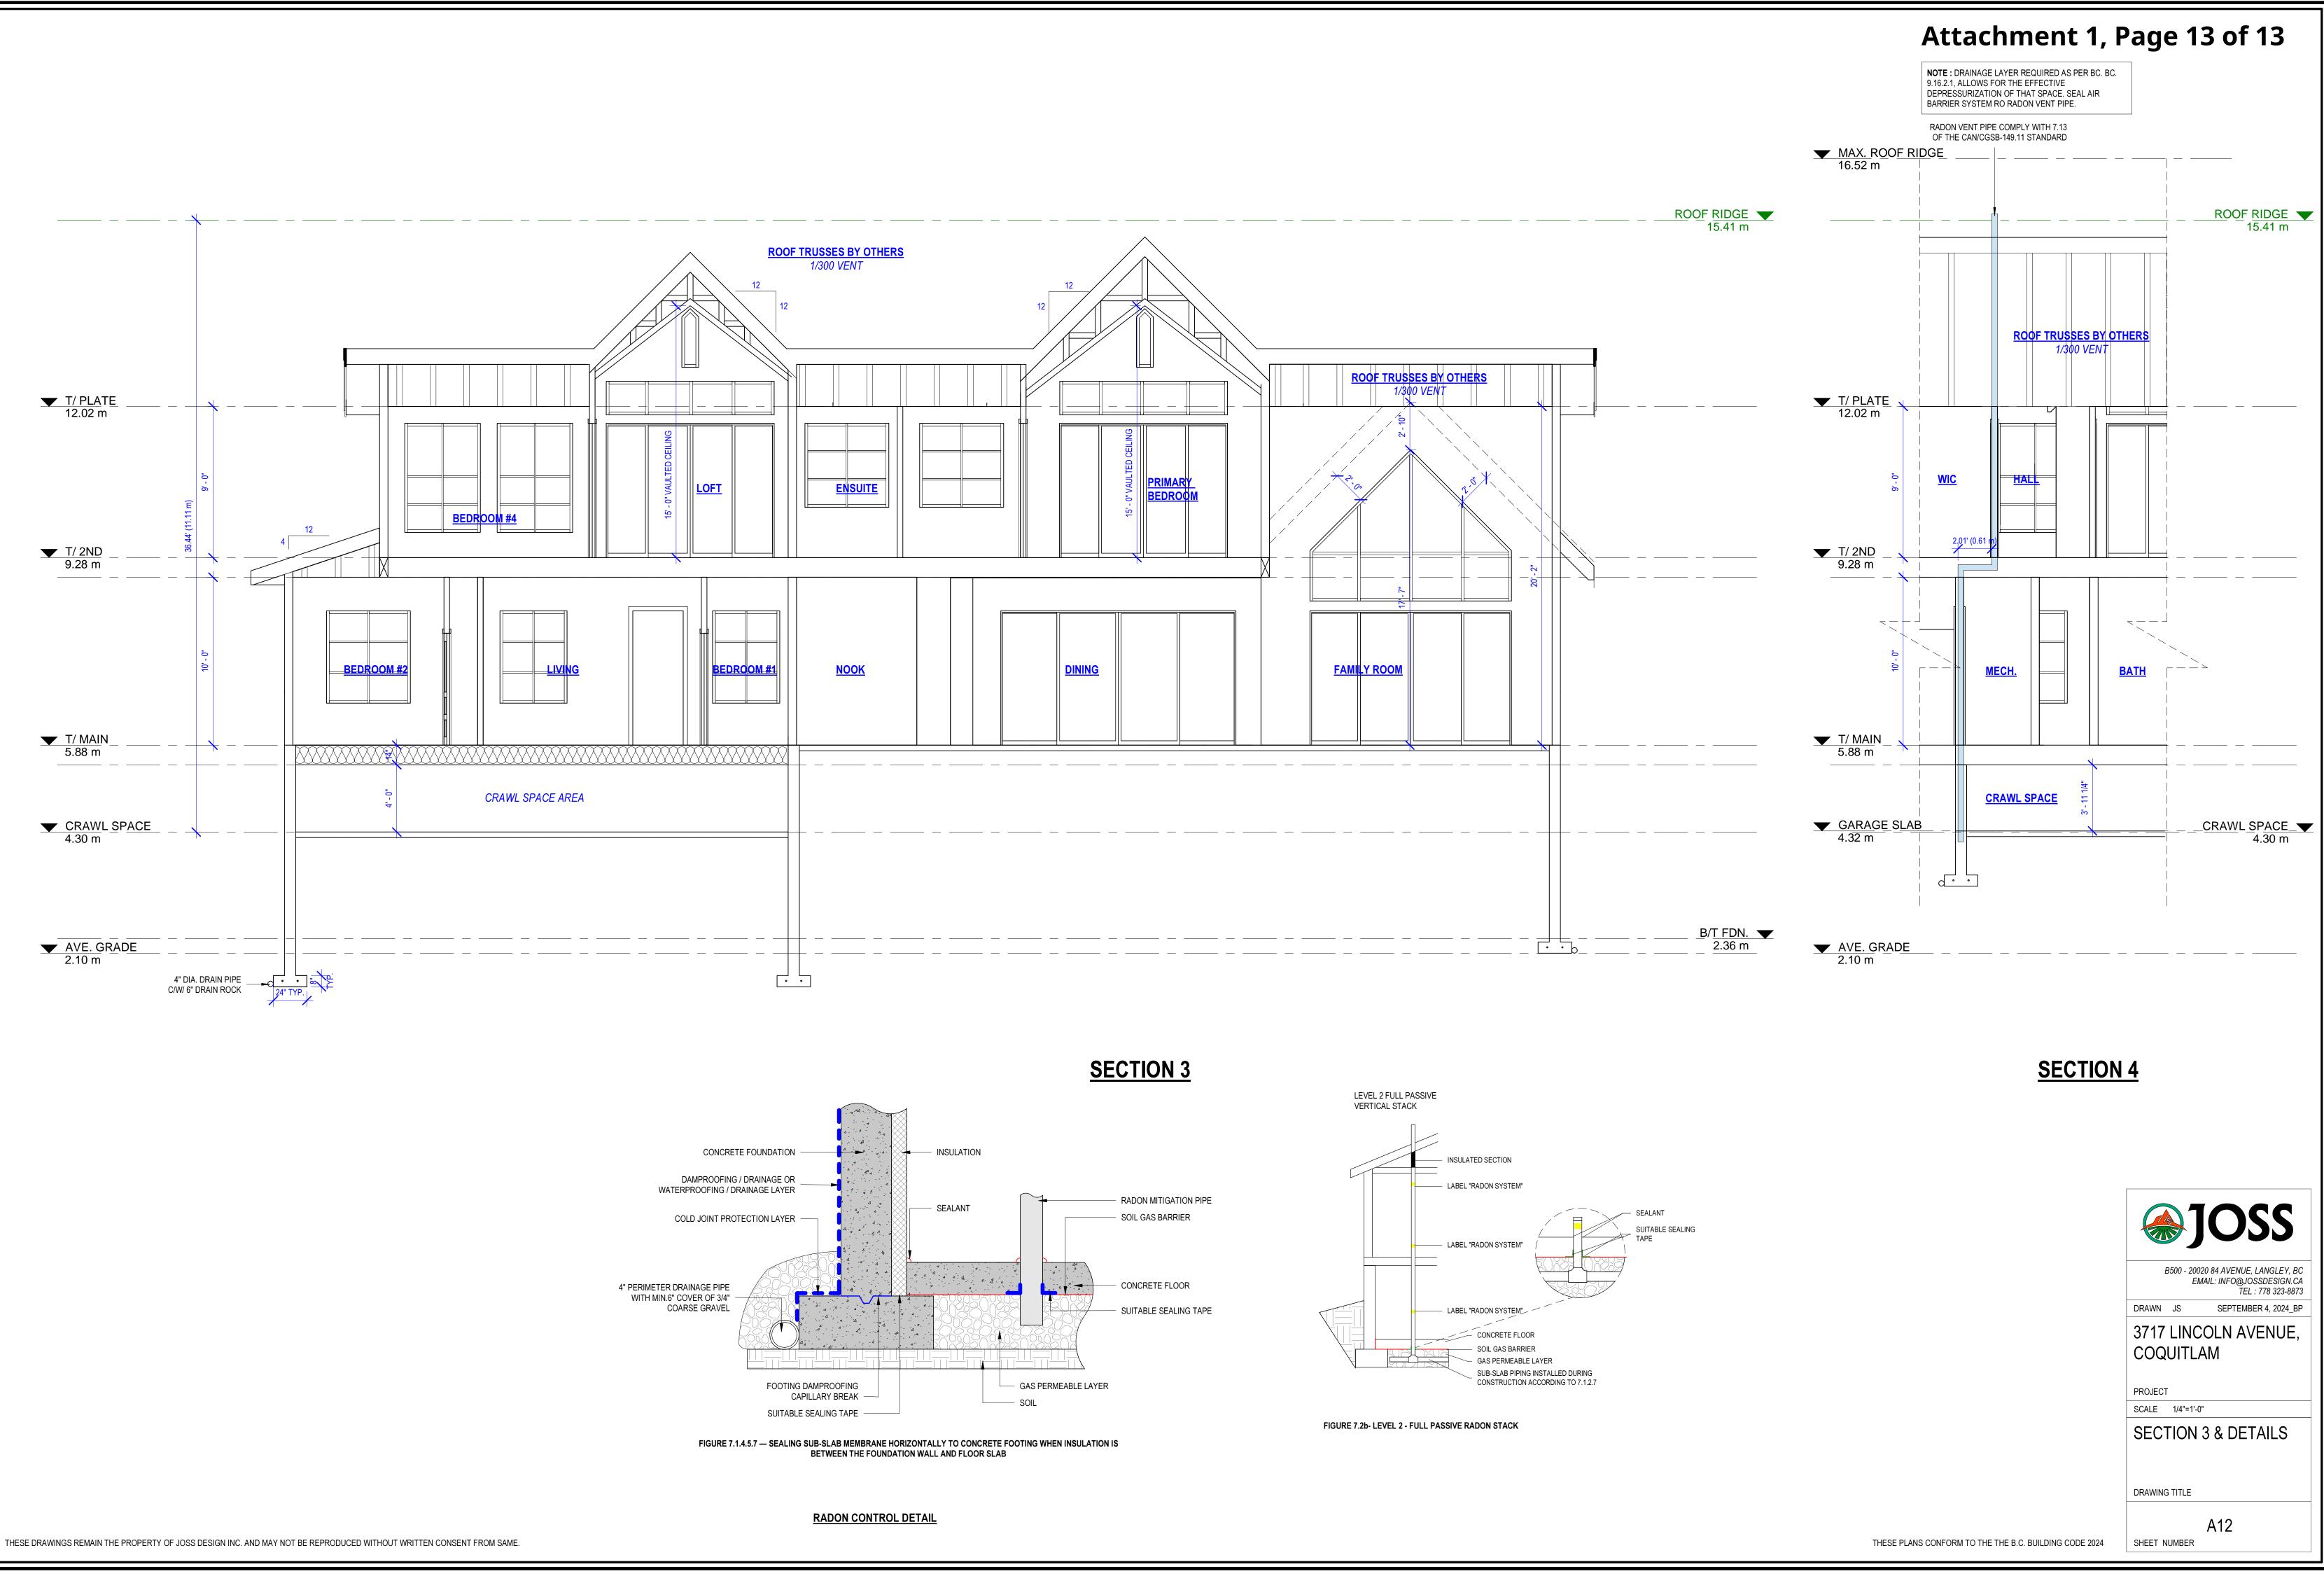

## 3717 Lincoln Ave OCP Land Use Designation


## Attachment 2

Coouitlam




Map Printed 2/5/2025	0	0.2	0.4 km	
The City of Coquitia m a ssum es no responsibility with respect to the accuracy, completeness or appropriateness of information shown.		1:9,028		North

## Attachment 3

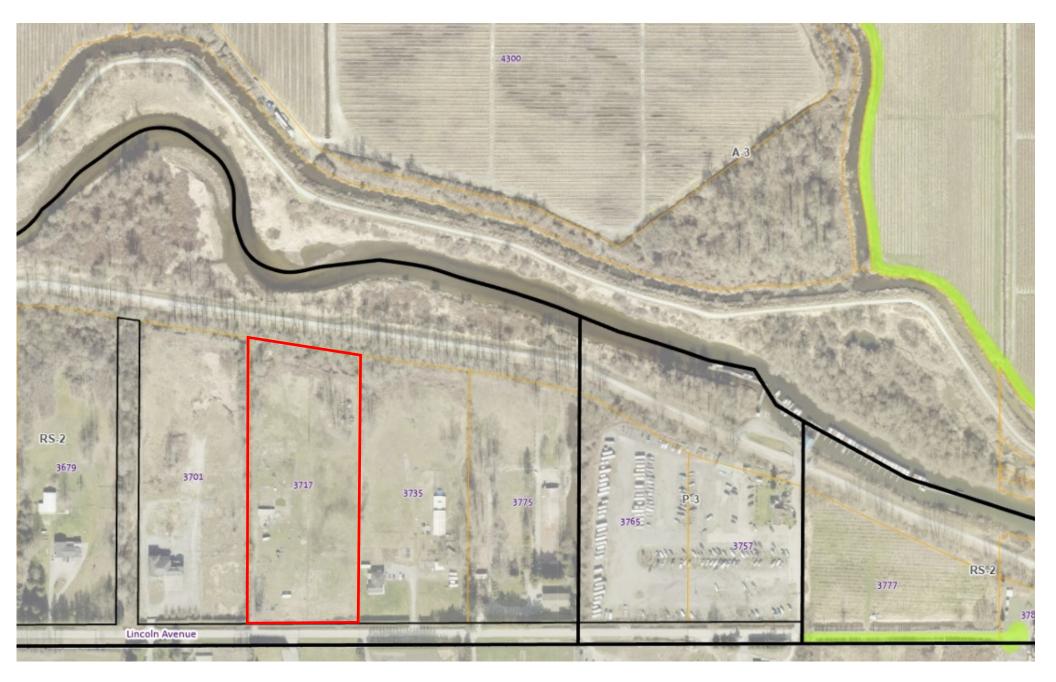


## **Attachment 4**

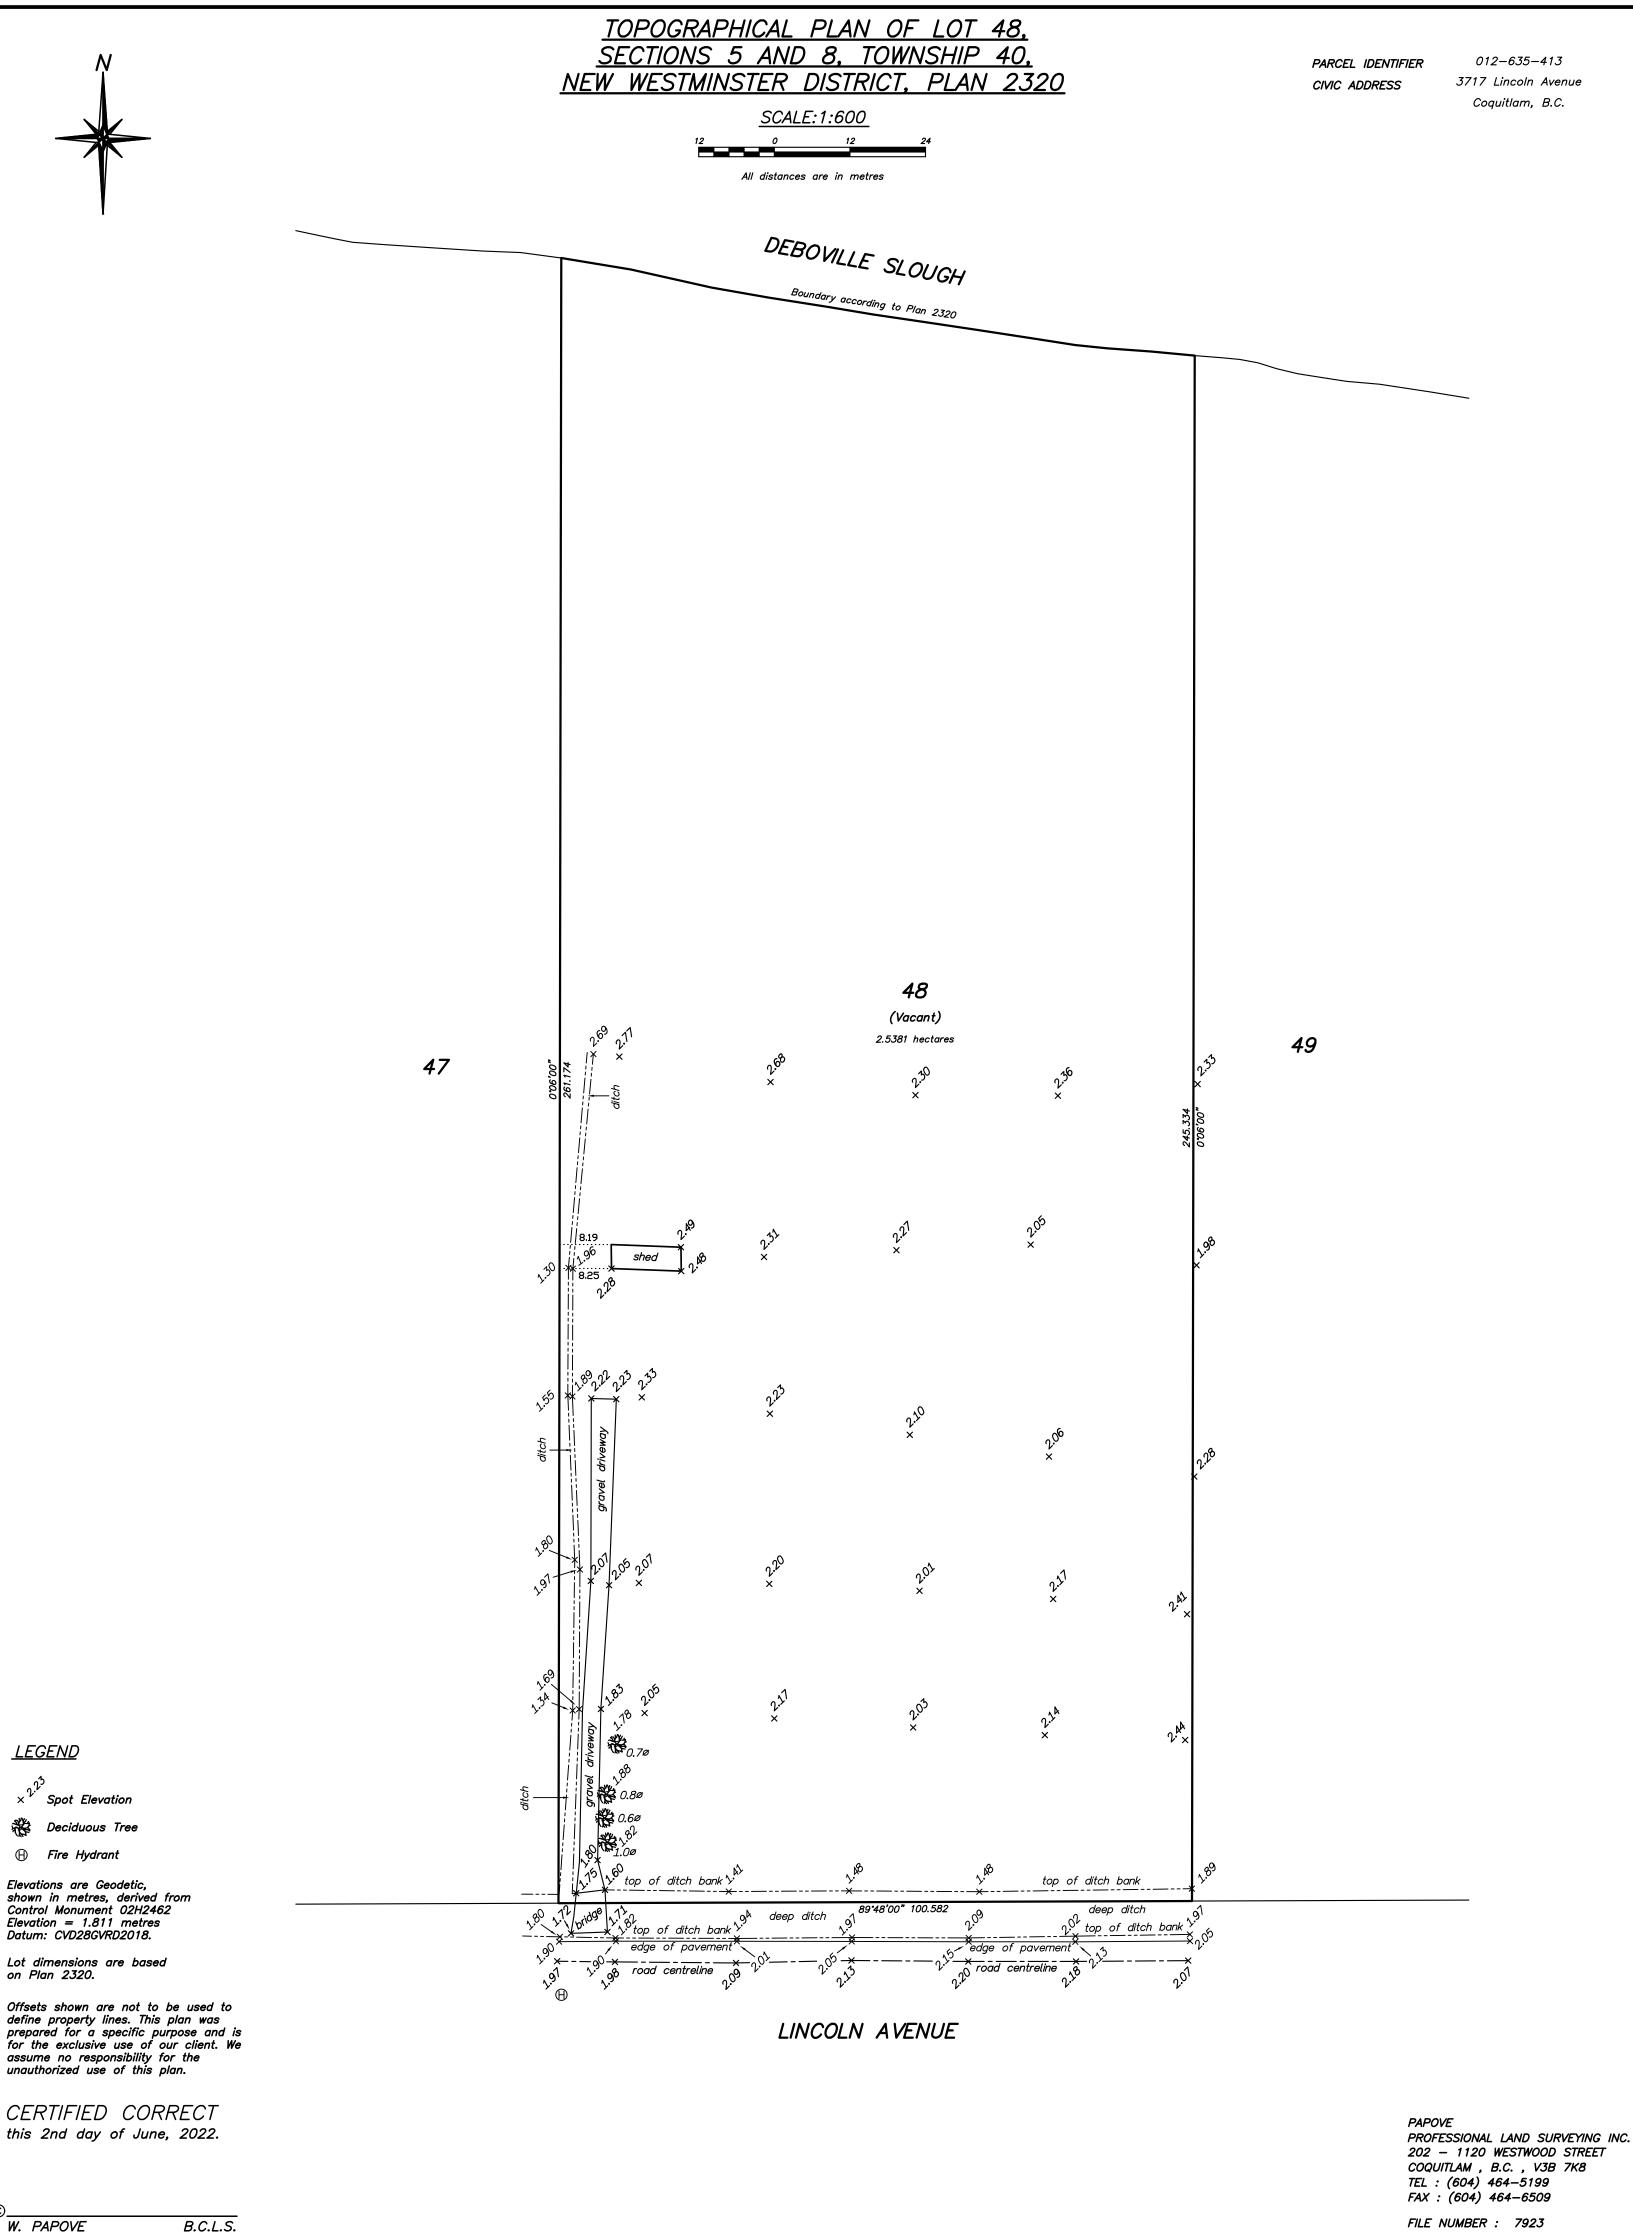

FILE NUMBER : 7923

W. PAPOVE

©.

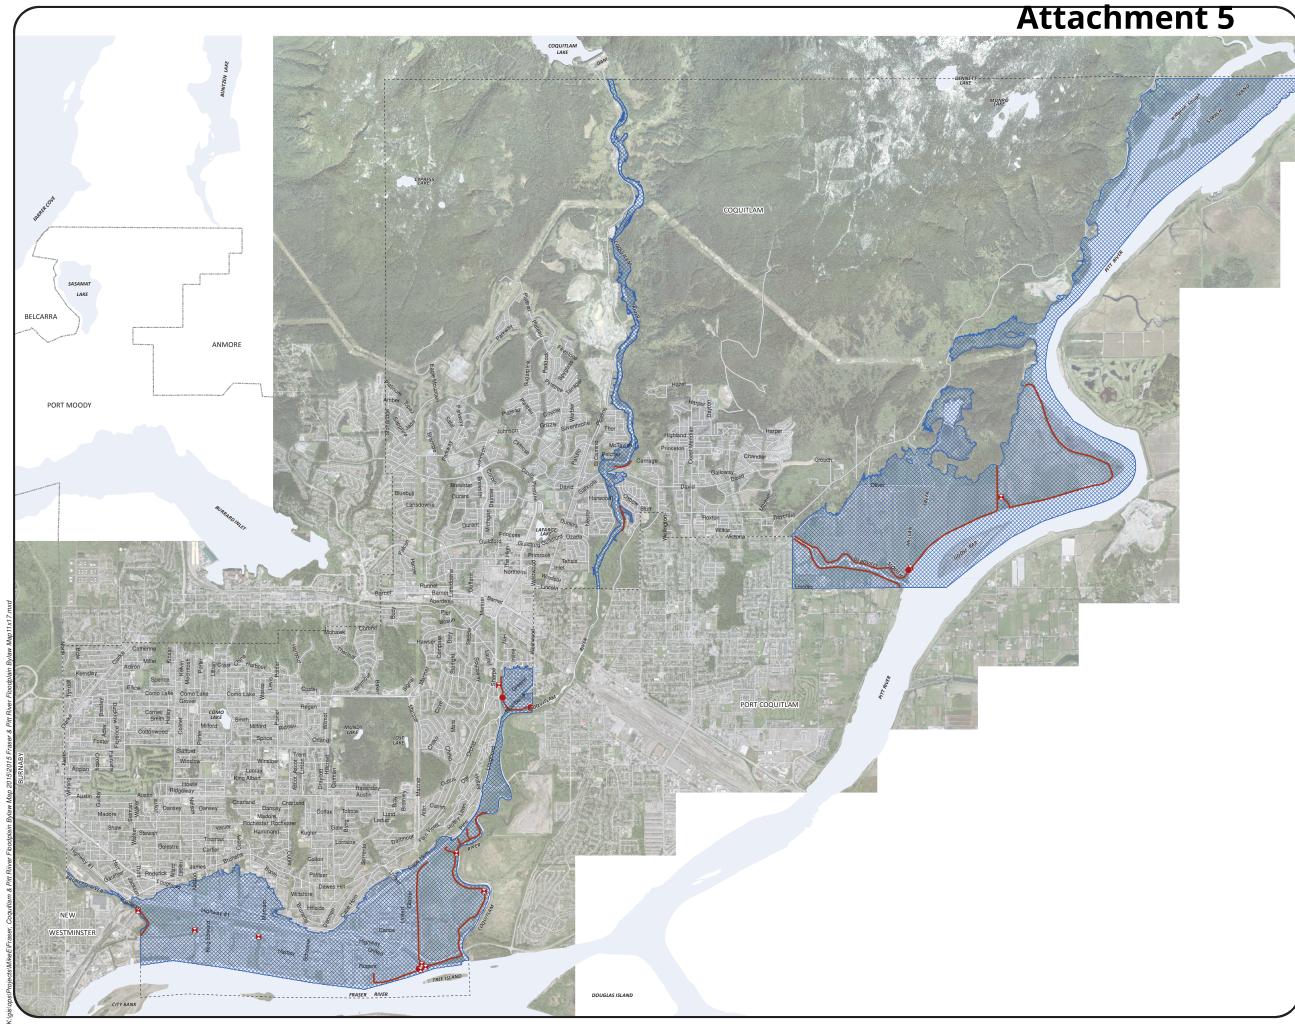

## SCHEDULE 'G' TO BYLAW 3000, 1996

## **Designated Floodplain of the** Brunette, Coquitlam, Fraser and Pitt Rivers

### Legend



Existing Dikes

City Boundary


Flood Extent

Flood extents provided as per the Coquitlam/Fraser/Pitt Rivers Floodplain Mapping report (KWL, October 2015) and Still Creek -Brunette River Floodplain Mapping report (GVRD, 1998).

\* The projected year 2200 sea level rise is taken into account.

## FLOODING MAY STILL OCCUR OUTSIDE OF THE DESIGNATED FLOODPLAIN AREAS

This map does not represent the precise boundaries of the floodplain of the Brunette, Coquitlam, Fraser and Pitt Rivers. It is intended to be used only as an indicator of areas of concern. Floodplain boundaries and flood construction levels must be determined for any application by a professional engineer who certifies that the land may be used safely for the intended use.

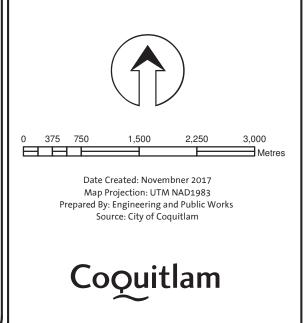

## Attachment 6

BOV for 3717 Lincoln Ave main building height variance

We are **requesting a height variance** of 2.4m above allowable limit of 11m. Currently the existing grade is at 2.08m at the lowest point with an average existing grade of 2.10m. After the building site is brought up with compacted fill (as required for construction in the area) the average finished grade is 4.36m. With the construction of a new 2 level home with a 12-12 peaked roof the Roof ridge will be 11m from the average finished grade. However when calculated for the lower point of the existing grade the height is 13.31m.

The **hardship** is the limiting factor of the height when compared to the existing grade. Given the flood construction level of the area we are required to bring the elevation up to 4.36m average finished grade with our main floor elevation of 5.88m above the crawl space to again accommodate for flood protection. Coupled with a steep slope roof of 12-12 pitch consistent with a craftsman style farm house (to allow for efficient snow and rain shedding) this puts the overall heigh of the home to the top of the roof ridge at 15.46m from the existing grade, but before the construction fill is brought in.. Which exceeds the maximum allowable heigh of 11m. Thus restricting the design to a single story home which would also limit the size and not be conducive of having enough space to raise a family to help contribute to the farm operations or allow for generational living under the same roof. To allow for a typical 2 story home with proper slope for rain and snow shedding as well as bringing the elevation up to protect from flooding and ensuring a solid construction base, we are requiring a variance to mitigate this hardship.

The **intent of the bylaw** is to prevent tall homes from being beside each other and being out of place in the neighbourhood. In this instance, the property line is about 100 feet from the front of the house and 115 feet from the east neighbouring property line and 121 feet from the west neighbour's property line. As well with the area being in the ALR the Farm barns can be built much closer to the property line and not restricted by the same height requirements. The bylaw restriction meets its objective for regular city lots, however in this instance with the property being 6.2 acres, the neighbours are much further away and an increase in overall height won't be distinguishable or intrusive to the area or neighbours