
# BURKE MOUNTAIN ATHLETIC PARK

# **ISSUED FOR RFP**

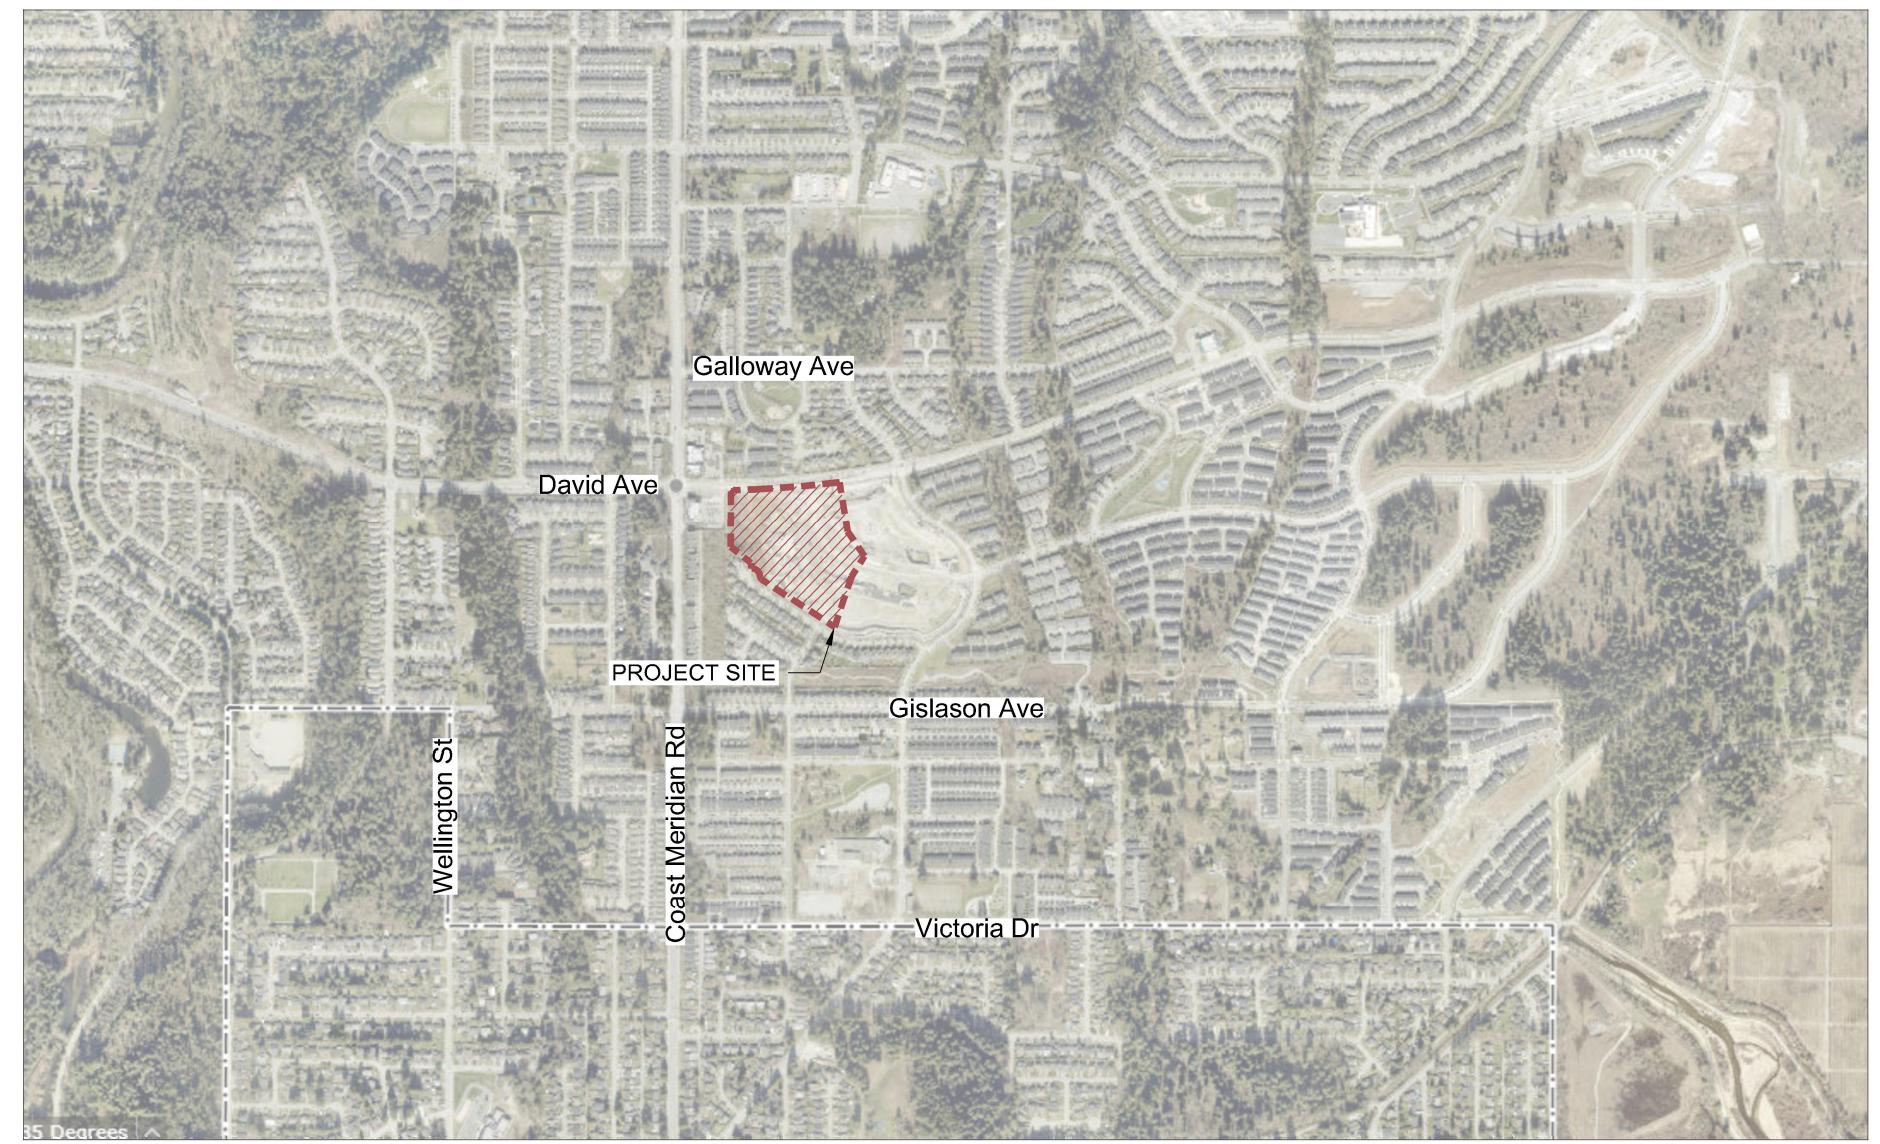

Location Map (NTS)

# **Contact Information**

VDZ+A

Project Landscape Architecture

Fort Langley Studio 102 - 9181 Church Street Fort Langley, British Columbia, V1M 2R8

Mount Pleasant Studio 102-355 Kingsway Vancouver, British Columbia, V5T 3J7

Primary project contact: Travis Martin Travis@vdz.ca o. 604.882.0024 ex.105

Alternate contacts (incase away): Mark van der Zalm Mark@vdz.ca o. 604.882.0024 ex.101

# City of Coquitlam Project Owner

3000 Guildford Way Coquitlam, BC V3B 7N2 Station One Architects Project Building Architecture

soa@soarchitects.com t. 604-793-9445

Sheet List Table			
Sheet Number	Sheet Title		
L-01	COVER PAGE		
L-02	OVERALL SITE PLAN		
L-03	OVERALL TREE PLAN		
L-04A	NORTH ENLARGEMENT PLAN		
L-04B	SOUTH ENLARGEMENT PLAN		
L-05	FENCING LAYOUT PLAN		
L-06A	PLANTING PLAN - HORTICULTURE BED		
L-06B	PLANTING PLAN - LOW MAINTENANCE		
L-07A	SHOTCRETE WALL LAYOUT		
L-07B	WALL ELEVATION AND SECTIONS		
L-08A	TENNIS COURT LAYOUT PLAN		
L-08B	SPORTSFIELD LINEMARKING PLAN - OVERLAY		
L-08C	SPORTSFIELD LINEMARKING PLAN - INDIVIDUAL		
L-08D	TRACK & FIELD LAYOUT PLAN		
L-09	FIELD OVERLOOK		
LS-01	SECTION		
LS-02	SECTION		
LS-03	SECTION		
LS-04	SECTION		
LS-05	SECTION		
LD-01	DETAILS		
LD-02	DETAILS		
LD-03	DETAILS		
LD-04	DETAILS		
LD-05	DETAILS		
LD-06	DETAILS		
LD-07	DETAILS		
LD-08	DETAILS		
IR-01	IRRIGATION OVERALL PLAN		
IR-02	IRRIGATION SYSTEM DESIGN		
IR-03	IRRIGATION SYSTEM DESIGN		
IR-04	IRRIGATION SYSTEM DESIGN		
IR-05	IRRIGATION NOTES AND SPECIFICATIONS		
IR-06	IRRIGATION SYSTEM DETAILS		
IR-07	IRRIGATION SYSTEM DETAILS		
IR-08	IRRIGATION SYSTEM DETAILS		

FORT LANGLEY STUDIO MOUNT PLEASANT STUDIO 100-9181 Church St Fort Langley, BC V1M 2R8 V5T 3J7

12	TM	Issued for RFP	May 05, 2025
11	TM	Issued for 100%	March 25, 2025
10	TM	Issued for 100%	Jan 17, 2025
9	TM	Issued for 100% Draft	Dec 16, 2024
8	TM	Issued for 95% Review	Nov 28, 2024
7	TM	Issued for Costing	Jul 12, 2024
6	TM	Issued for 75% Coordination	Jul 05, 2024
5	TM	Issued for 75% Review	May 08, 2024
4	TM	Issued for 75% Review	May 03, 2024
3	TM	Re-Issued for 50%	Apr 03, 2024
2	ТМ	Issued for 50%	Mar 22, 2024
1	TM	Issued for Review	May 06, 2023
Vo.	Ву:	Description	Date
	REV	ISIONS TABLE FOR DRA	WINGS
<ul> <li>Copyright reserved. This drawing and design is the property of VDZ+A and may not be reproduced or used for other projects without permission.</li> </ul>			

REVISIONS TABLE FOR SHEET

Project:

BURKE MOUNTAIN ATHLETIC PARK

Location:

Drawn:

3390 & 3400 DAVID AVENUE, COQUITLAM, B.C.

BF	
Checked: TM	
Approved:	Original Sheet Size:
TM	24"x36"
Scale:	CONTRACTOR SHALL CHECK ALL DIMENSIONS ON THE WORK AND REPORT ANYDISCREPANCY TO THE CONSULTANT
NTS	BEFORE PROCEEDING. ALL DRAWINGS AND SPECIFICATIONS ARE THE EXCLUSIVE PROPERTY OF THE OWNER AND MUST BE

Ò VDZ Project #: PR20,


Drawing Title:


COVER

NORTH

0

PROPERTY OF THE OWNER AND MUST BE RETURNED AT THE COMPLETION OF THE WORK. ALL REZONING/DP/PPA/FHA/BP DRAWINGS MUST NOT BE PRICED FOR CONSTRUCTION UNLESS LABELED ISSUED FOR TENDER/CONSTRUCTION.

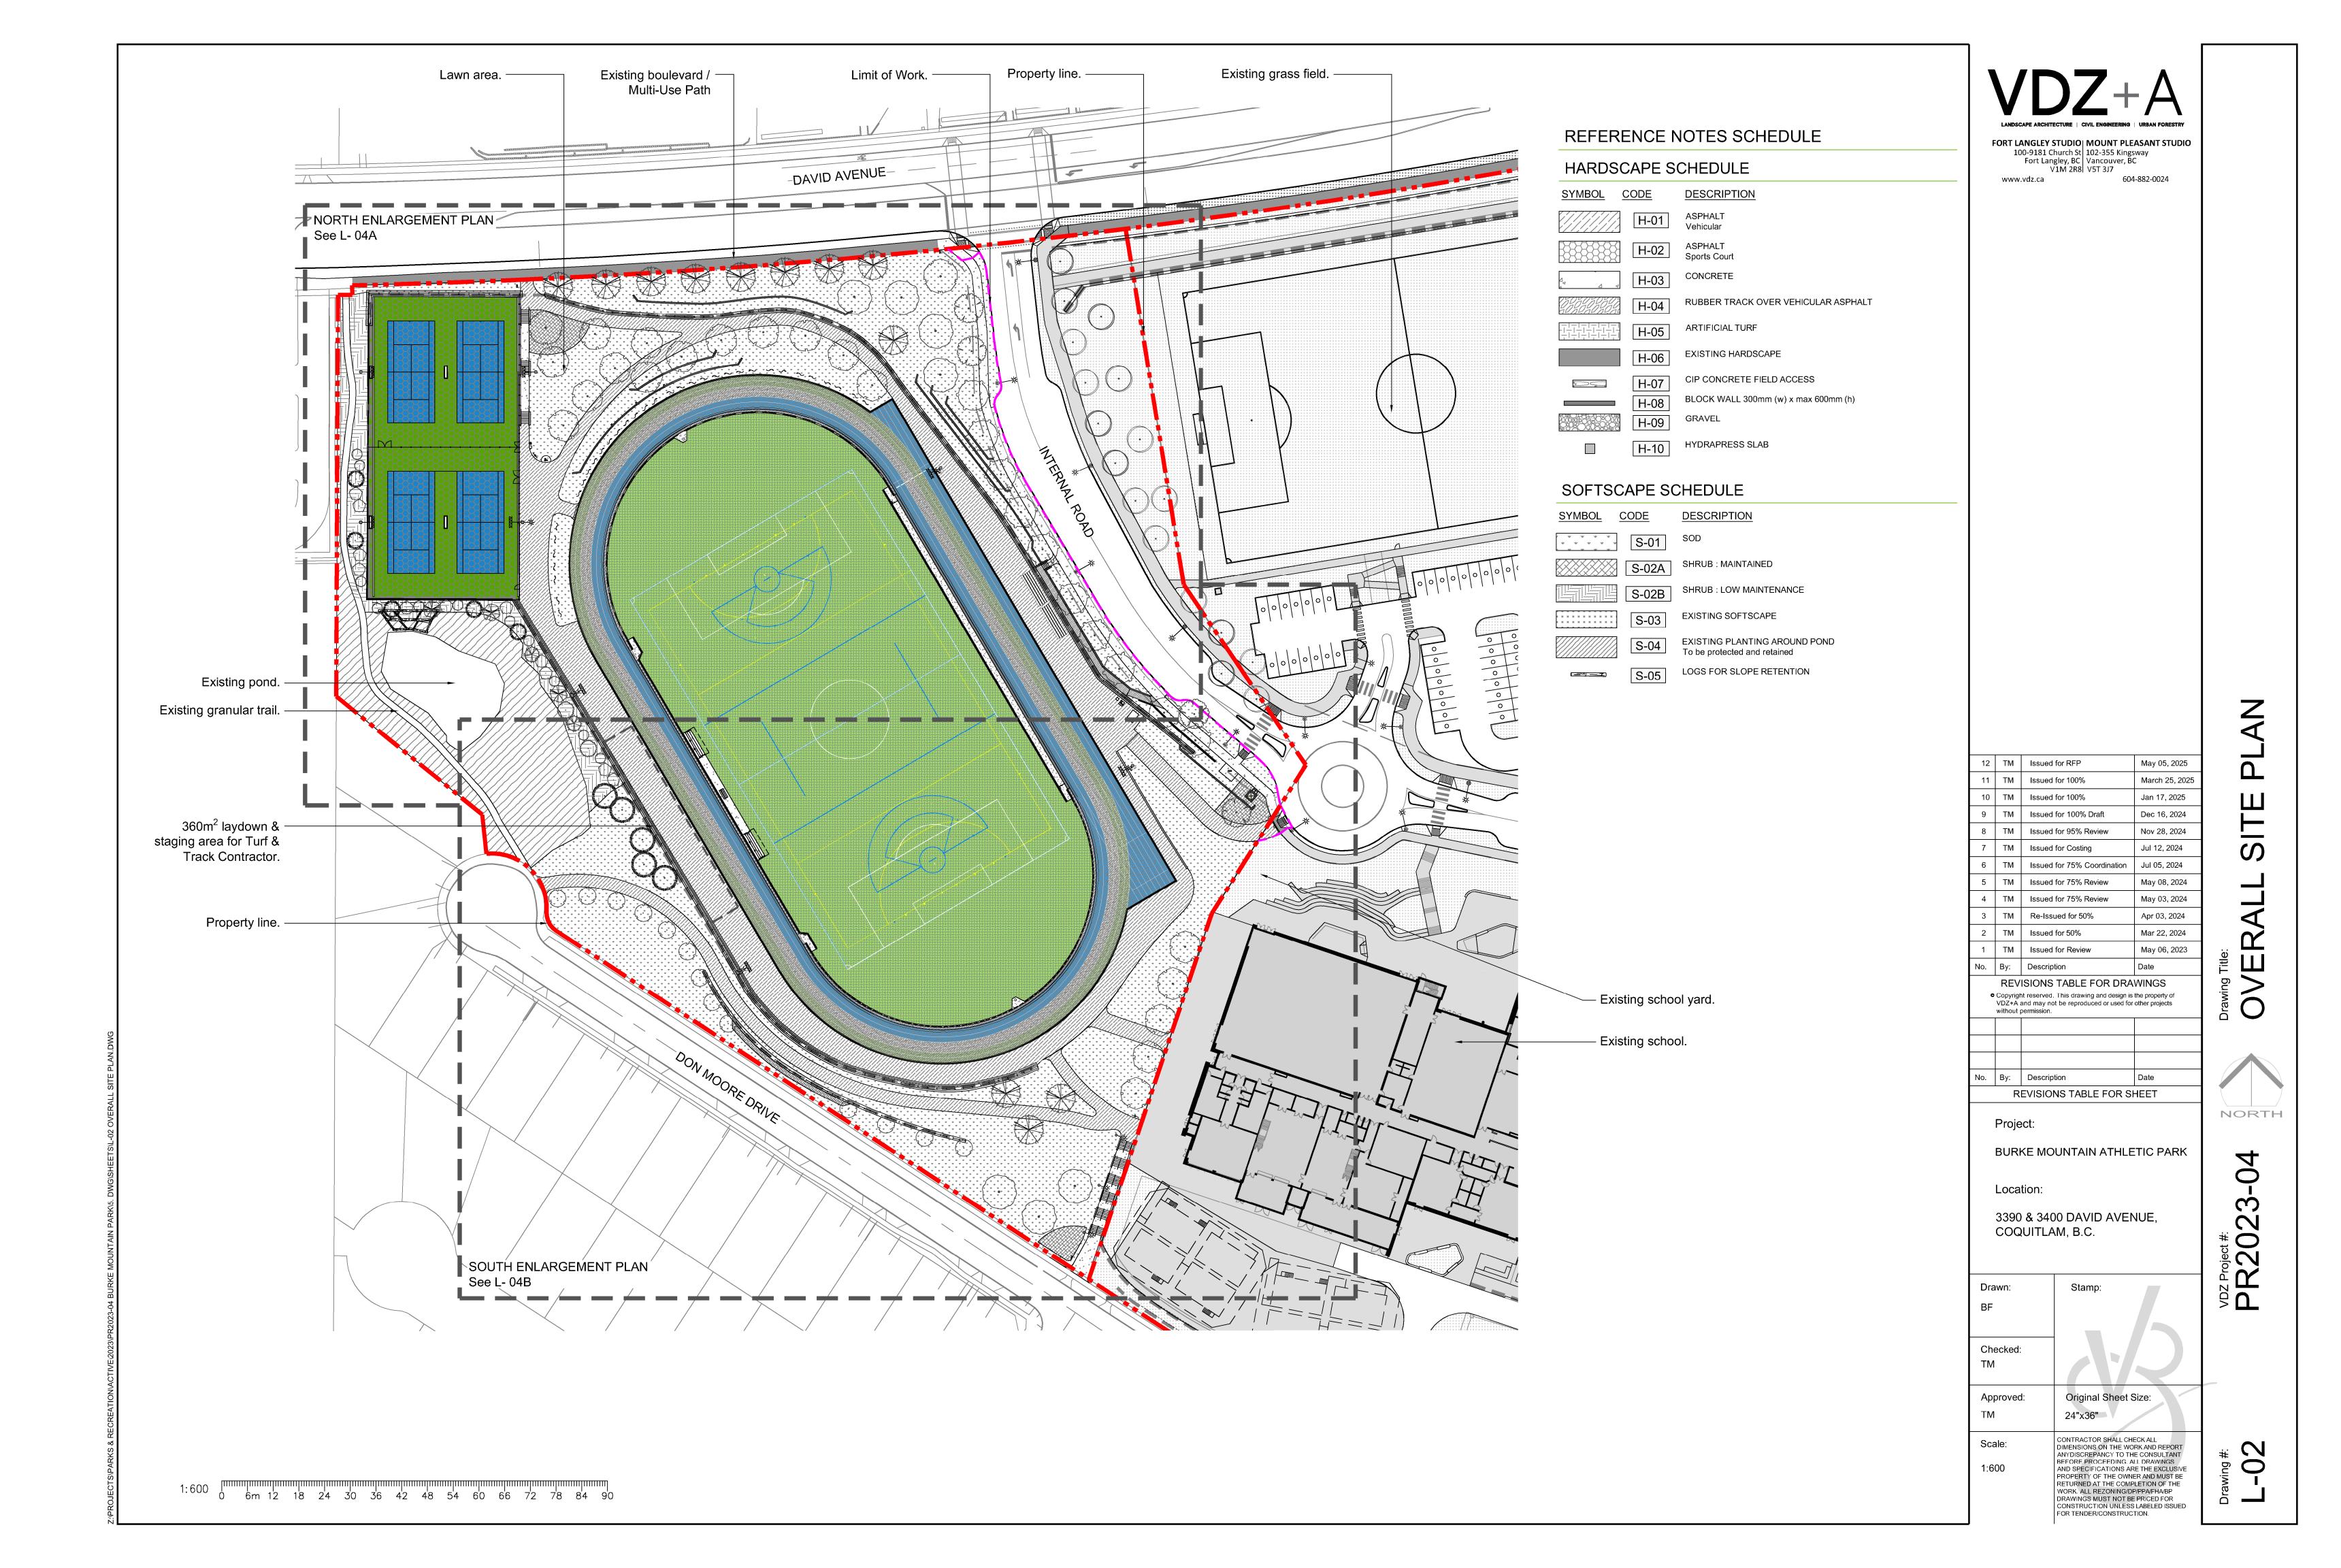

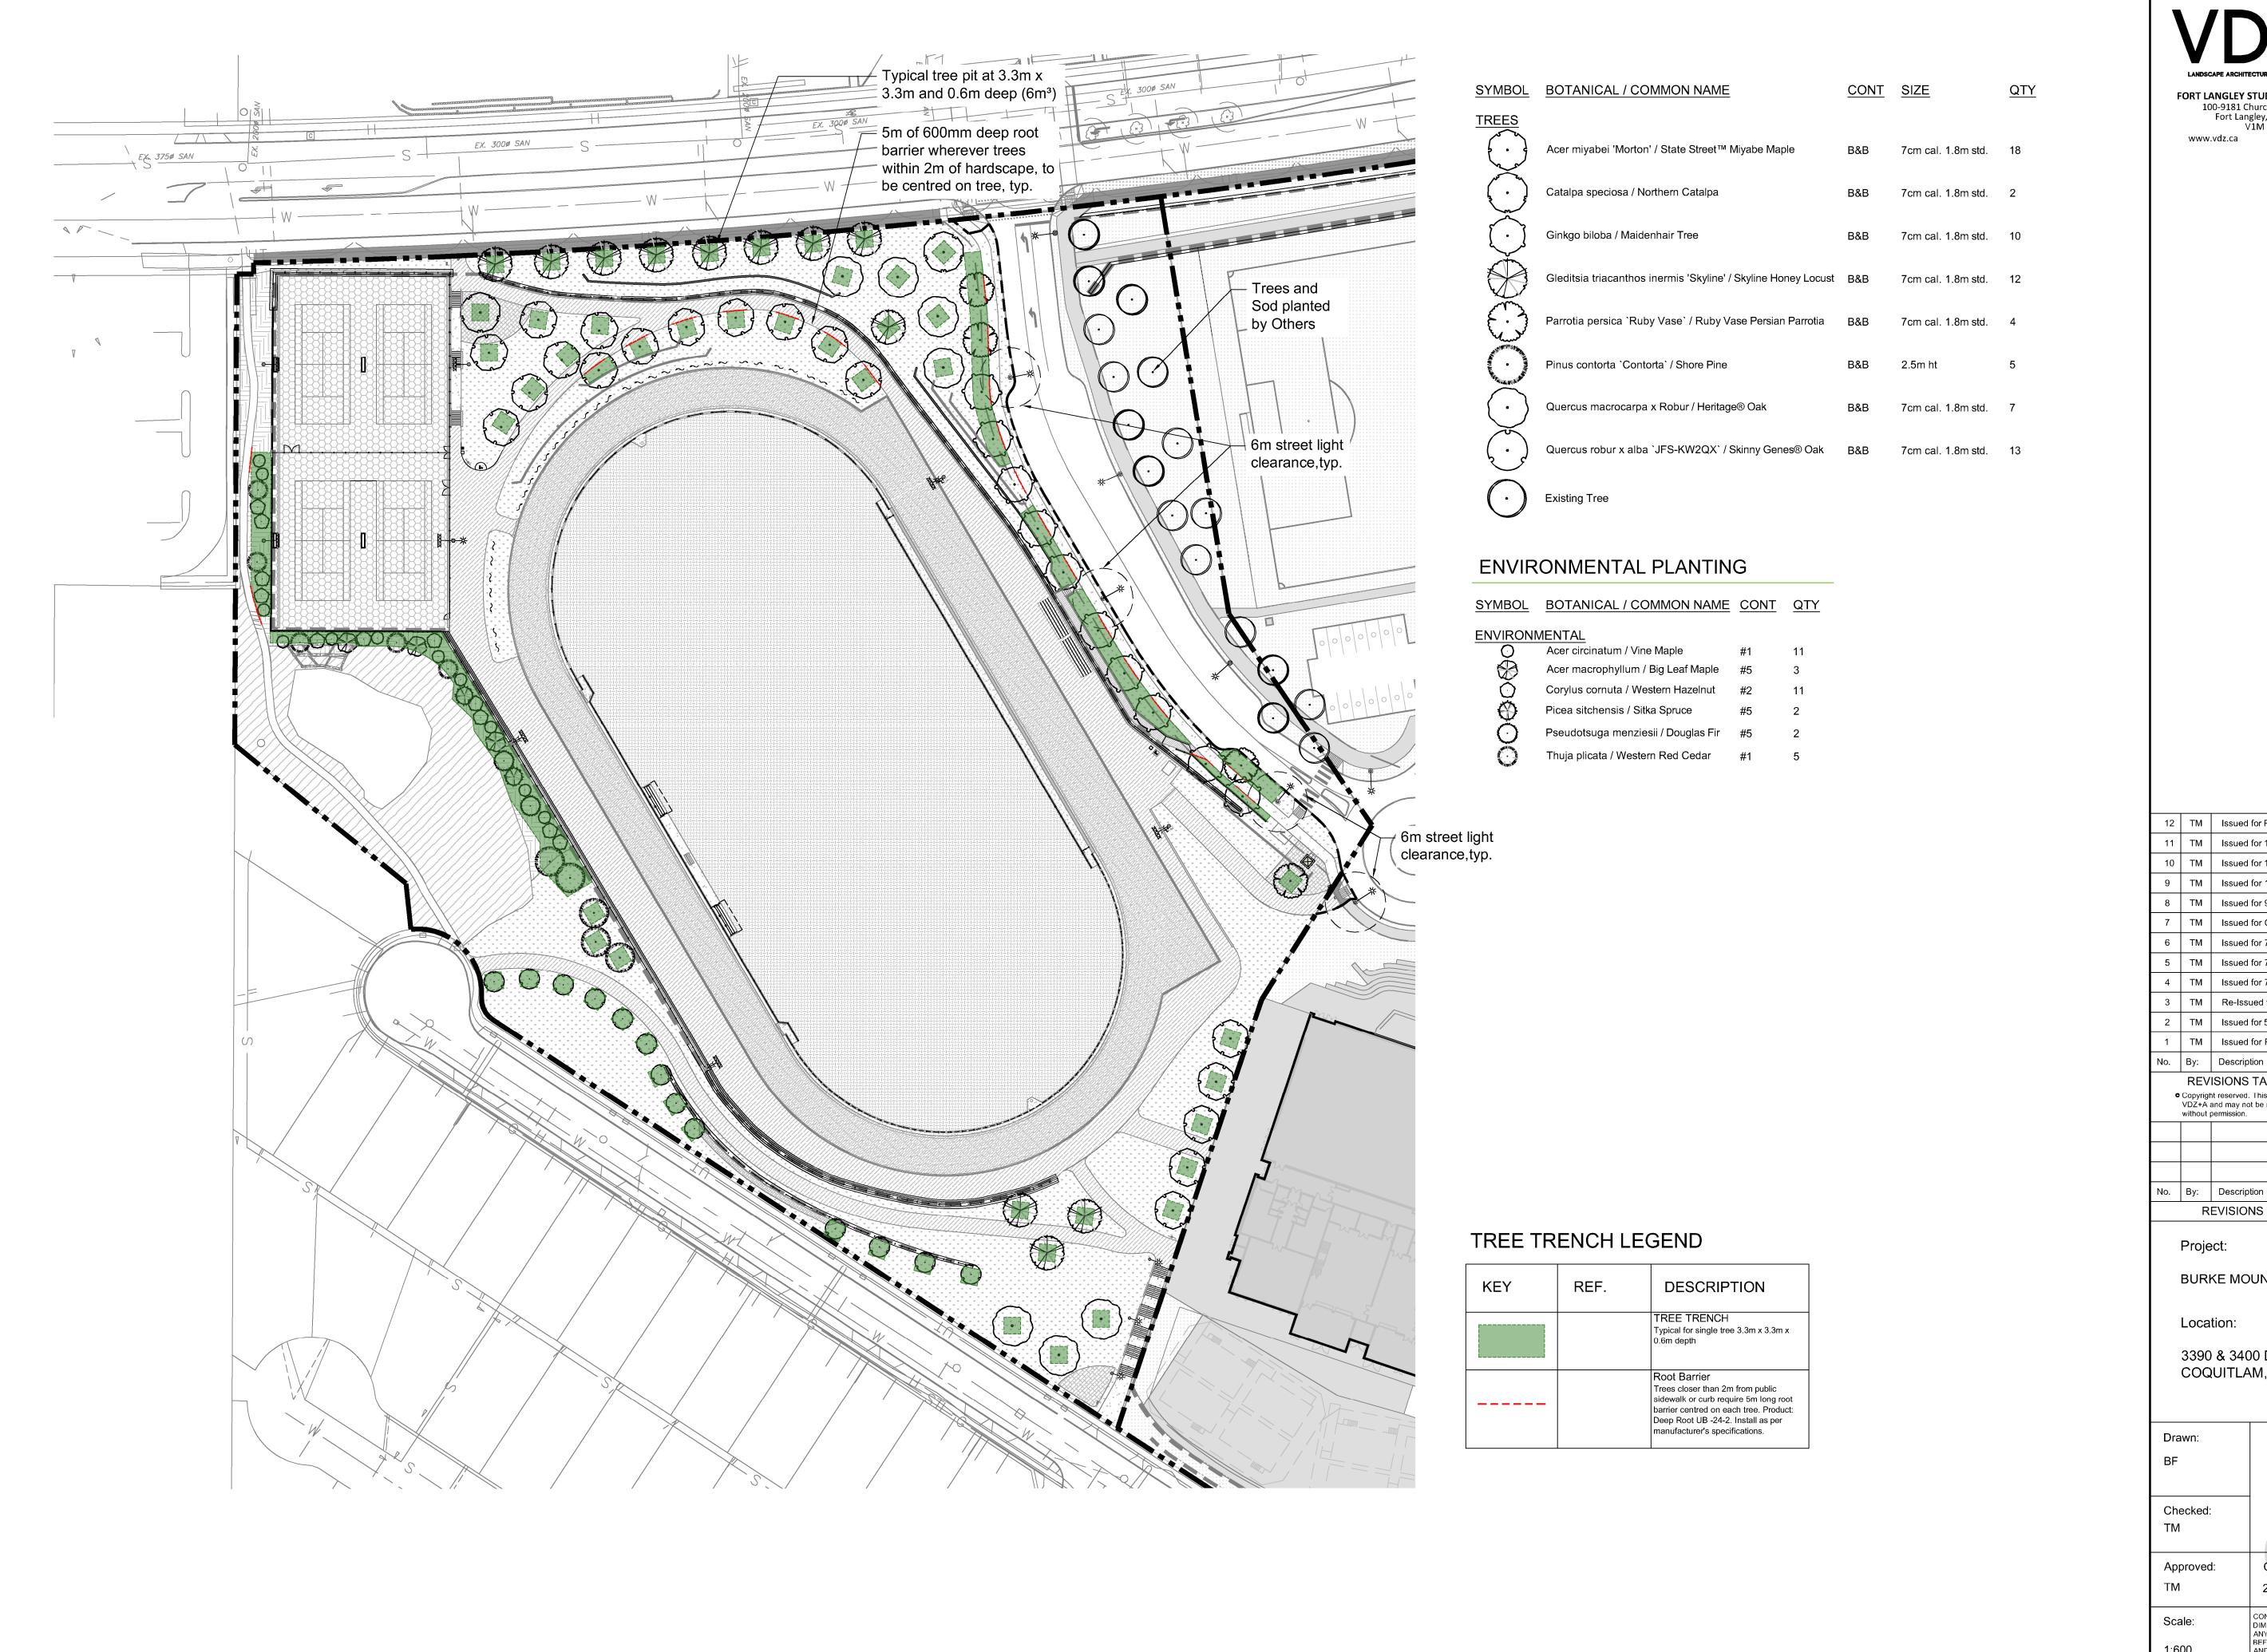



604-882-0024 www.vdz.ca

12	TM	Issued for RFP	May 05, 2025	
11	ТМ	Issued for 100%	March 25, 2025	
10	TM	Issued for 100%	Jan 17, 2025	
9	ТМ	Issued for 100% Draft	Dec 16, 2024	
8	TM	Issued for 95% Review	Nov 28, 2024	
7	TM	Issued for Costing	Jul 12, 2024	
6	TM	Issued for 75% Coordination	Jul 05, 2024	
5	TM	Issued for 75% Review	May 08, 2024	
4	TM	Issued for 75% Review	May 03, 2024	
3	TM	Re-Issued for 50%	Apr 03, 2024	
2	TM	Issued for 50%	Mar 22, 2024	
1	TM	Issued for Review	May 06, 2023	
No.	Ву:	Description	Date	
	REV	ISIONS TABLE FOR DRA	WINGS	
<ul> <li>Copyright reserved. This drawing and design is the property of VDZ+A and may not be reproduced or used for other projects without permission.</li> </ul>				

NORTH

BURKE MOUNTAIN ATHLETIC PARK

REVISIONS TABLE FOR SHEET

Location:


3390 & 3400 DAVID AVENUE, COQUITLAM, B.C.


Drawn:	Stamp:
BF	
Checked: TM	
Approved:	Original Sheet Size:
TM	24"x36"

CONTRACTOR SHALL CHECK ALL DIMENSIONS ON THE WORK AND REPORT ANYDISCREPANCY TO THE CONSULTANT BEFORE PROCEEDING. ALL DRAWINGS AND SPECIFICATIONS ARE THE EXCLUSIVE PROPERTY OF THE OWNER AND MUST BE RETURNED AT THE COMPLETION OF THE WORK. ALL REZONING/DP/PPA/FHA/BP DRAWINGS MUST NOT BE PRICED FOR CONSTRUCTION UNLESS LABELED ISSUED FOR TENDER/CONSTRUCTION.

0

VDZ Project #: PR20,

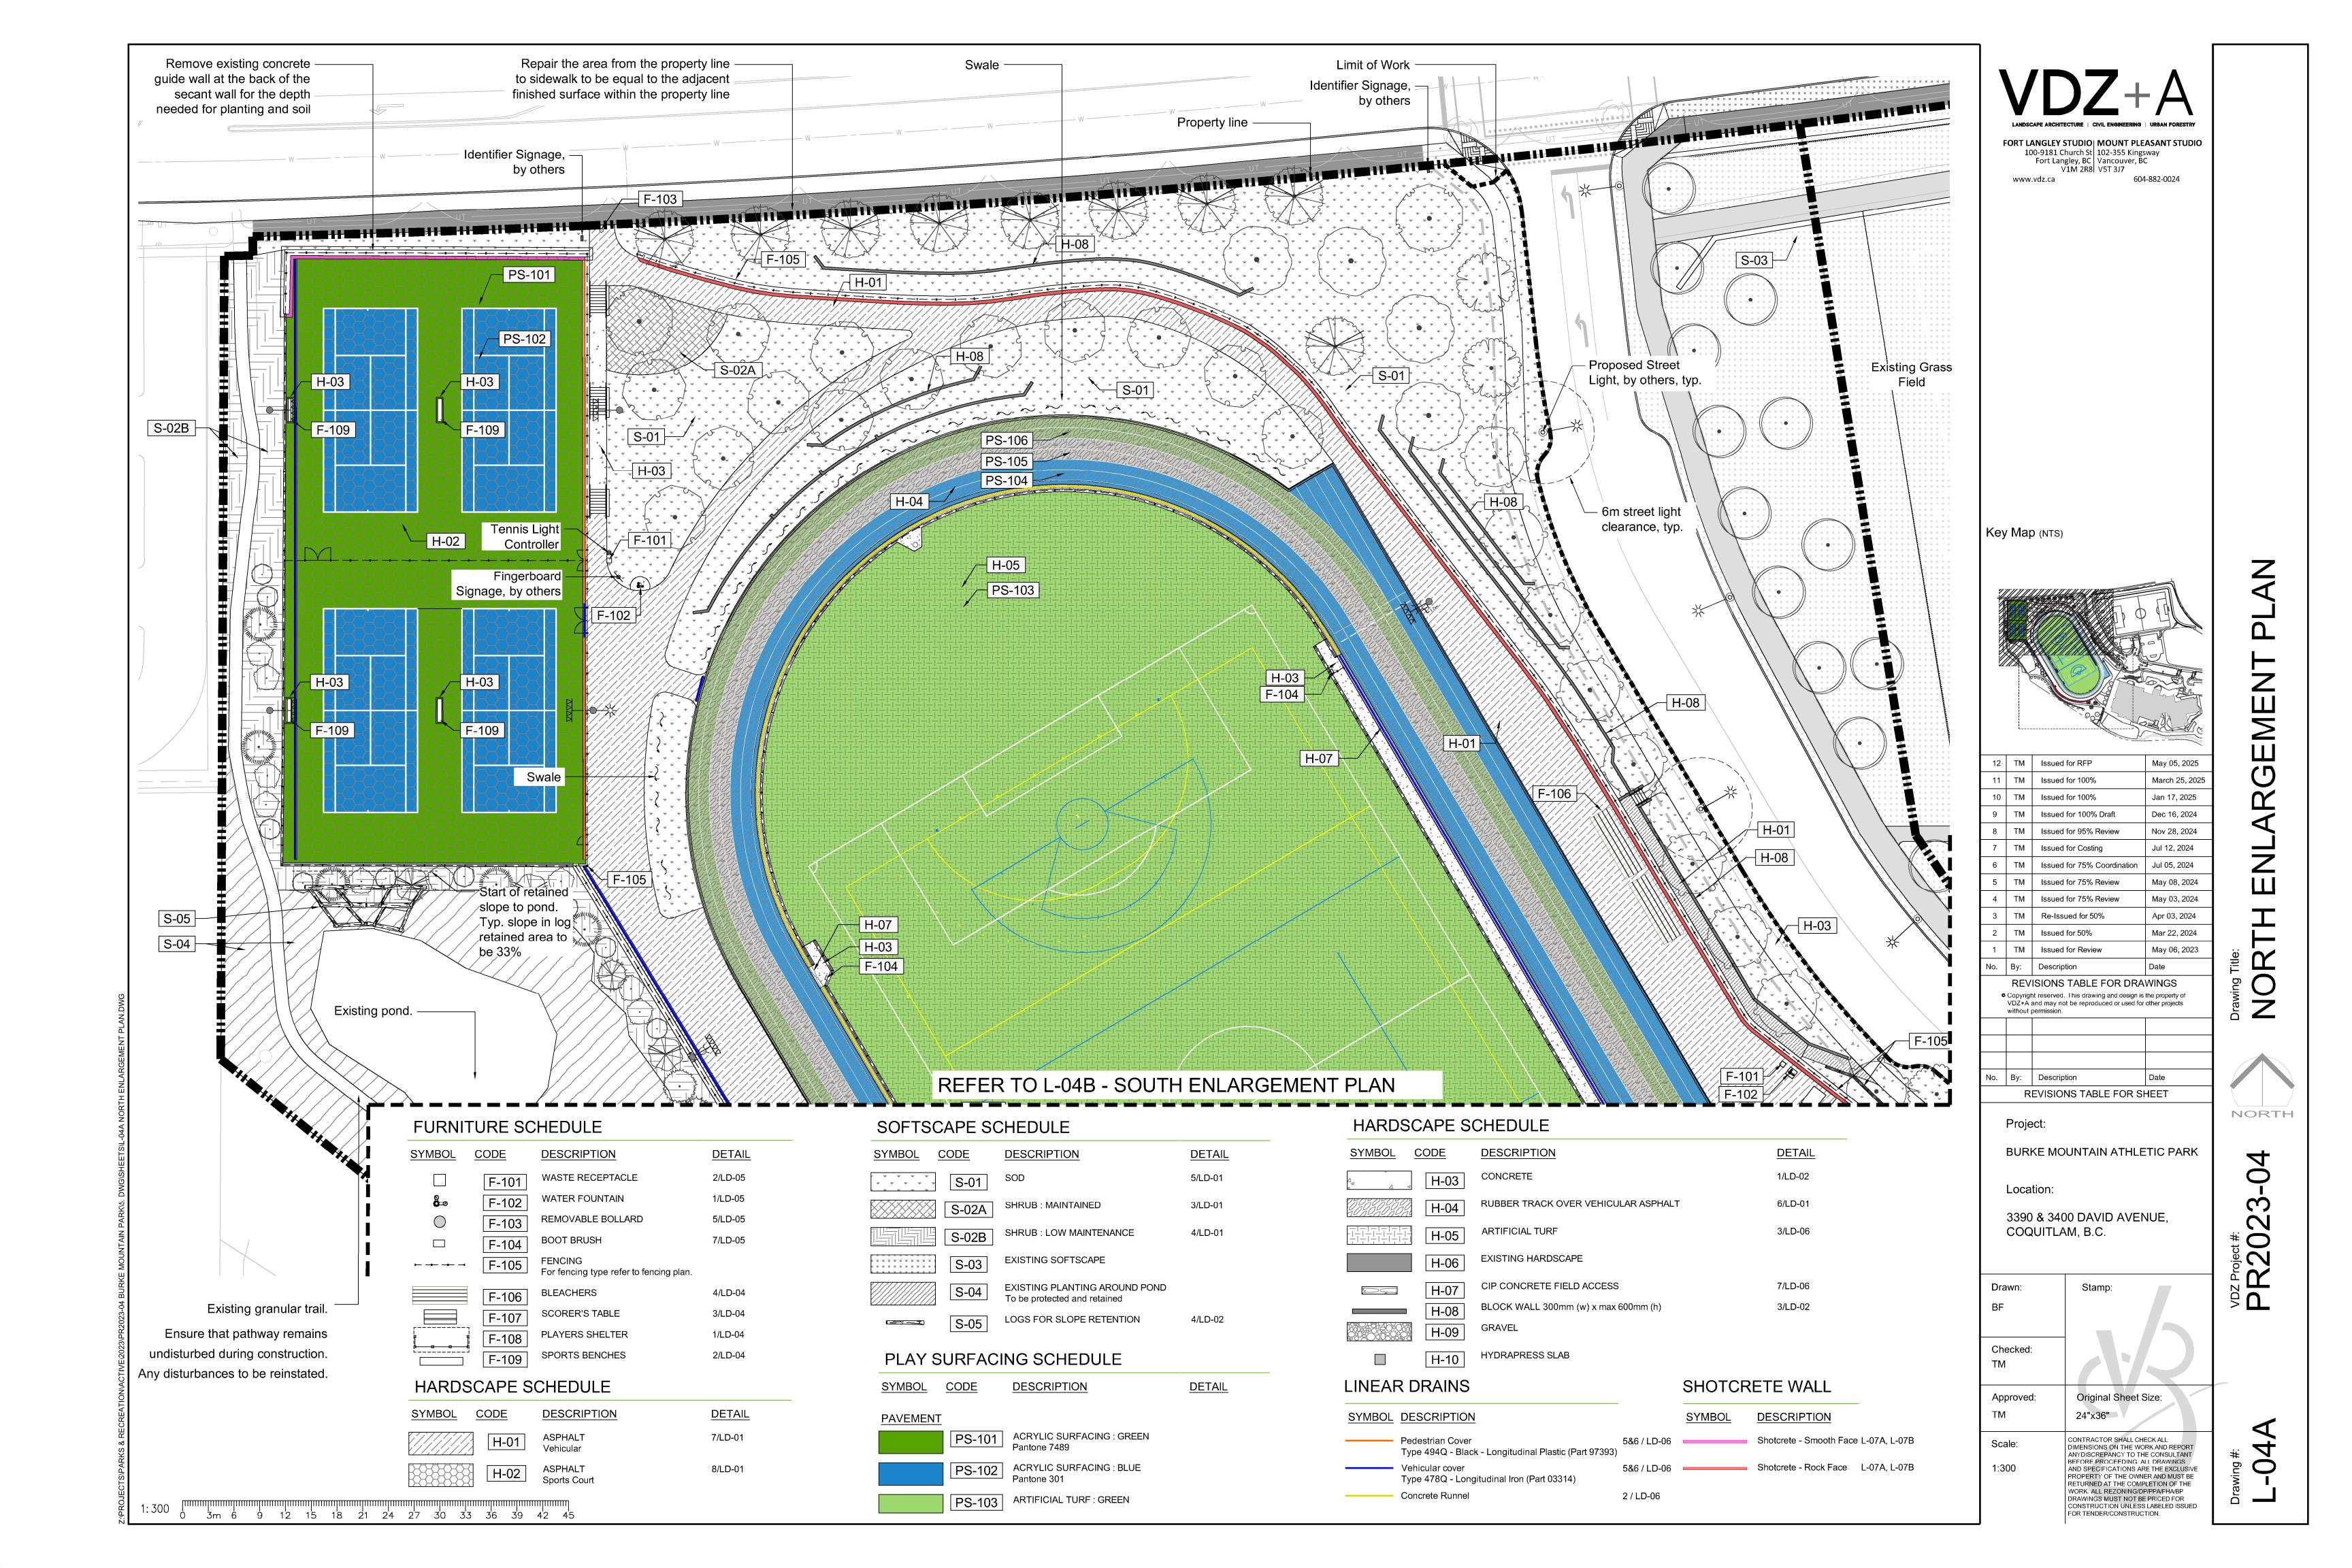

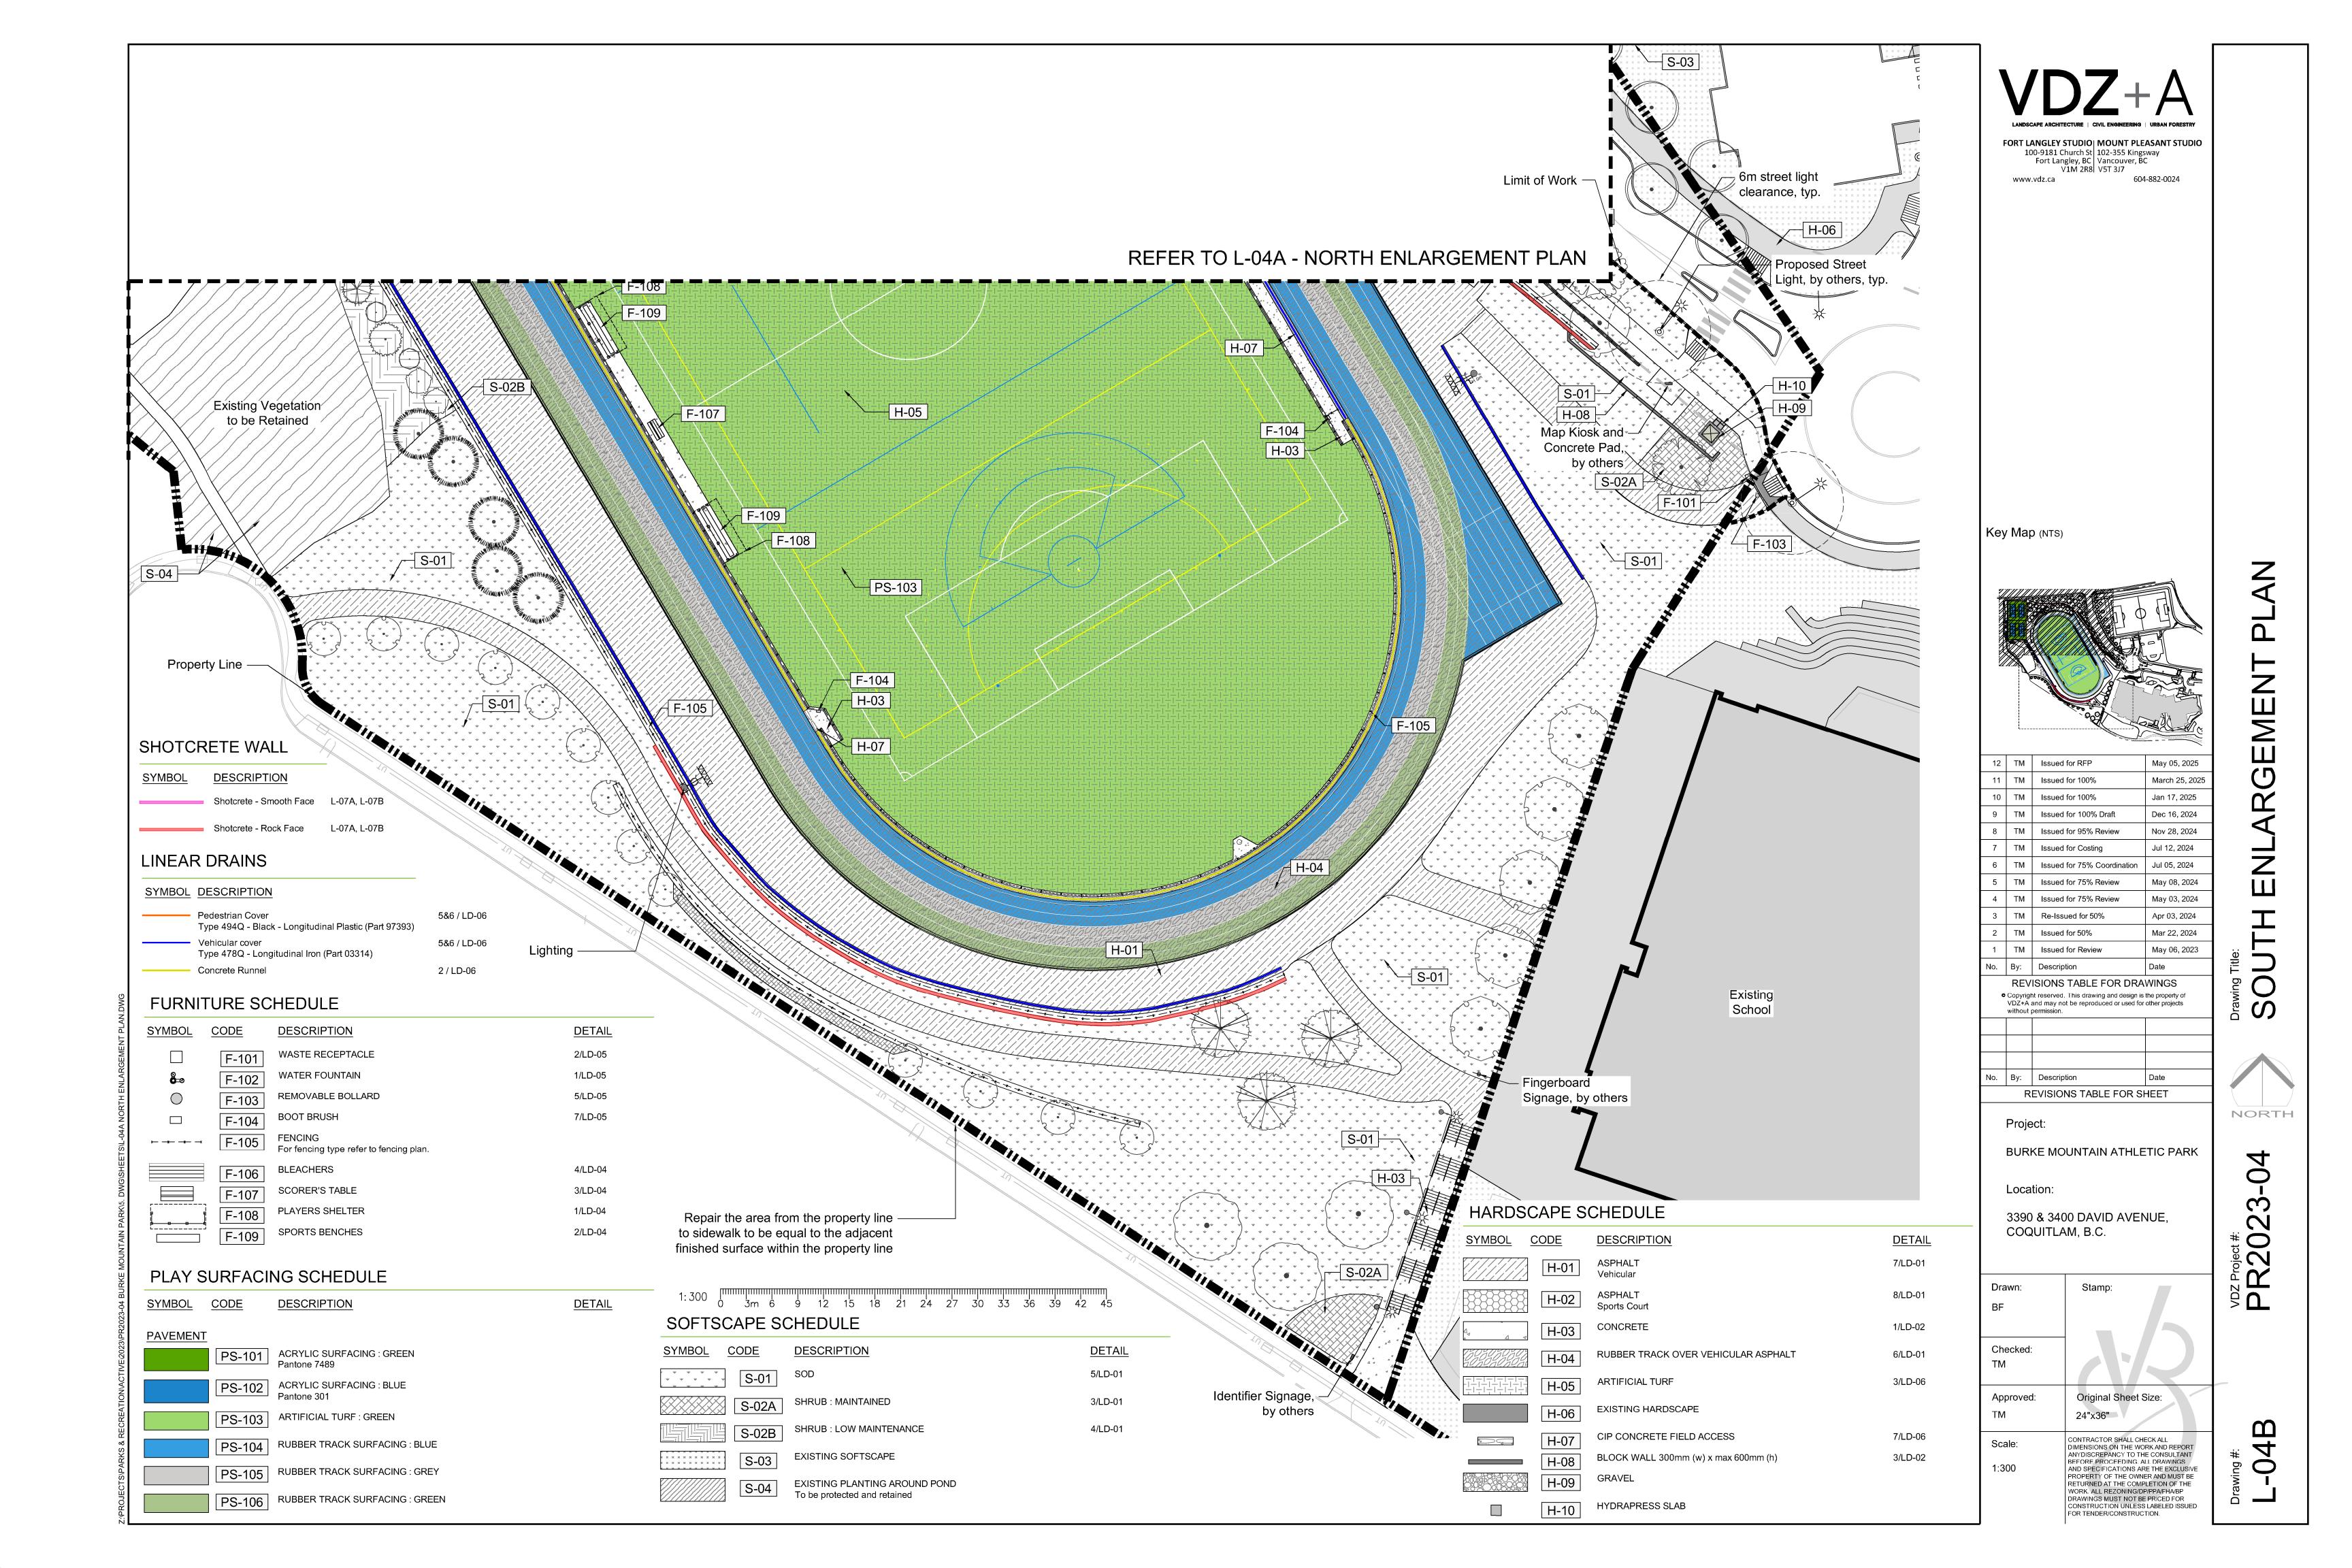





FORT LANGLEY STUDIO

100-9181 Church St
Fort Langley, BC
V1M 2R8

WOUNT PLEASANT STUDIO
102-355 Kingsway
Vancouver, BC
V5T 3J7 604-882-0024

	TM	Issued for RFP	May 05, 2025		
	TM	Issued for 100%	March 25, 2025		
	TM	Issued for 100%	Jan 17, 2025		
	ТМ	Issued for 100% Draft	Dec 16, 2024		
	TM	Issued for 95% Review	Nov 28, 2024		
	TM	Issued for Costing	Jul 12, 2024		
	TM	Issued for 75% Coordination	Jul 05, 2024		
	TM	Issued for 75% Review	May 08, 2024		
	TM	Issued for 75% Review	May 03, 2024		
	ТМ	Re-Issued for 50%	Apr 03, 2024		
	ТМ	Issued for 50%	Mar 22, 2024		
	TM	Issued for Review	May 06, 2023		
	Ву:	Description	Date		
	REVISIONS TABLE FOR DRAWINGS				
• Copyright reserved. This drawing and design is the property of VDZ+A and may not be reproduced or used for other projects without permission.					

Project:

BURKE MOUNTAIN ATHLETIC PARK

Location:

3390 & 3400 DAVID AVENUE, COQUITLAM, B.C.

Drawn:	Stamp:
BF	
Checked: TM	
Approved:	Original Sheet Size:
TM	24"x36"


CONTRACTOR SHALL CHECK ALL
DIMENSIONS ON THE WORK AND REPORT
ANYDISCREPANCY TO THE CONSULTANT
BEFORE PROCEEDING. ALL DRAWINGS
AND SPECIFICATIONS ARE THE EXCLUSIVE
PROPERTY OF THE OWNER AND MUST BE
RETURNED AT THE COMPLETION OF THE
WORK. ALL REZONING/DP/PPA/FHA/BP
DRAWINGS MUST NOT BE PRICED FOR
CONSTRUCTION UNLESS LABELED ISSUED
FOR TENDER/CONSTRUCTION.

0

FENCING

NORTH

VDZ Project #:
PR20,

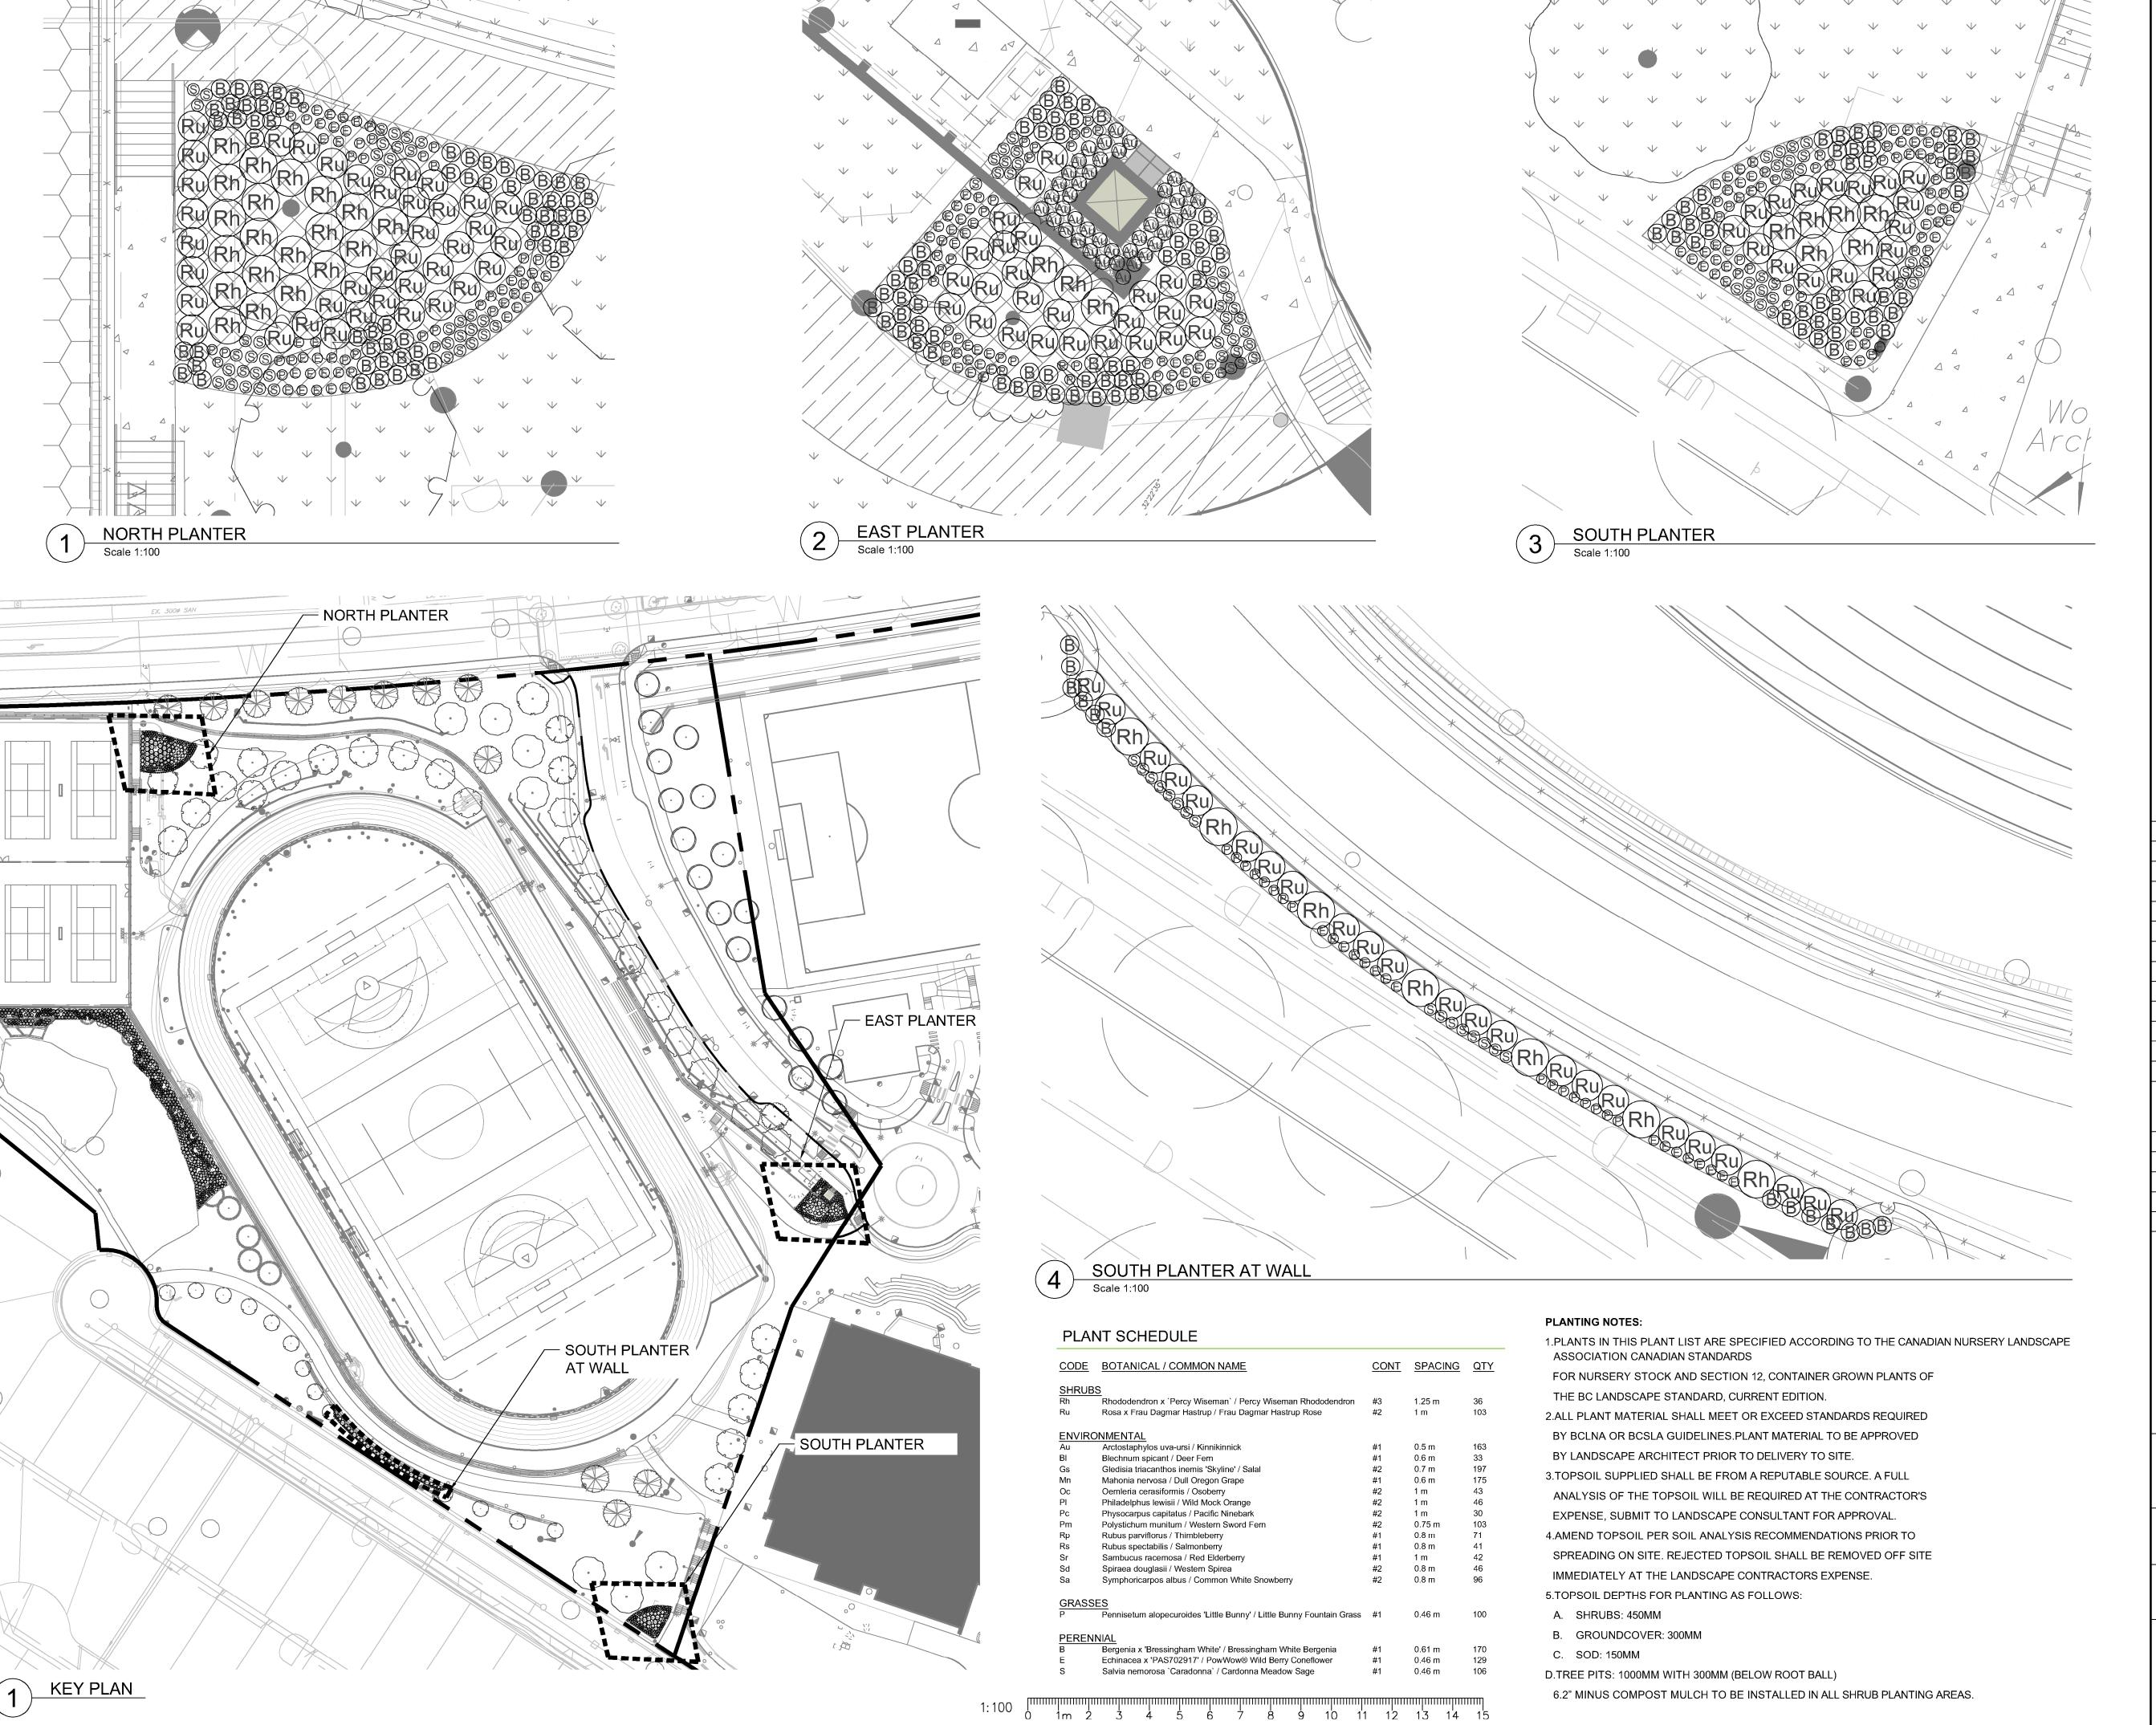

FORT LANGLEY STUDIO
100-9181 Church St
Fort Langley, BC
V1M 2R8

MOUNT PLEASANT STUDIO
102-355 Kingsway
Vancouver, BC
V5T 3J7 www.vdz.ca

12	TM	Issued for RFP	May 05, 2025		
11	TM	Issued for 100%	March 25, 2025		
10	ТМ	Issued for 100%	Jan 17, 2025		
9	TM	Issued for 100% Draft	Dec 16, 2024		
8	TM	Issued for 95% Review	Nov 28, 2024		
7	TM	Issued for Costing	Jul 12, 2024		
6	TM	Issued for 75% Coordination	Jul 05, 2024		
5	TM	Issued for 75% Review	May 08, 2024		
4	TM	Issued for 75% Review	May 03, 2024		
3	TM	Re-Issued for 50%	Apr 03, 2024		
2	ТМ	Issued for 50%	Mar 22, 2024		
1	ТМ	Issued for Review	May 06, 2023		
No.	Ву:	Description	Date		
REVISIONS TABLE FOR DRAWINGS					
0	<ul> <li>Copyright reserved. This drawing and design is the property of VDZ+A and may not be reproduced or used for other projects without permission.</li> </ul>				

REVISIONS TABLE FOR SHEET Project:

BURKE MOUNTAIN ATHLETIC PARK

Location:

3390 & 3400 DAVID AVENUE, COQUITLAM, B.C.

Drawn:	Stamp:
BF	
Checked:	
TM	
Approved:	Original Sheet Size:
TM	24"×36"

24"x36"

CONTRACTOR SHALL CHECK ALL Scale: DIMENSIONS ON THE WORK AND REPORT ANYDISCREPANCY TO THE CONSULTANT BEFORE PROCEEDING. ALL DRAWINGS
AND SPECIFICATIONS ARE THE EXCLUSIVE
PROPERTY OF THE OWNER AND MUST BE RETURNED AT THE COMPLETION OF THE WORK. ALL REZONING/DP/PPA/FHA/BP DRAWINGS MUST NOT BE PRICED FOR CONSTRUCTION UNLESS LABELED ISSUED

FOR TENDER/CONSTRUCTION.


0

 $\Box$ 

ANTING

NORTH

# **O** 

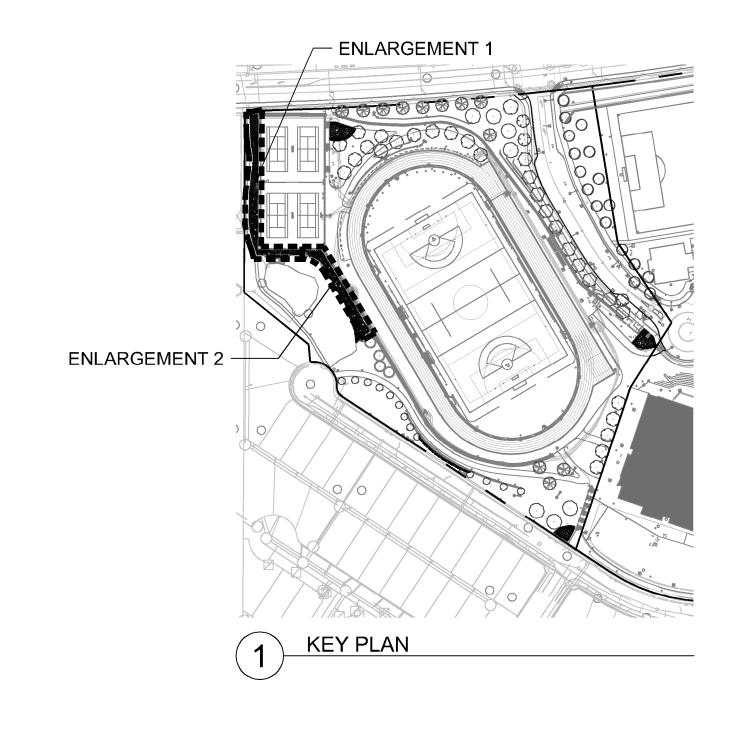

CODE	BOTANICAL / COMMON NAME	CONT	<u>SPACING</u>	<u>QTY</u>
SHRUB	<u>s</u>			
Rh	Rhododendron x `Percy Wiseman` / Percy Wiseman Rhododendron	#3	1.25 m	36
Ru	Rosa x Frau Dagmar Hastrup / Frau Dagmar Hastrup Rose	#2	1 m	103
ENVIRO	DNMENTAL			
Au	Arctostaphylos uva-ursi / Kinnikinnick	#1	0.5 m	163
BI	Blechnum spicant / Deer Fern	#1	0.6 m	33
Gs	Gledisia triacanthos inemis 'Skyline' / Salal	#2	0.7 m	197
Mn	Mahonia nervosa / Dull Oregon Grape	#1	0.6 m	175
Ос	Oemleria cerasiformis / Osoberry	#2	1 m	43
PI	Philadelphus lewisii / Wild Mock Orange	#2	1 m	46
Pc	Physocarpus capitatus / Pacific Ninebark	#2	1 m	30
Pm	Polystichum munitum / Western Sword Fern	#2	0.75 m	103
Rp	Rubus parviflorus / Thimbleberry	#1	0.8 m	71
Rs	Rubus spectabilis / Salmonberry	#1	0.8 m	41
Sr	Sambucus racemosa / Red Elderberry	#1	1 m	42
Sd	Spiraea douglasii / Western Spirea	#2	0.8 m	46
Sa	Symphoricarpos albus / Common White Snowberry	#2	0.8 m	96
GRASS	ES			
Р	Pennisetum alopecuroides 'Little Bunny' / Little Bunny Fountain Grass	#1	0.46 m	100
PEREN	NIAI			
<u> Б. С. С. Т.</u> В	Bergenia x 'Bressingham White' / Bressingham White Bergenia	#1	0.61 m	170
E	Echinacea x 'PAS702917' / PowWow® Wild Berry Coneflower	#1	0.46 m	129
S	Salvia nemorosa `Caradonna` / Cardonna Meadow Sage	#1	0.46 m	106

### **PLANTING NOTES**

1.PLANTS IN THIS PLANT LIST ARE SPECIFIED ACCORDING TO THE CANADIAN NURSERY LANDSCAPE ASSOCIATION CANADIAN STANDARDS FOR NURSERY STOCK AND SECTION 12, CONTAINER GROWN PLANTS OF

THE BC LANDSCAPE STANDARD, CURRENT EDITION. 2.ALL PLANT MATERIAL SHALL MEET OR EXCEED STANDARDS REQUIRED

BY LANDSCAPE ARCHITECT PRIOR TO DELIVERY TO SITE. 3.TOPSOIL SUPPLIED SHALL BE FROM A REPUTABLE SOURCE. A FULL ANALYSIS OF THE TOPSOIL WILL BE REQUIRED AT THE CONTRACTOR'S EXPENSE, SUBMIT TO LANDSCAPE CONSULTANT FOR APPROVAL. 4.AMEND TOPSOIL PER SOIL ANALYSIS RECOMMENDATIONS PRIOR TO SPREADING ON SITE. REJECTED TOPSOIL SHALL BE REMOVED OFF SITE IMMEDIATELY AT THE LANDSCAPE CONTRACTORS EXPENSE.

BY BCLNA OR BCSLA GUIDELINES.PLANT MATERIAL TO BE APPROVED

5.TOPSOIL DEPTHS FOR PLANTING AS FOLLOWS:

- A. SHRUBS: 450MM
- B. GROUNDCOVER: 300MM
- C. SOD: 150MM

D.TREE PITS: 1000MM WITH 300MM (BELOW ROOT BALL) 6.2" MINUS COMPOST MULCH TO BE INSTALLED IN ALL SHRUB PLANTING AREAS.

L	ANT.	SCHEDULE	

BOTANICAL / COMMON NAME	CONT	SPACING	<u>QTY</u>
3			
	#3	1.25 m	36
Rosa x Frau Dagmar Hastrup / Frau Dagmar Hastrup Rose	#2	1 m	103
NMENTAL			
	#1	0.5 m	163
' '	#1	0.6 m	33
	#2	0.7 m	197
•	#1	0.6 m	175
Oemleria cerasiformis / Osoberry	#2	1 m	43
Philadelphus lewisii / Wild Mock Orange	#2	1 m	46
Physocarpus capitatus / Pacific Ninebark	#2	1 m	30
Polystichum munitum / Western Sword Fern	#2	0.75 m	103
Rubus parviflorus / Thimbleberry	#1	0.8 m	71
Rubus spectabilis / Salmonberry	#1	0.8 m	41
Sambucus racemosa / Red Elderberry	#1	1 m	42
Spiraea douglasii / Western Spirea	#2	0.8 m	46
Symphoricarpos albus / Common White Snowberry	#2	0.8 m	96
ES			
Pennisetum alopecuroides 'Little Bunny' / Little Bunny Fountain Grass	#1	0.46 m	100
NIAL			
Bergenia x 'Bressingham White' / Bressingham White Bergenia	#1	0.61 m	170
Echinacea x 'PAS702917' / PowWow® Wild Berry Coneflower	#1	0.46 m	129
Salvia nemorosa `Caradonna` / Cardonna Meadow Sage	#1	0.46 m	106
	Rhododendron x 'Percy Wiseman' / Percy Wiseman Rhododendron Rosa x Frau Dagmar Hastrup / Frau Dagmar Hastrup Rose    NMENTAL	Rhododendron x `Percy Wiseman` / Percy Wiseman Rhododendron #3 Rosa x Frau Dagmar Hastrup / Frau Dagmar Hastrup Rose #2    NMENTAL	Rhododendron x 'Percy Wiseman' / Percy Wiseman Rhododendron #3 1.25 m Rosa x Frau Dagmar Hastrup / Frau Dagmar Hastrup Rose #2 1 m    NMENTAL

lo. By: Description REVISIONS TABLE FOR SHEET

Project:

12 TM Issued for RFP

11 TM Issued for 100%

10 TM Issued for 100%

9 TM Issued for 100% Draft

8 TM Issued for 95% Review

TM Issued for Costing

5 TM Issued for 75% Review

4 TM Issued for 75% Review

3 TM Re-Issued for 50%

TM Issued for Review

2 TM Issued for 50%

. By: Description

6 TM Issued for 75% Coordination

BURKE MOUNTAIN ATHLETIC PARK

REVISIONS TABLE FOR DRAWINGS

Copyright reserved. This drawing and design is the property of VDZ+A and may not be reproduced or used for other projects without permission.

FORT LANGLEY STUDIO

100-9181 Church St
Fort Langley, BC
V1M 2R8

MOUNT PLEASANT STUDIO
102-355 Kingsway
Vancouver, BC
V5T 3J7

www.vdz.ca

604-882-0024

Location:

3390 & 3400 DAVID AVENUE, COQUITLAM, B.C.

Drawn:	Stamp:
BF RMK	
Checked: TM	
Approved:	Original Sheet Size:
TNA	0.48 0.08

24"x36" CONTRACTOR SHALL CHECK ALL DIMENSIONS ON THE WORK AND REPORT Scale: ANYDISCREPANCY TO THE CONSULTANT BEFORE PROCEEDING. ALL DRAWINGS AND SPECIFICATIONS ARE THE EXCLUSIVE PROPERTY OF THE OWNER AND MUST BE RETURNED AT THE COMPLETION OF THE WORK. ALL REZONING/DP/PPA/FHA/BP

DRAWINGS MUST NOT BE PRICED FOR CONSTRUCTION UNLESS LABELED ISSUED

FOR TENDER/CONSTRUCTION.

LOW MAINTENANCE PLANTING ENLARGEMENT 1

LOW MAINTENANCE PLANTING ENLARGEMENT 2 Scale 1:150

RE

2/L-

1:150 | 1:150 | 1:150

MAINTENANC

May 05, 2025

March 25, 2025

Jan 17, 2025

Dec 16, 2024

Nov 28, 2024

Jul 12, 2024 Jul 05, 2024

May 08, 2024


May 03, 2024

Apr 03, 2024

Mar 22, 2024

May 06, 2023

NORTH

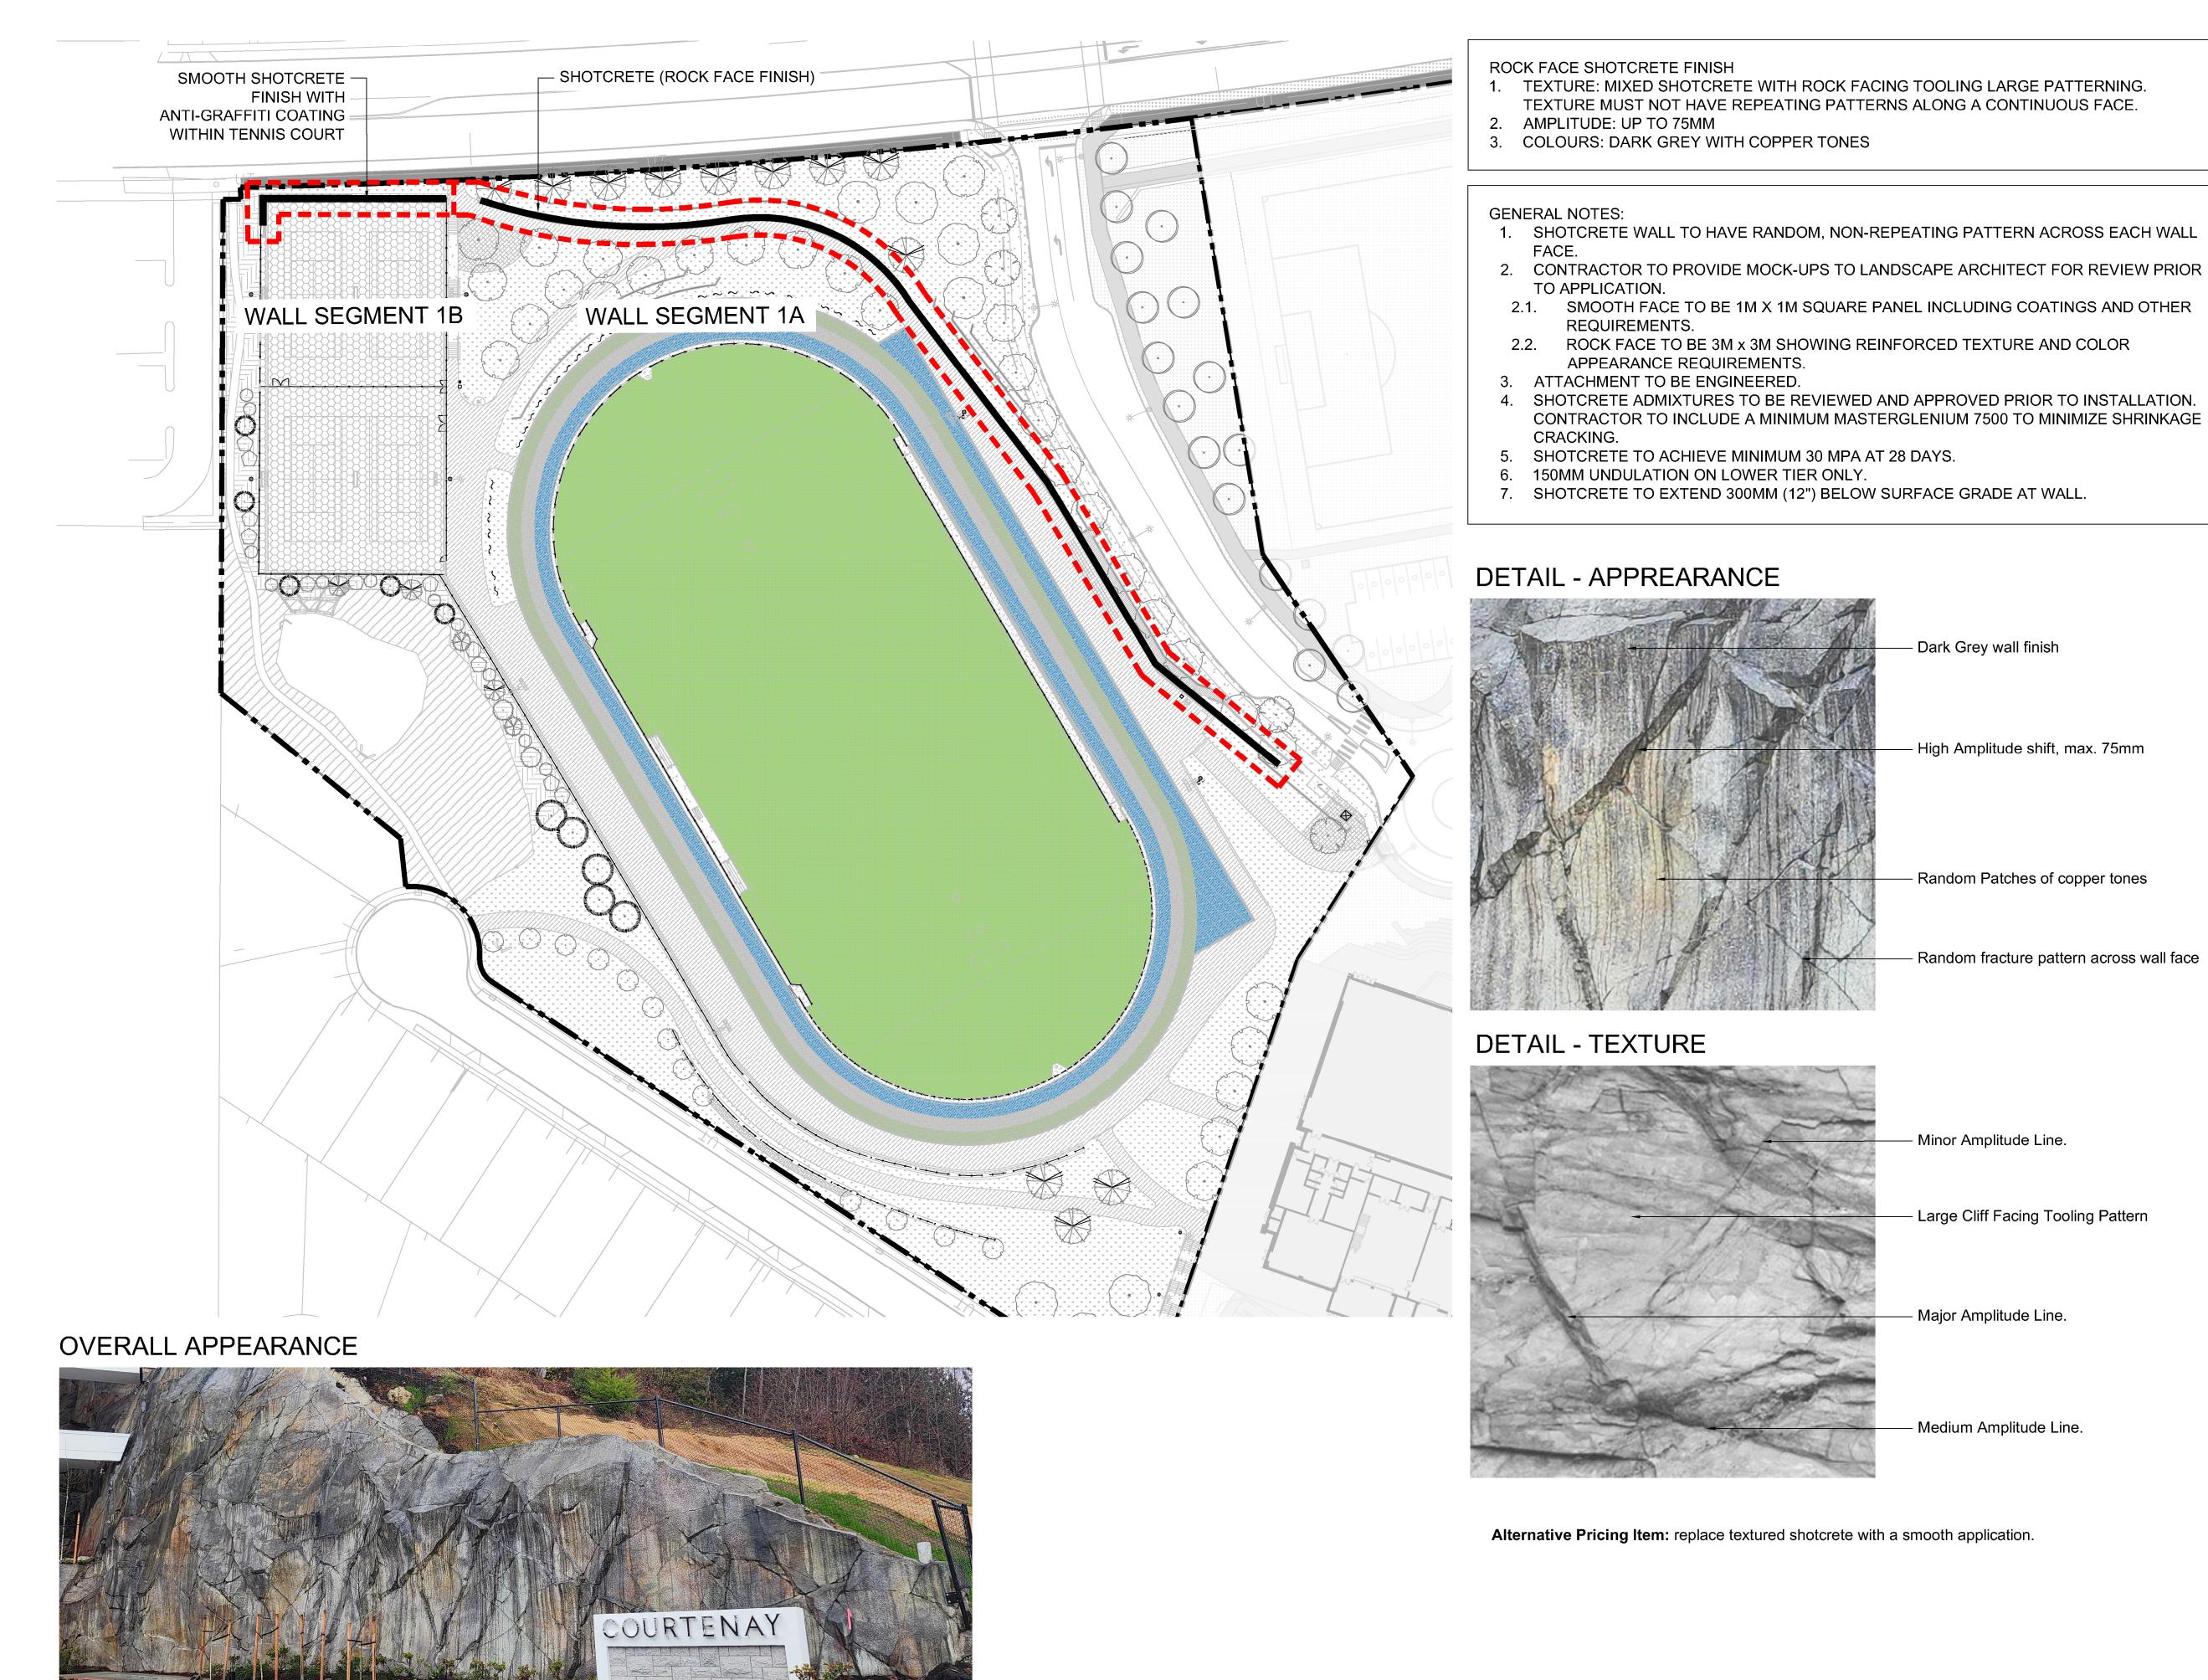

**ROCK FACE SHOTCRETE FINISH** 

- TEXTURE: MIXED SHOTCRETE WITH ROCK FACING TOOLING LARGE PATTERNING. TEXTURE MUST NOT HAVE REPEATING PATTERNS ALONG A CONTINUOUS FACE.
- 2. AMPLITUDE: UP TO 75MM
- 3. COLOURS: DARK GREY WITH COPPER TONES


### **GENERAL NOTES:**

- 1. SHOTCRETE WALL TO HAVE RANDOM, NON-REPEATING PATTERN ACROSS EACH WALL
- 2.1. SMOOTH FACE TO BE 1M X 1M SQUARE PANEL INCLUDING COATINGS AND OTHER
- 2.2. ROCK FACE TO BE 3M x 3M SHOWING REINFORCED TEXTURE AND COLOR APPEARANCE REQUIREMENTS.
- 3. ATTACHMENT TO BE ENGINEERED.


REQUIREMENTS.

- 4. SHOTCRETE ADMIXTURES TO BE REVIEWED AND APPROVED PRIOR TO INSTALLATION. CONTRACTOR TO INCLUDE A MINIMUM MASTERGLENIUM 7500 TO MINIMIZE SHRINKAGE CRACKING.
- 5. SHOTCRETE TO ACHIEVE MINIMUM 30 MPA AT 28 DAYS.
- 6. 150MM UNDULATION ON LOWER TIER ONLY.
- 7. SHOTCRETE TO EXTEND 300MM (12") BELOW SURFACE GRADE AT WALL.

### DETAIL - APPREARANCE

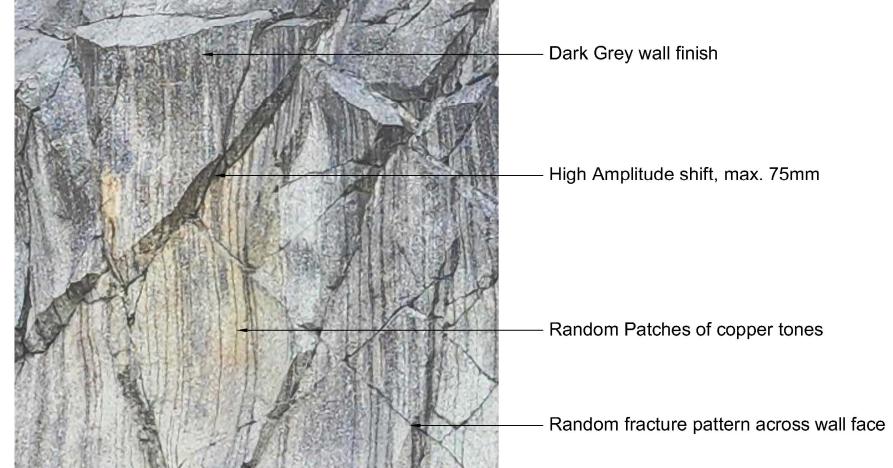

## DETAIL - TEXTURE

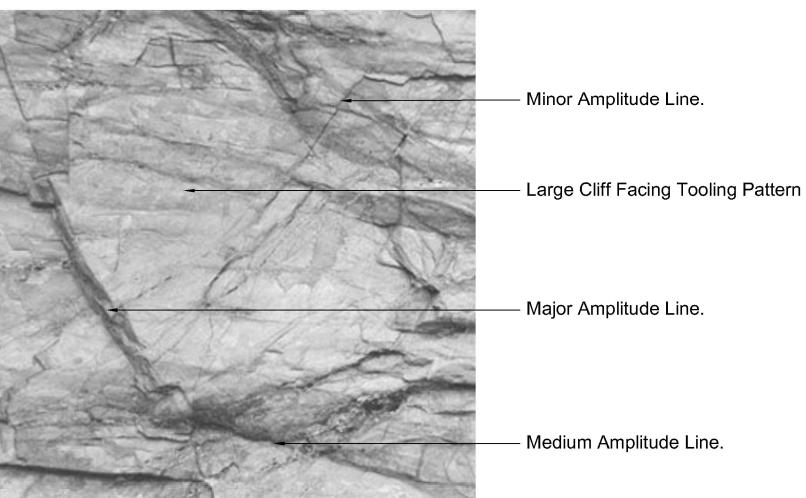

Alternative Pricing Item: replace textured shotcrete with a smooth application.



FORT LANGLEY STUDIO
100-9181 Church St
Fort Langley, BC
V1M 2R8

WOUNT PLEASANT STUDIO
102-355 Kingsway
Vancouver, BC
V5T 3J7

www.vdz.ca

2	ТМ	Issued for RFP	May 05, 2025
1	TM	Issued for 100%	March 25, 2025
0	TM	Issued for 100%	Jan 17, 2025
)	ТМ	Issued for 100% Draft	Dec 16, 2024
	TM	Issued for 95% Review	Nov 28, 2024
	TM	Issued for Costing	Jul 12, 2024
i	TM	Issued for 75% Coordination	Jul 05, 2024
i	TM	Issued for 75% Review	May 08, 2024
	TM	Issued for 75% Review	May 03, 2024
,	ТМ	Re-Issued for 50%	Apr 03, 2024
	ТМ	Issued for 50%	Mar 22, 2024
	ТМ	Issued for Review	May 06, 2023
	Ву:	Description	Date
REVISIONS TABLE FOR DRAWINGS  • Copyright reserved. This drawing and design is the property of VDZ+A and may not be reproduced or used for other projects without permission.			

NORTH

SHOTCRE

**O** #

0

Location: 3390 & 3400 DAVID AVENUE, COQUITLAM, B.C.

REVISIONS TABLE FOR SHEET

BURKE MOUNTAIN ATHLETIC PARK

Drawn:	Stamp:
SZ	
Checked:	
TM	
Approved:	Original Sheet Size:

24"x36" TM

Scale:

Project:

CONTRACTOR SHALL CHECK ALL DIMENSIONS ON THE WORK AND REPORT ANYDISCREPANCY TO THE CONSULTANT BFFORE PROCEEDING. ALL DRAWINGS
AND SPECIFICATIONS ARE THE EXCLUSIVE
PROPERTY OF THE OWNER AND MUST BE
RETURNED AT THE COMPLETION OF THE WORK. ALL REZONING/DP/PPA/FHA/BP DRAWINGS MUST NOT BE PRICED FOR CONSTRUCTION UNLESS LABELED ISSUED FOR TENDER/CONSTRUCTION.


6m 12 18 24 30 36 42 48 54 60 66 72 78 84 90

FORT LANGLEY STUDIO

100-9181 Church St
Fort Langley, BC
V1M 2R8

WOUNT PLEASANT STUDIO
102-355 Kingsway
Vancouver, BC
V5T 3J7

SPORTS FIELD SECANT WALL - ROCK FACE FINISH - SEGMENT 2A Scale 1:300

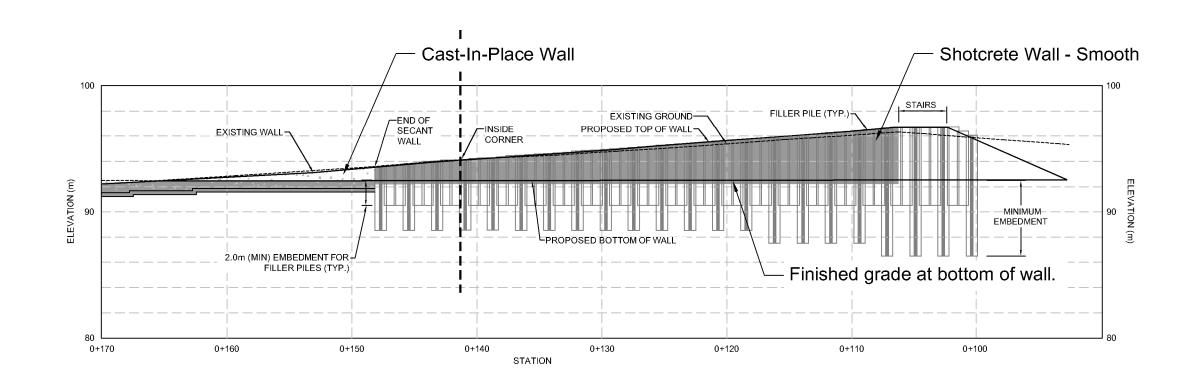

TENNIS COURT SECANT WALL - SMOOTH FACE FINISH - SEGMENT 2B Scale 1:300

12	TM	Issued for RFP	May 05, 2025
11	ТМ	Issued for 100%	March 25, 202
10	ТМ	Issued for 100%	Jan 17, 2025
9	ТМ	Issued for 100% Draft	Dec 16, 2024
8	TM	Issued for 95% Review	Nov 28, 2024
7	TM	Issued for Costing	Jul 12, 2024
6	TM	Issued for 75% Coordination	Jul 05, 2024
5	TM	Issued for 75% Review	May 08, 2024
4	ТМ	Issued for 75% Review	May 03, 2024
3	ТМ	Re-Issued for 50%	Apr 03, 2024
2	TM	Issued for 50%	Mar 22, 2024
1	ТМ	Issued for Review	May 06, 2023
No.	Ву:	Description	Date

VDZ+A and may not be reproduced or used for other projects without permission. REVISIONS TABLE FOR SHEET

Project:

BURKE MOUNTAIN ATHLETIC PARK

Location:

3390 & 3400 DAVID AVENUE, COQUITLAM, B.C.

Drawn:	Stamp:
SZ	
	- /-
Checked: TM	
Approved:	Original Sheet Size:
TM	24"v26"

Scale: AS SHOWN

24"x36" CONTRACTOR SHALL CHECK ALL
DIMENSIONS ON THE WORK AND REPORT
ANYDISCREPANCY TO THE CONSULTANT
BEFORE PROCEEDING. ALL DRAWINGS
AND SPECIFICATIONS ARE THE EXCLUSIVE
PROPERTY OF THE OWNER AND MUST BE
RETURNED AT THE COMPLETION OF THE
WORK. ALL REZONING/DP/PPA/FHA/BP
DRAWINGS MUST NOT BE PRICED FOR
CONSTRUCTION UNLESS LABELED ISSUED
FOR TENDER/CONSTRUCTION.

VDZ Project #:
PR20,

07



FORT LANGLEY STUDIO

100-9181 Church St
Fort Langley, BC
V1M 2R8

WOUNT PLEASANT STUDIO
102-355 Kingsway
Vancouver, BC
V5T 3J7 604-882-0024

> May 05, 2025 March 25, 2025 Jan 17, 2025 Dec 16, 2024 Nov 28, 2024 Jul 12, 2024 Jul 05, 2024 May 08, 2024 May 03, 2024 SINN Apr 03, 2024 Mar 22, 2024 May 06, 2023

BURKE MOUNTAIN ATHLETIC PARK

3390 & 3400 DAVID AVENUE, COQUITLAM, B.C.


Orawn:	Stamp:
3F	
Checked: ΓΜ	
Approved:	Original Sheet Size:
ГΜ	24"x36"

CONTRACTOR SHALL CHECK ALL
DIMENSIONS ON THE WORK AND REPORT
ANYDISCREPANCY TO THE CONSULTANT
BEFORE PROCEEDING. ALL DRAWINGS
AND SPECIFICATIONS ARE THE EXCLUSIVE
PROPERTY OF THE OWNER AND MUST BE RETURNED AT THE COMPLETION OF THE WORK. ALL REZONING/DP/PPA/FHA/BP DRAWINGS MUST NOT BE PRICED FOR CONSTRUCTION UNLESS LABELED ISSUED FOR TENDER/CONSTRUCTION.

VDZ Project #: PR20,

 $\infty$ 

O

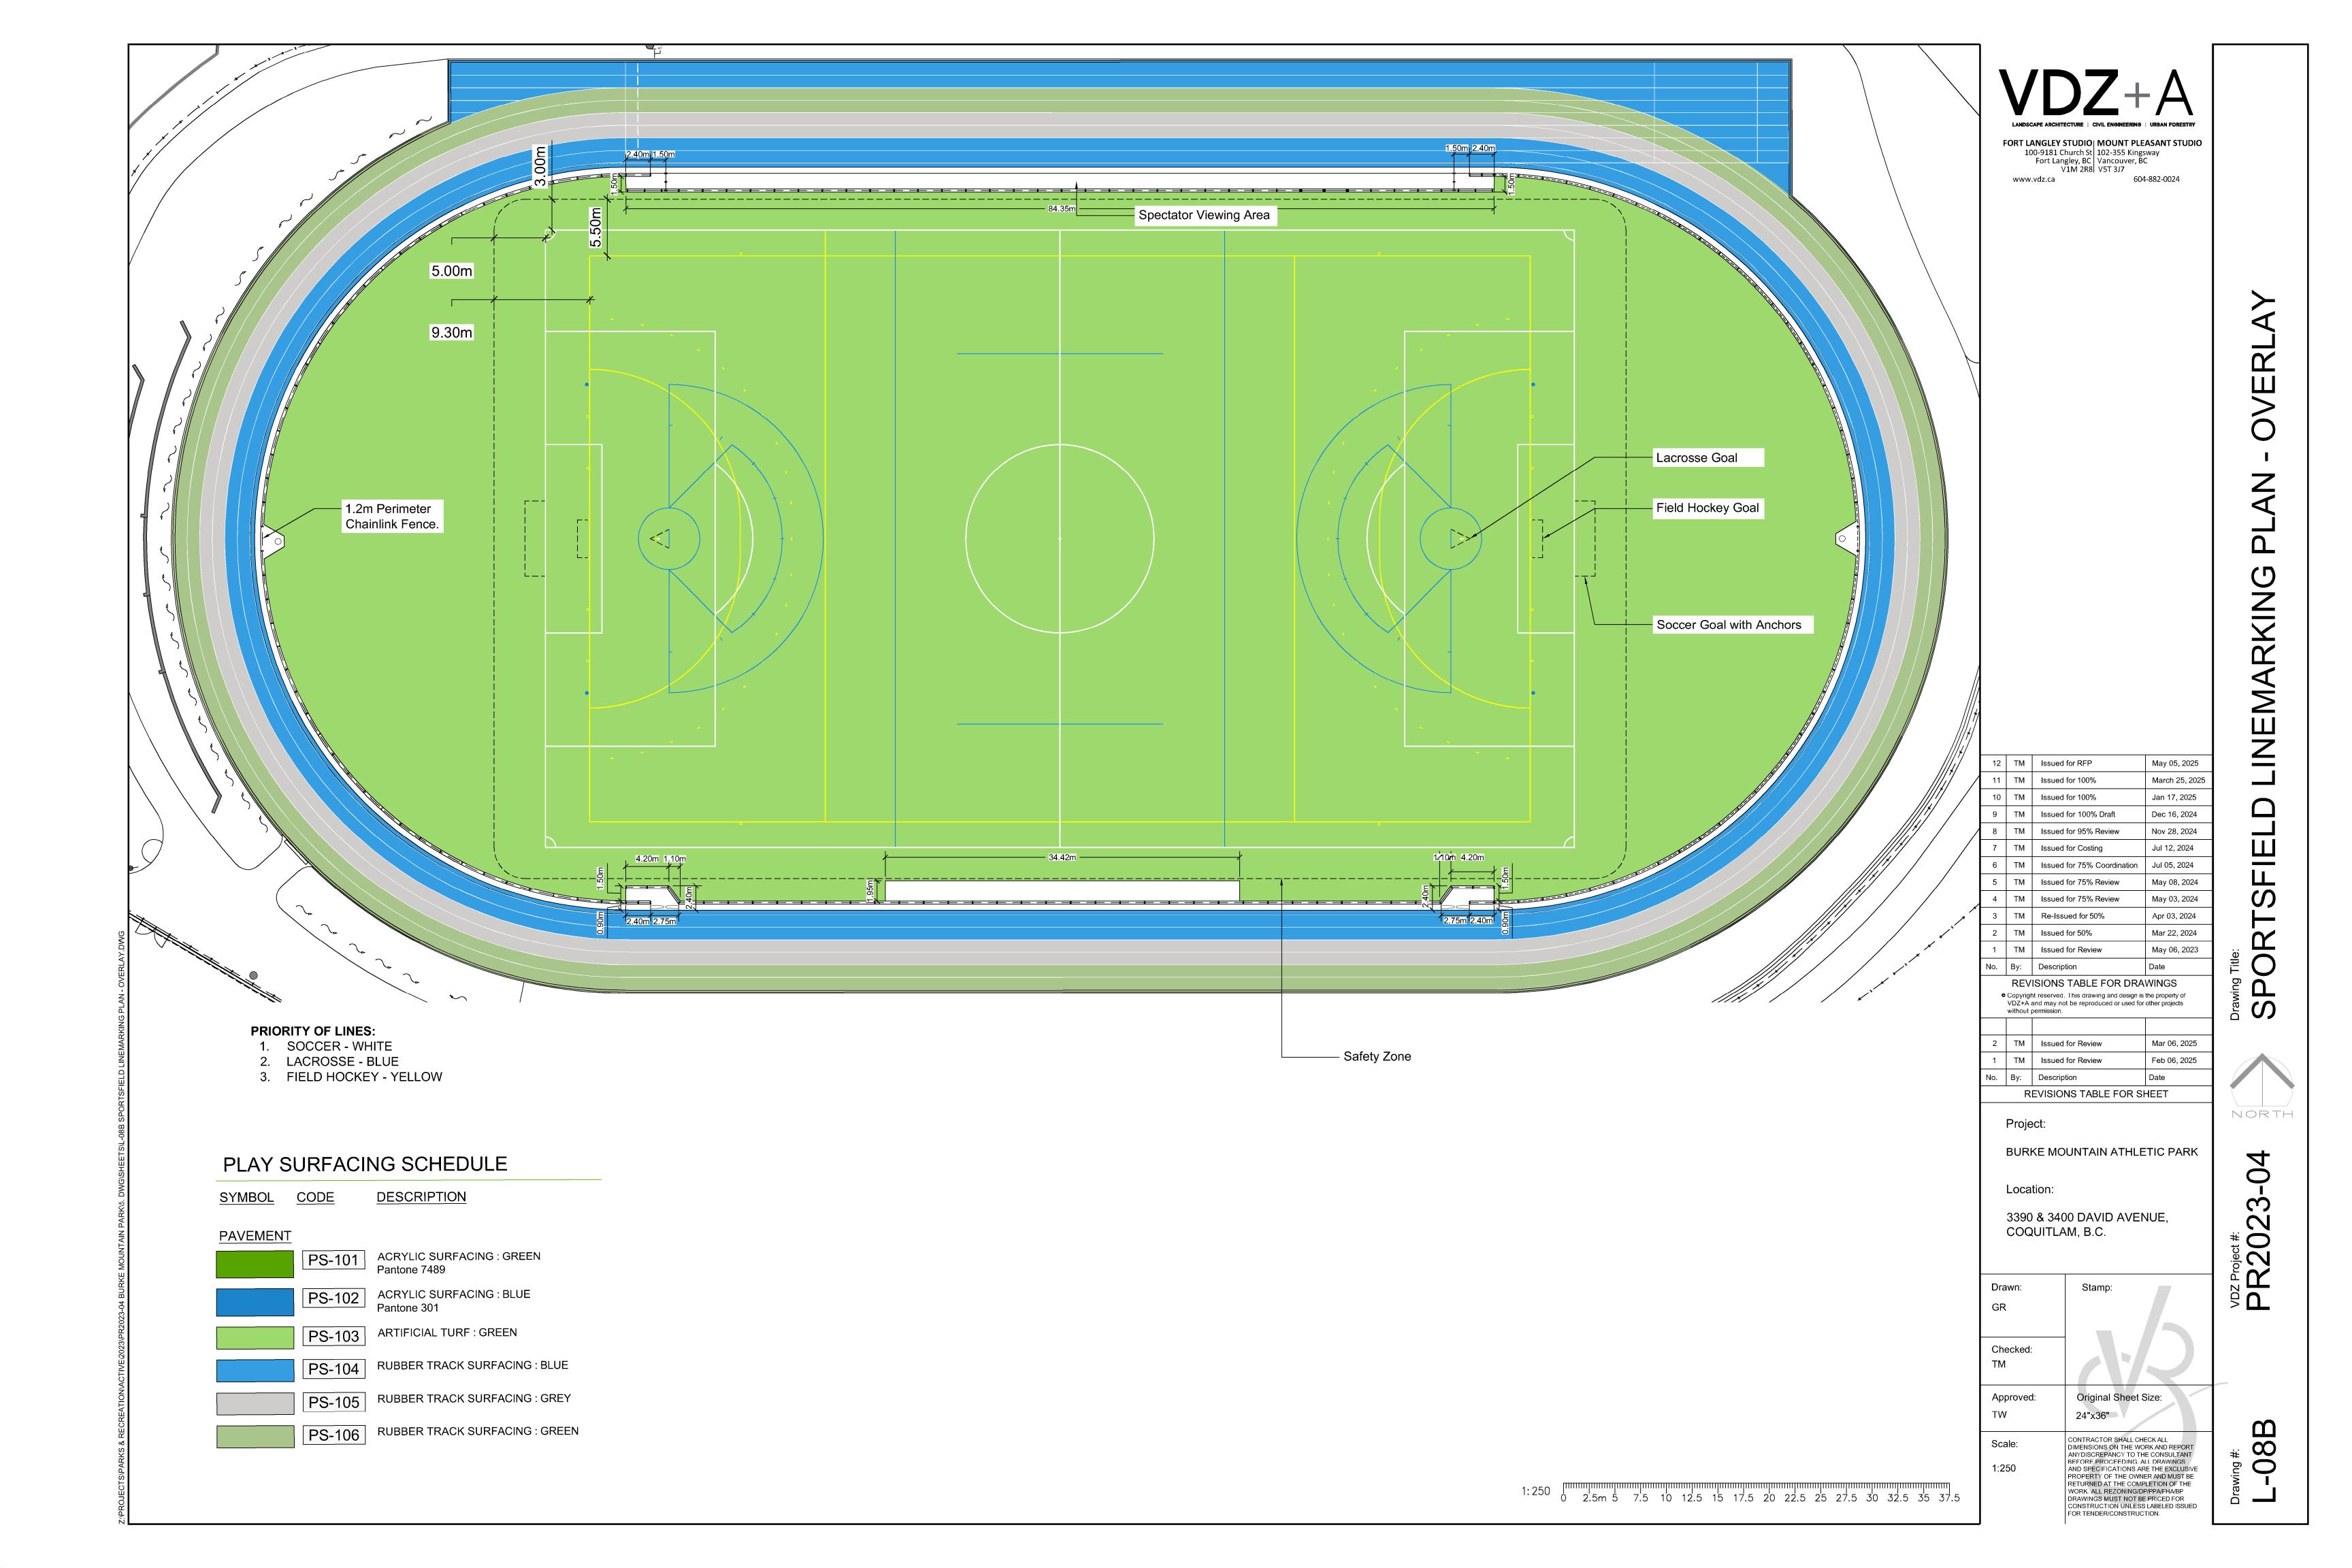



FORT LANGLEY STUDIO

100-9181 Church St
Fort Langley, BC
V1M 2R8

MOUNT PLEASANT STUDIO
102-355 Kingsway
Vancouver, BC
V5T 3J7

www.vdz.ca

INDIVIDUAL

INEMARKING

12 TM Issued for RFP May 05, 2025 11 TM Issued for 100% March 25, 2025 Jan 17, 2025 10 TM Issued for 100% Dec 16, 2024 9 TM Issued for 100% Draft 8 TM Issued for 95% Review Nov 28, 2024 TM Issued for Costing Jul 12, 2024 6 TM Issued for 75% Coordination Jul 05, 2024 5 TM Issued for 75% Review May 08, 2024 4 TM Issued for 75% Review May 03, 2024 3 TM Re-Issued for 50% Apr 03, 2024 2 TM Issued for 50% Mar 22, 2024 1 TM Issued for Review May 06, 2023 REVISIONS TABLE FOR DRAWINGS Copyright reserved. This drawing and design is the property of VDZ+A and may not be reproduced or used for other projects without permission.

BURKE MOUNTAIN ATHLETIC PARK

Mar 06, 2025 Feb 02, 2025

Location:

3390 & 3400 DAVID AVENUE, COQUITLAM, B.C.

Drawn:	Stamp:
GR	
Checked: TM	
Approved:	Original Sheet Size:
TW	24"x36"
Scale:	CONTRACTOR SHALL CHECK ALL DIMENSIONS ON THE WORK AND REPORT ANYDISCREPANCY TO THE CONSULTANT
1:400	BEFORE PROCEEDING. ALL DRAWINGS AND SPECIFICATIONS ARE THE EXCLUSIVE PROPERTY OF THE OWNER AND MUST BE RETURNED AT THE COMPLETION OF THE


WORK. ALL REZONING/DP/PPA/FHA/BP


FOR TENDER/CONSTRUCTION.


DRAWINGS MUST NOT BE PRICED FOR CONSTRUCTION UNLESS LABELED ISSUED

08


VDZ Project #: PR20,

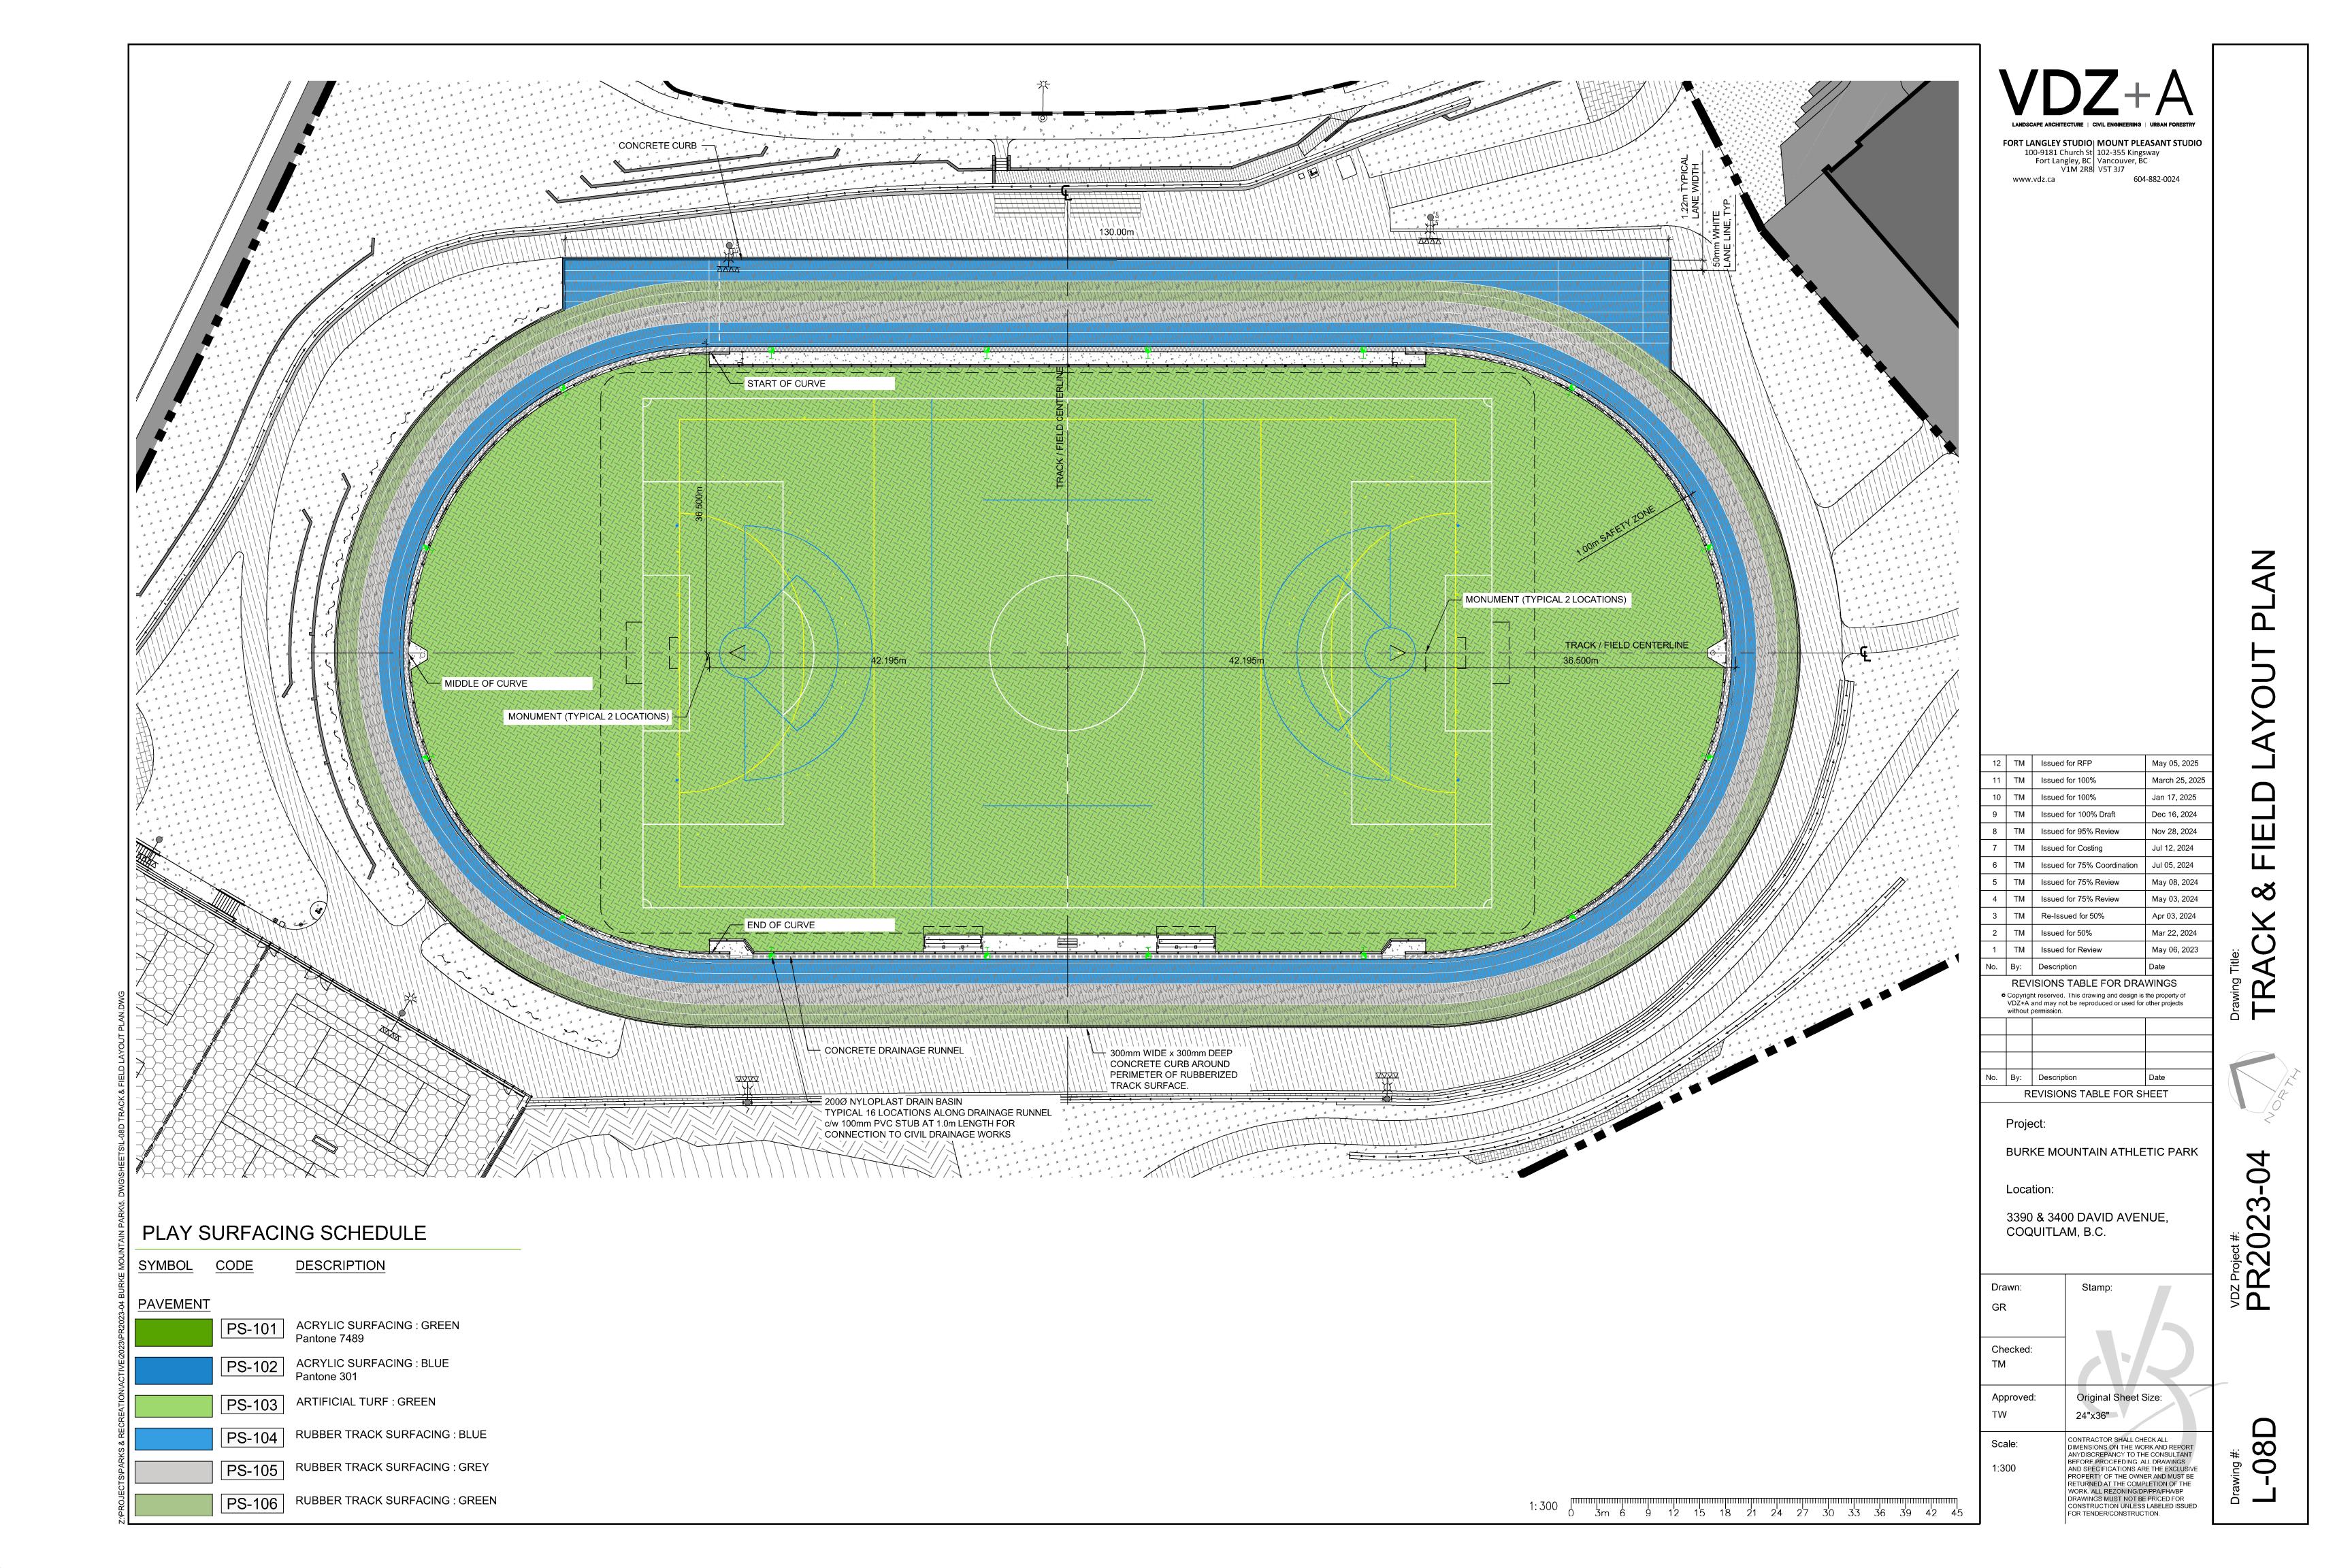

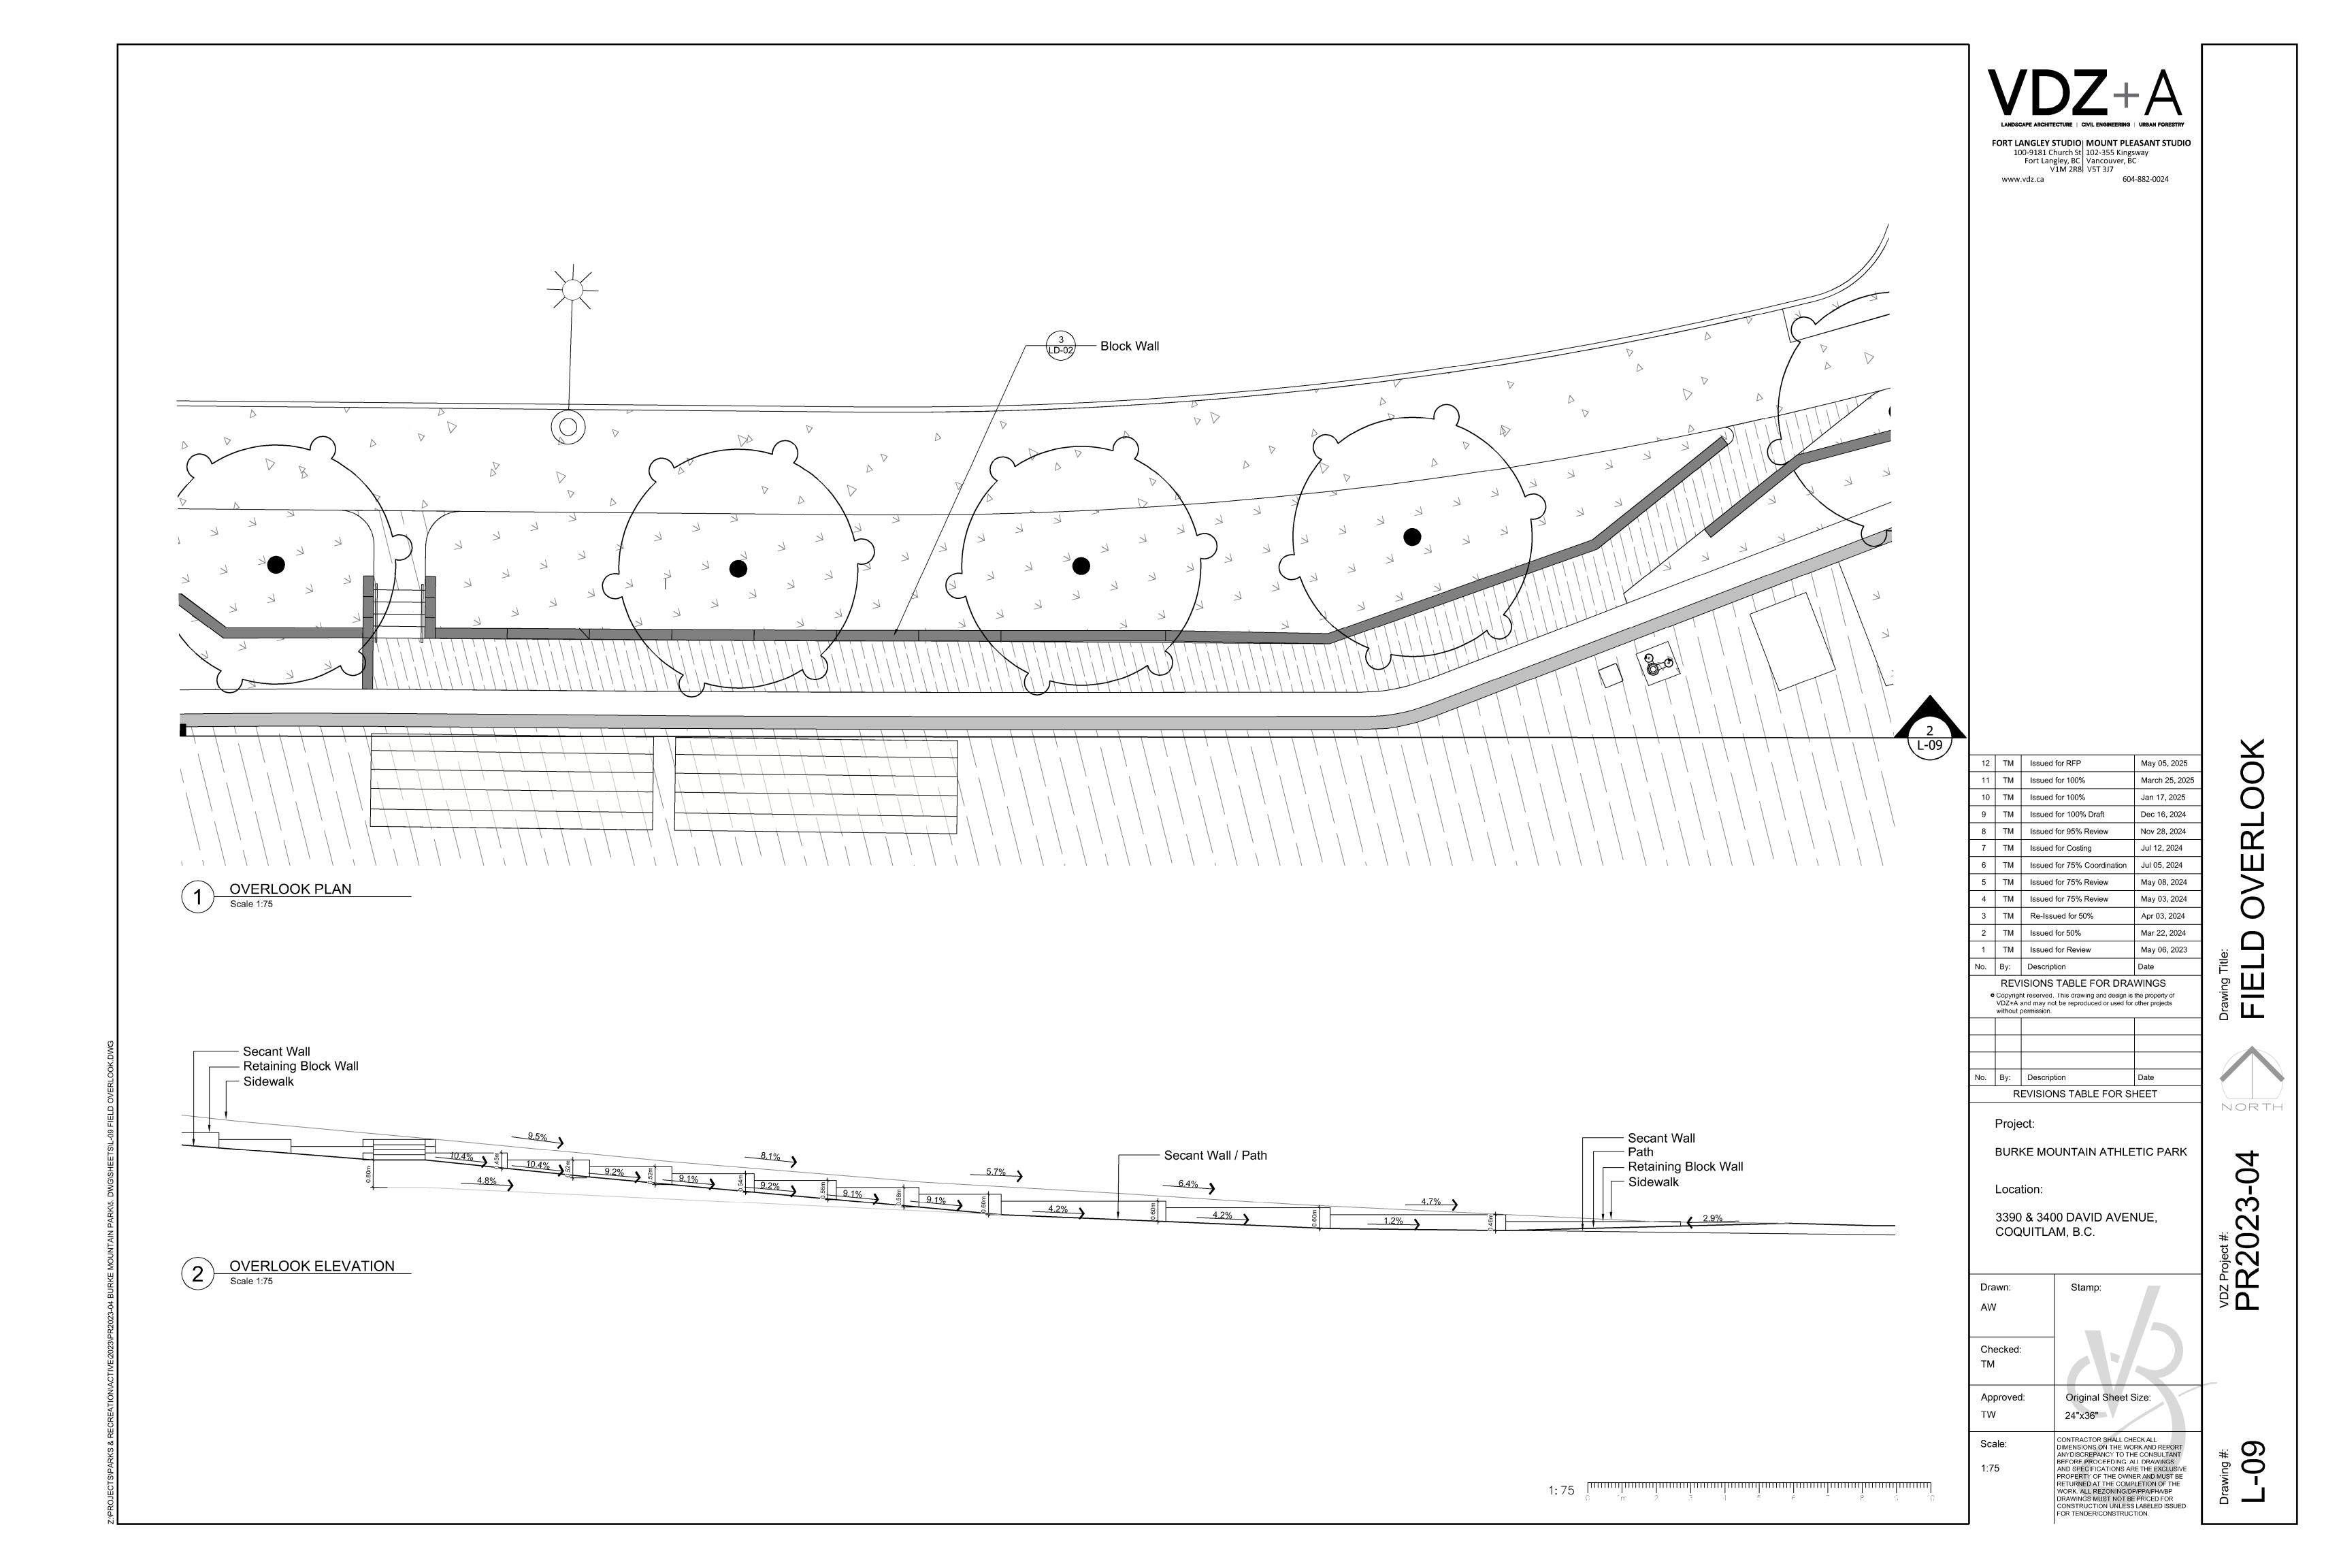

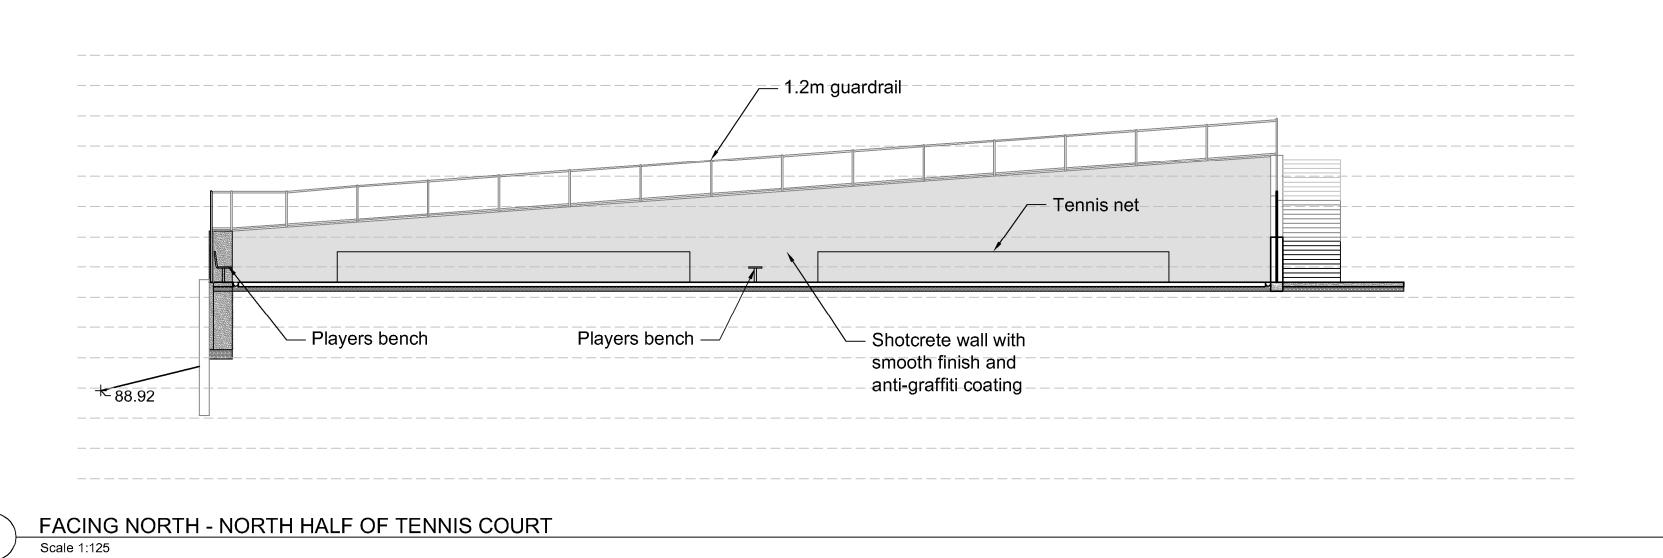

SITE PLAN
Scale 1:400

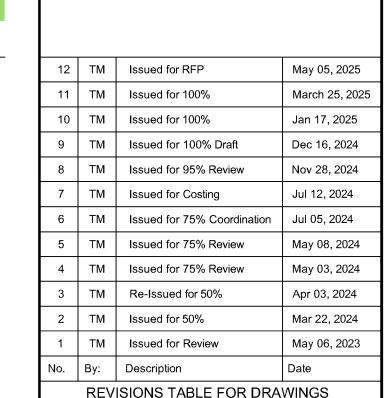

FORT LANGLEY STUDIO
100-9181 Church St
Fort Langley, BC
V1M 2R8

MOUNT PLEASANT STUDIO
102-355 Kingsway
Vancouver, BC
V5T 3J7

www.vdz.ca

604-882-0024

REVISIONS TABLE FOR DRAWINGS Copyright reserved. This drawing and design is the property of VDZ+A and may not be reproduced or used for other projects without permission.

No. By: Description REVISIONS TABLE FOR SHEET Project:

NORTH

VDZ Project #: PR20,

0

BURKE MOUNTAIN ATHLETIC PARK


Location:

3390 & 3400 DAVID AVENUE, COQUITLAM, B.C.


Drawn: BF Checked: TM	Stamp:	
Approved:	Original Sheet Size: 24"x36"	
Scale: AS SHOWN	CONTRACTOR SHALL CHECK ALL DIMENSIONS ON THE WORK AND REPORT ANYDISCREPANCY TO THE CONSULTANT BEFORE PROCEEDING. ALL DRAWINGS AND SPECIFICATIONS ARE THE EXCLUSIVE PROPERTY OF THE OWNER AND MUST BE RETURNED AT THE COMPLETION OF THE WORK. ALL REZONING/DP/PPA/FHA/BP DRAWINGS MUST NOT BE PRICED FOR CONSTRUCTION UNLESS LABELED ISSUED FOR TENDER/CONSTRUCTION.	


92.57 TW -\ Existing retaining wall


FACING NORTH - SOUTH HALF OF TENNIS COURT
Scale 1:125

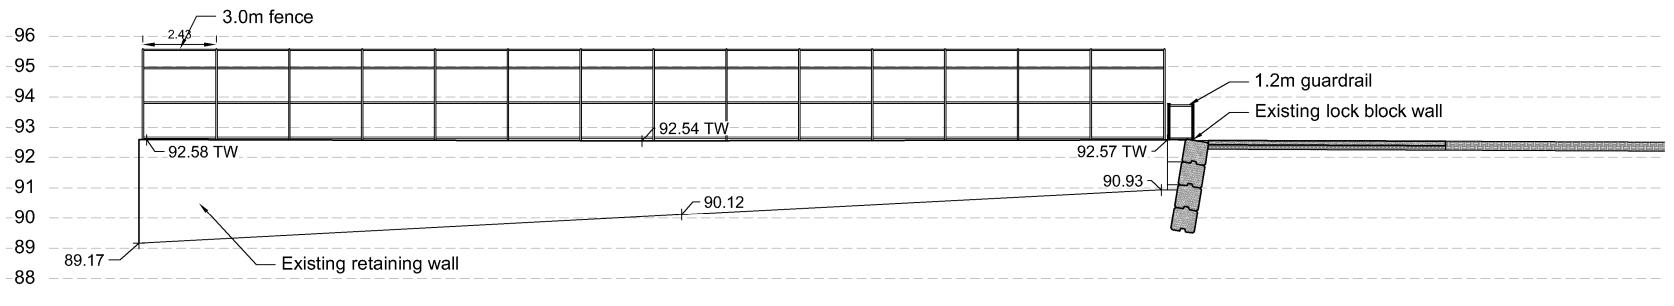



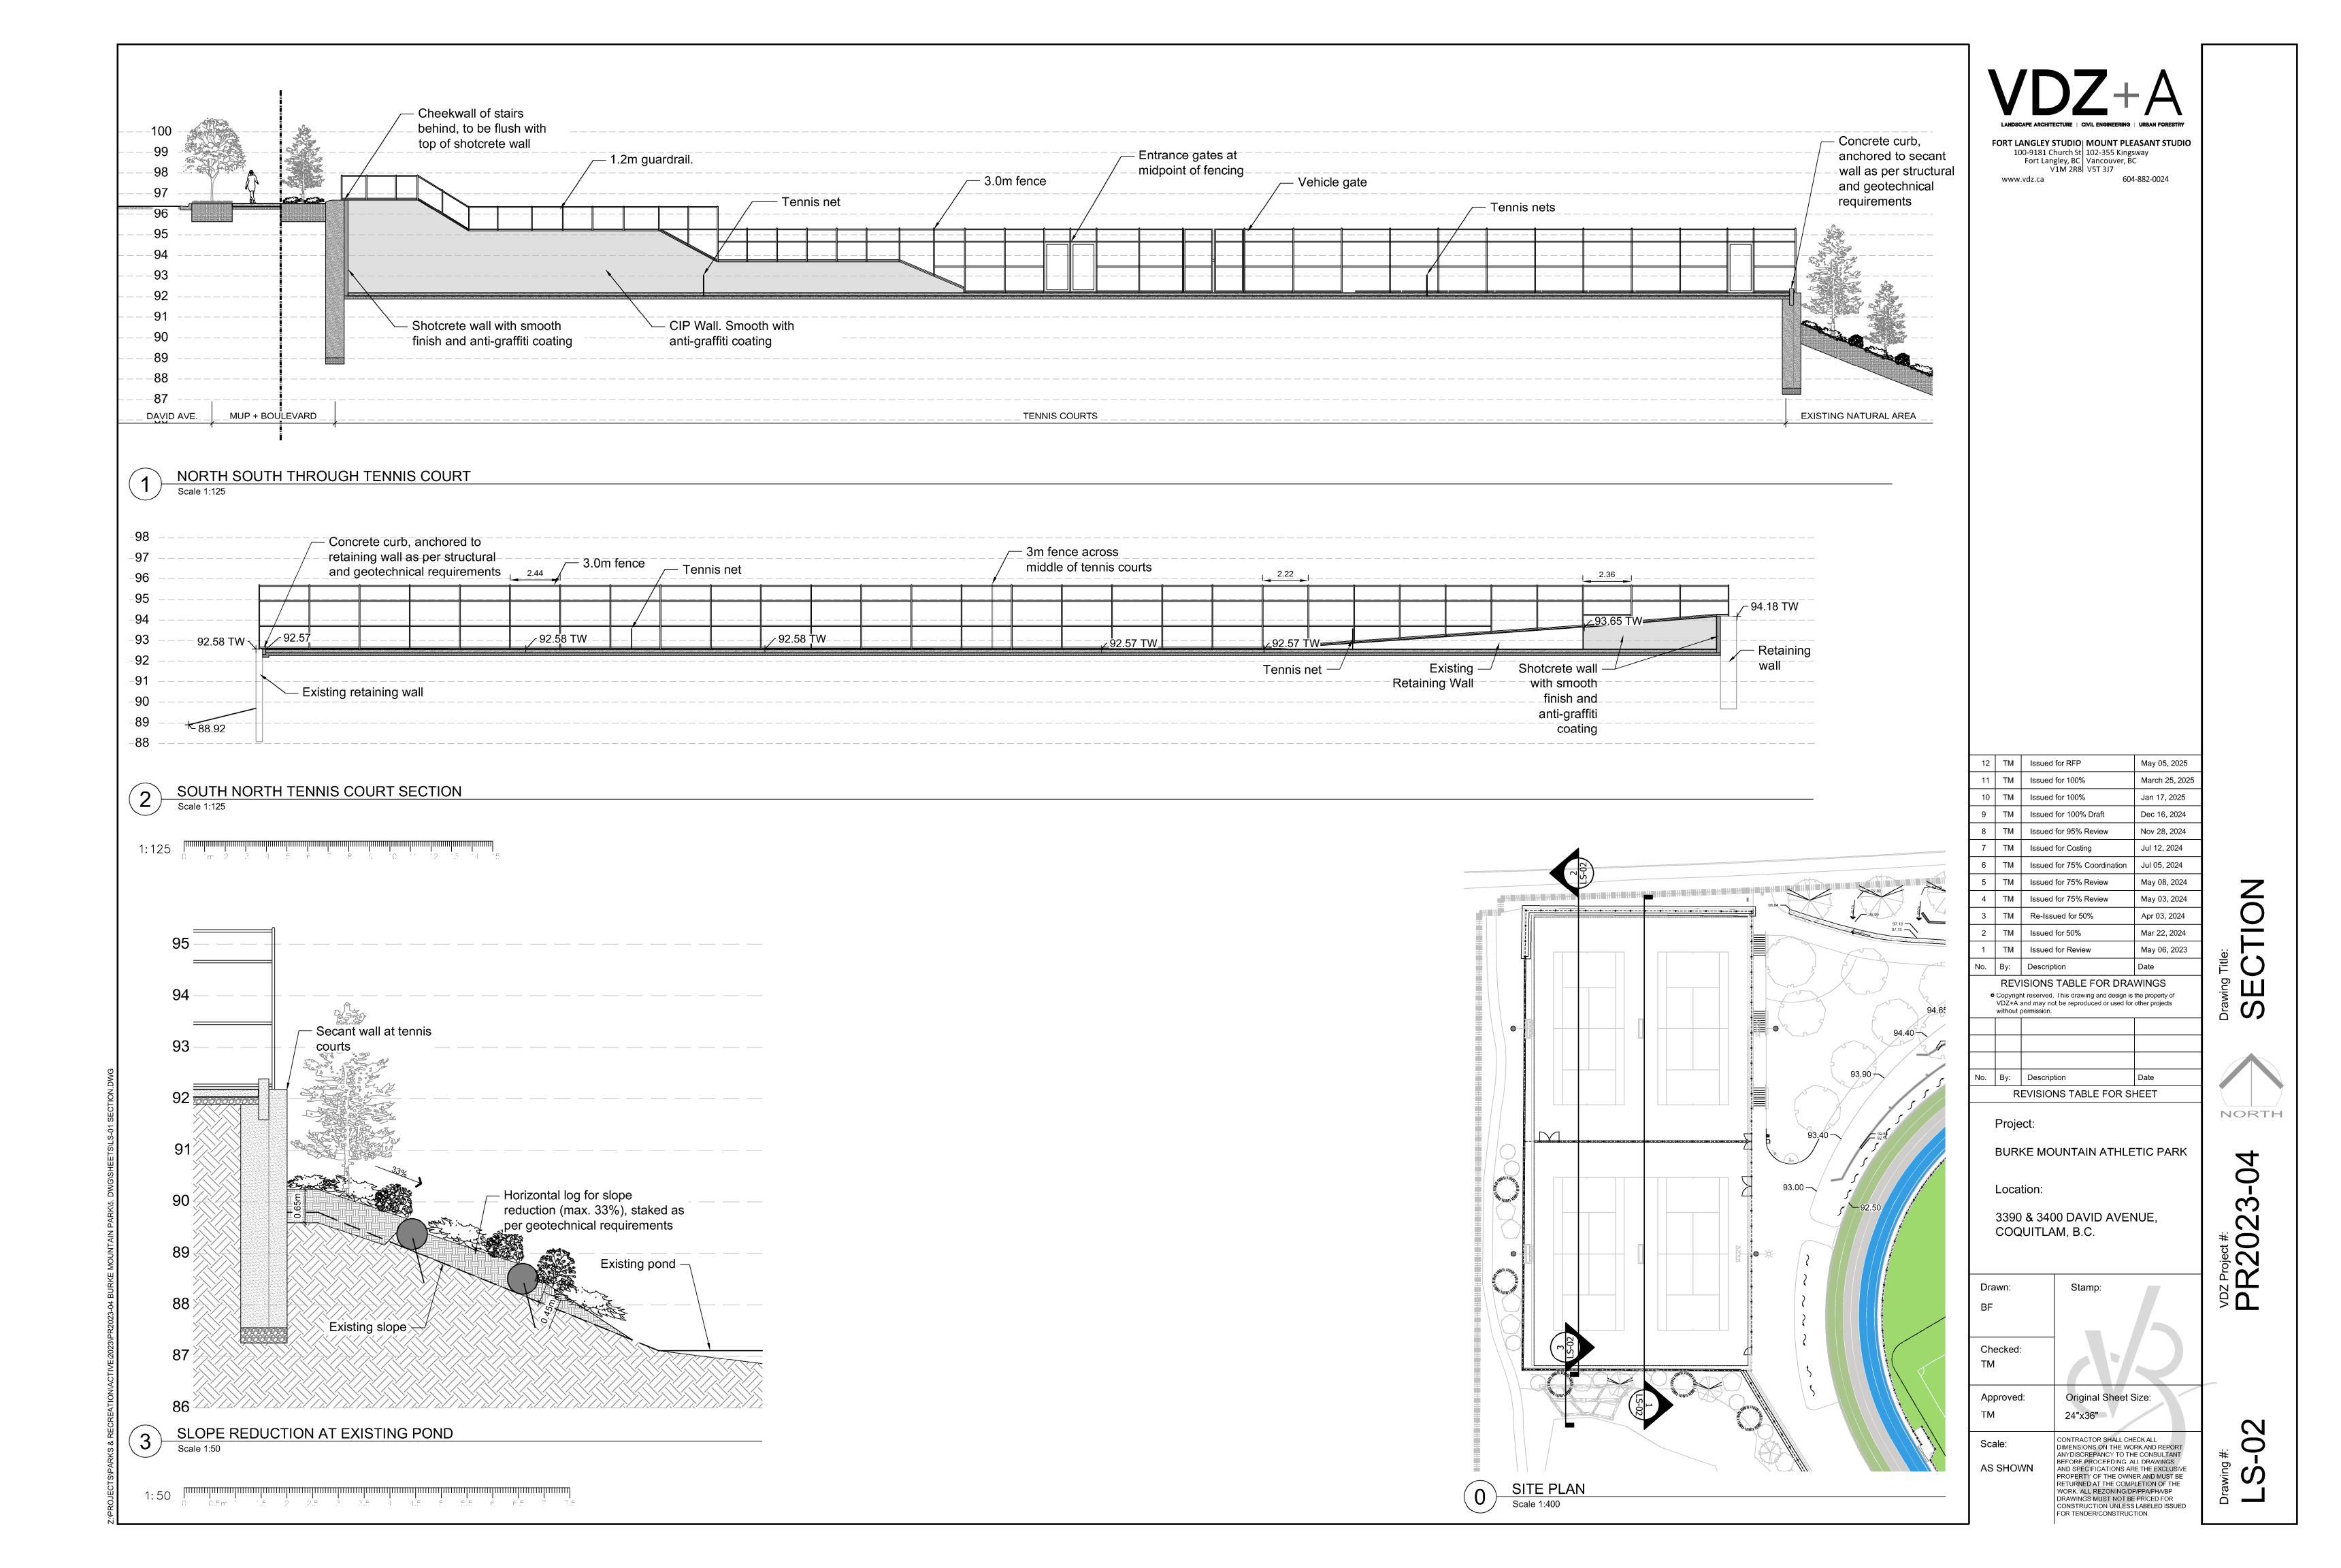

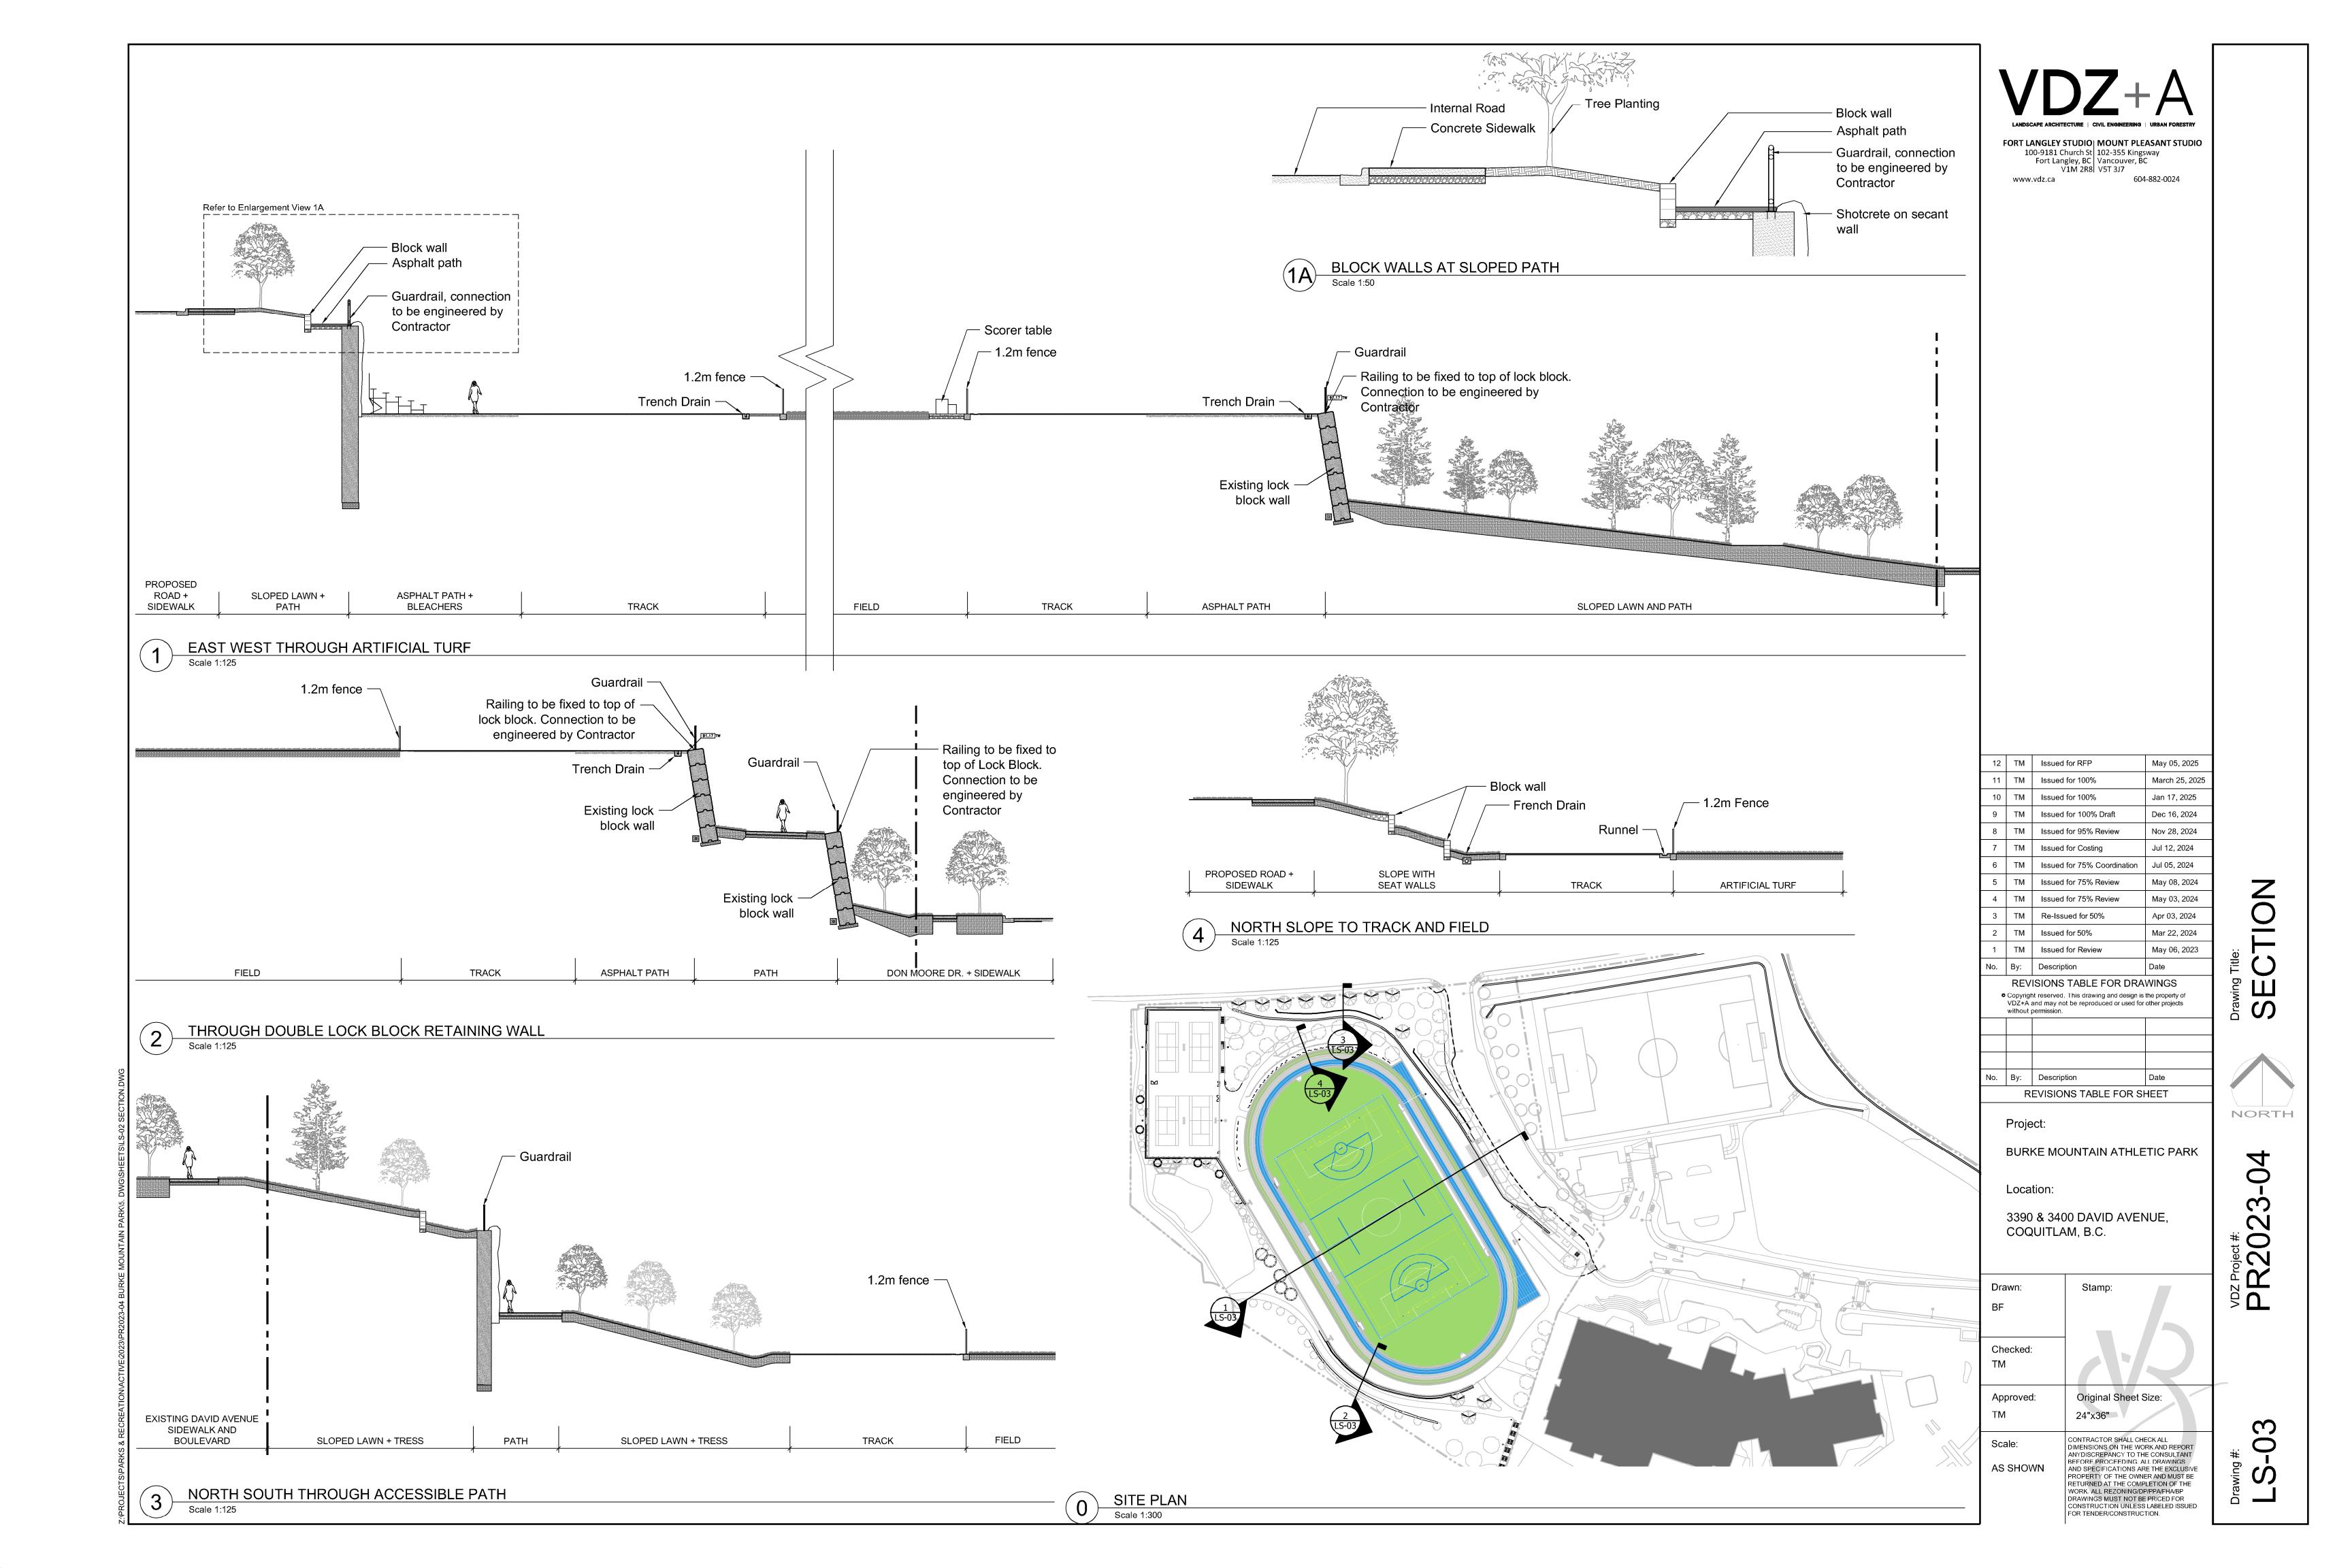

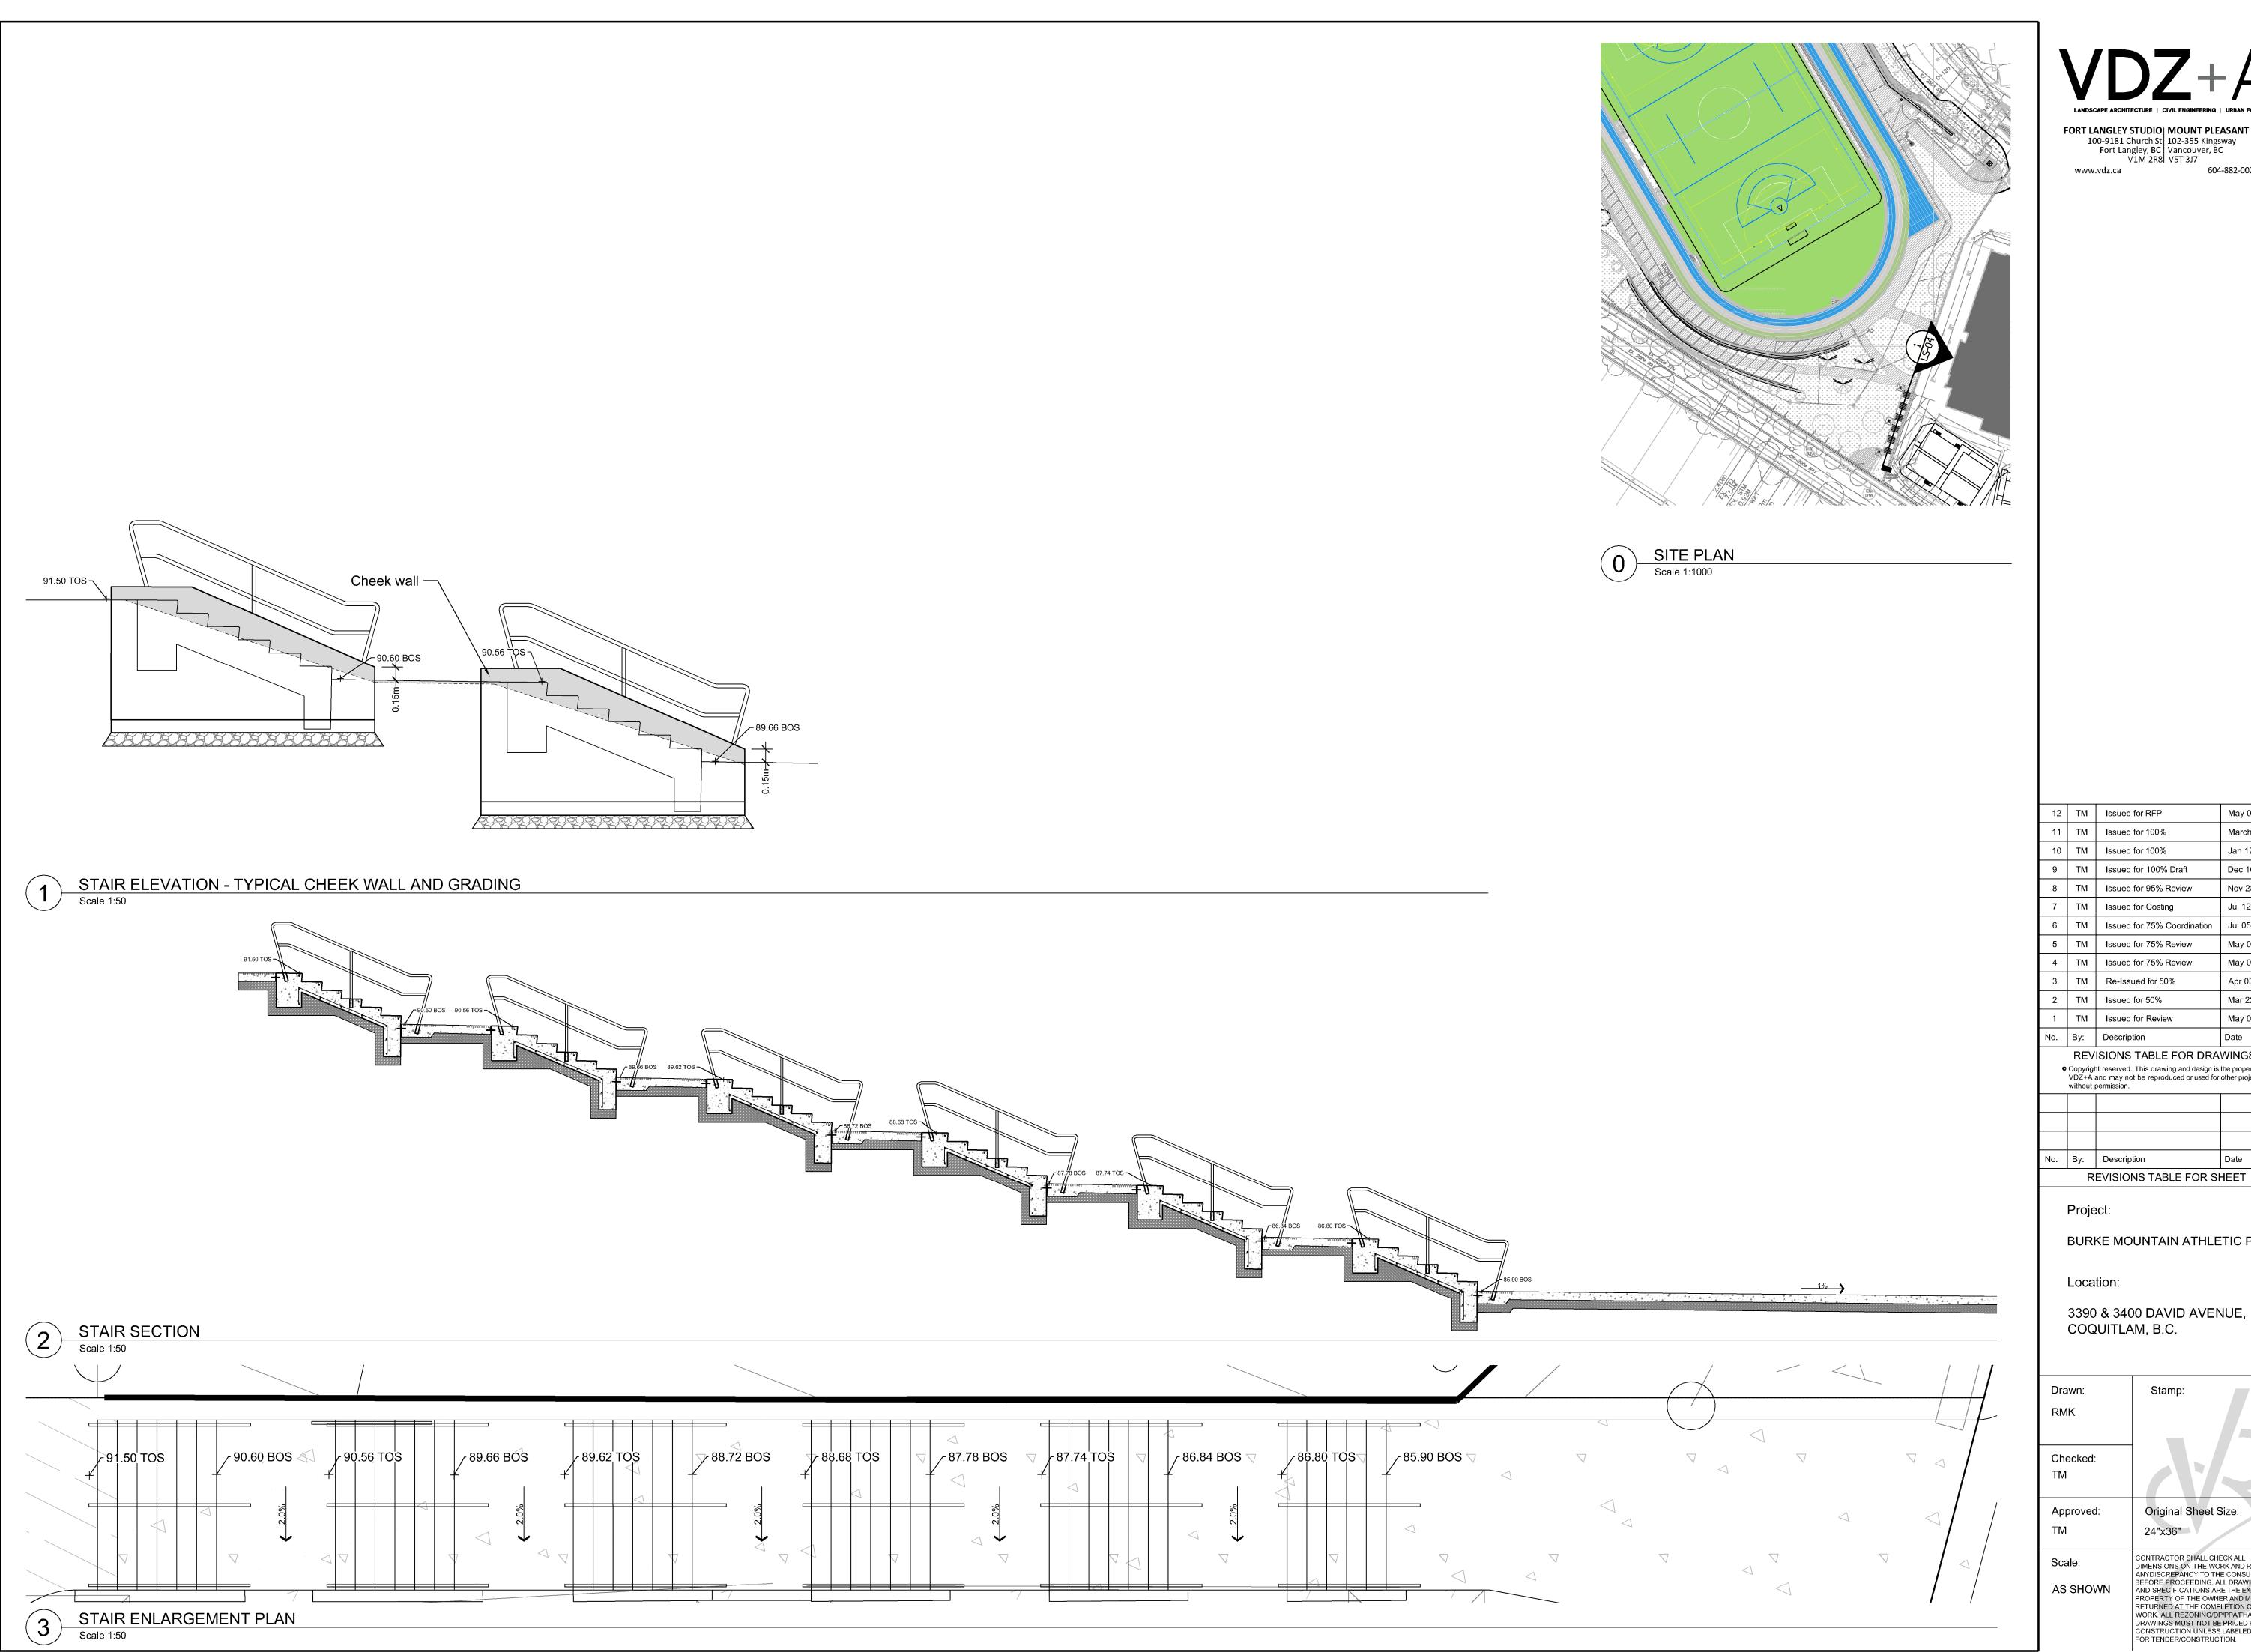



604-882-0024

12 TM Issued for RFP 11 TM Issued for 100% 10 TM Issued for 100% 9 TM Issued for 100% Draft 8 TM Issued for 95% Review 7 TM Issued for Costing 6 TM Issued for 75% Coordination Jul 05, 2024 5 TM Issued for 75% Review 4 TM Issued for 75% Review 3 TM Re-Issued for 50% 2 TM Issued for 50% 1 | TM | Issued for Review lo. By: Description REVISIONS TABLE FOR DRAWINGS Copyright reserved. This drawing and design is the property of VDZ+A and may not be reproduced or used for other projects without permission. No. By: Description REVISIONS TABLE FOR SHEET Project: BURKE MOUNTAIN ATHLETIC PARK

May 05, 2025

March 25, 2025 Jan 17, 2025

Dec 16, 2024

Nov 28, 2024

Jul 12, 2024

May 08, 2024

May 03, 2024

Apr 03, 2024

Mar 22, 2024

May 06, 2023

VDZ Project #:
PR20,

CTION


0

Original Sheet Size:

CONTRACTOR SHALL CHECK ALL DIMENSIONS ON THE WORK AND REPORT

DIMENSIONS ON THE WORK AND REPORT ANYDISCREPANCY TO THE CONSULTANT BEFORE PROCEEDING. ALL DRAWINGS AND SPECIFICATIONS ARE THE EXCLUSIVE PROPERTY OF THE OWNER AND MUST BE RETURNED AT THE COMPLETION OF THE WORK. ALL REZONING/DP/PPA/FHA/BP DRAWINGS MUST NOT BE PRICED FOR CONSTRUCTION UNLESS LABELED ISSUED FOR TENDER/CONSTRUCTION.

24"x36"

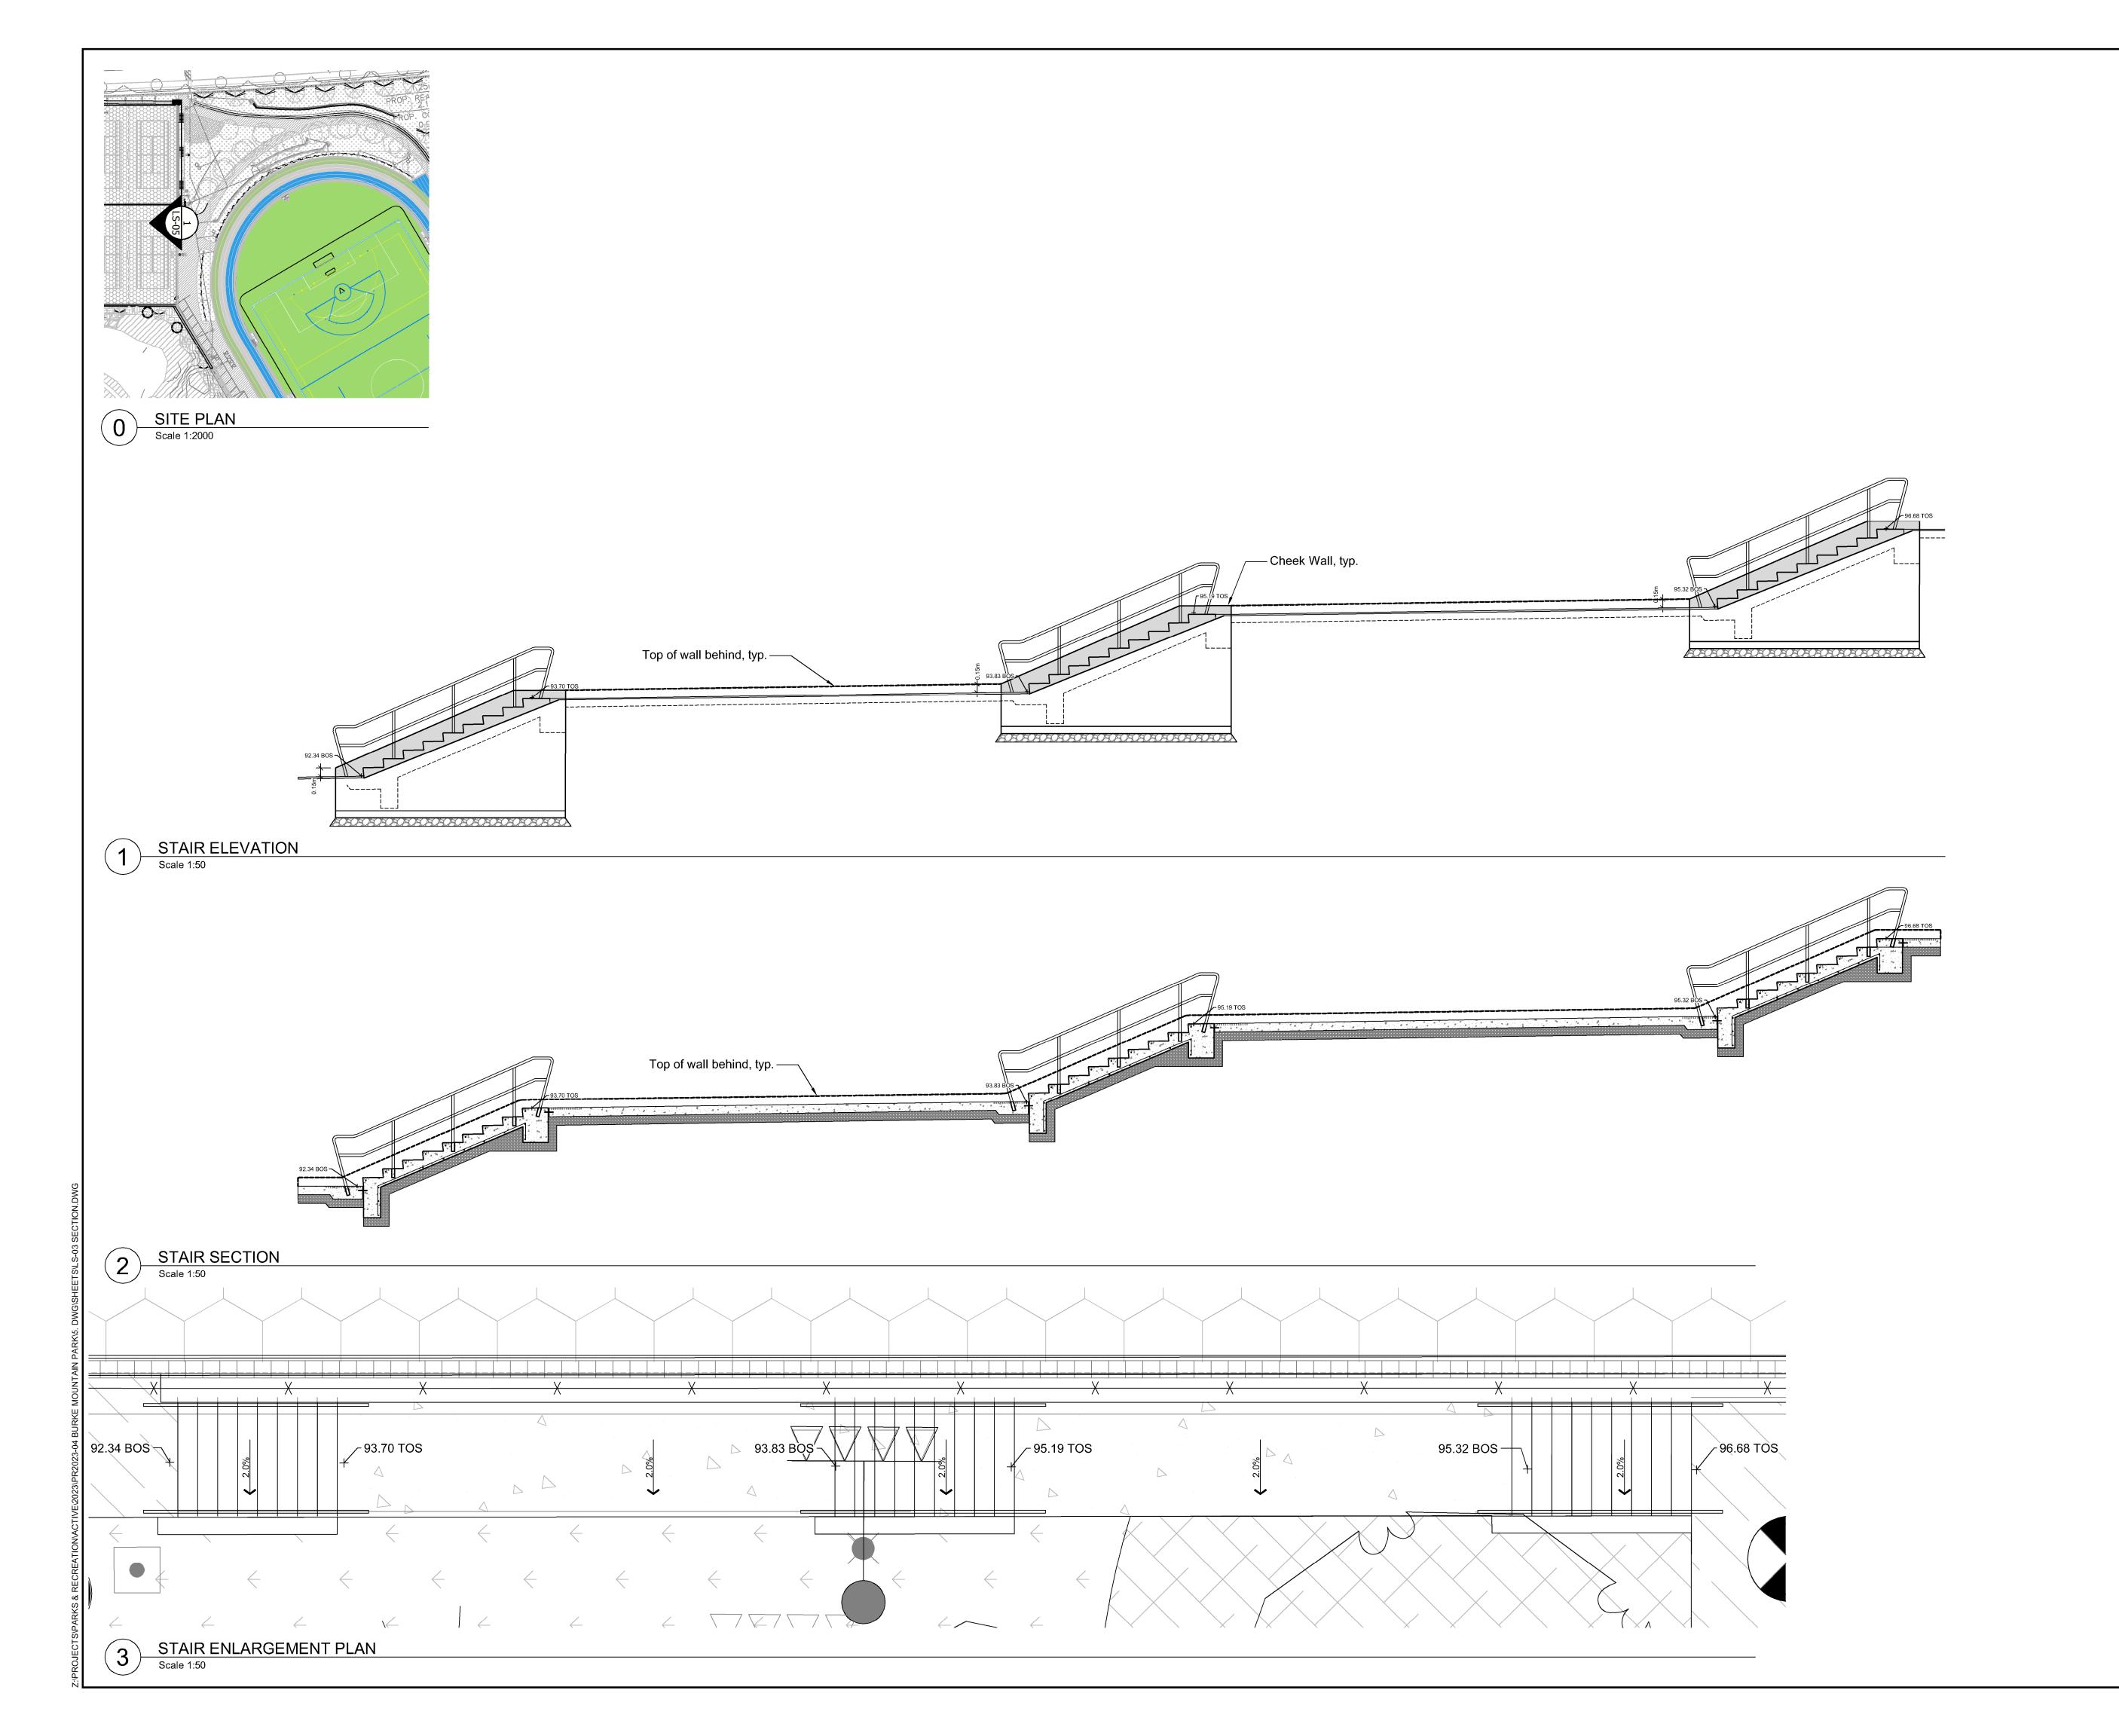



FORT LANGLEY STUDIO

100-9181 Church St
Fort Langley, BC
V1M 2R8

WOUNT PLEASANT STUDIO
102-355 Kingsway
Vancouver, BC
V5T 3J7 604-882-0024 www.vdz.ca

12	ТМ	Issued for RFP	May 05, 2025		
11	ТМ	Issued for 100%	March 25, 2025		
10	ТМ	Issued for 100%	Jan 17, 2025		
9	TM	Issued for 100% Draft	Dec 16, 2024		
8	TM	Issued for 95% Review	Nov 28, 2024		
7	TM	Issued for Costing	Jul 12, 2024		
6	TM	Issued for 75% Coordination	Jul 05, 2024		
5	TM	Issued for 75% Review	May 08, 2024		
4	ТМ	Issued for 75% Review	May 03, 2024		
3	ТМ	Re-Issued for 50%	Apr 03, 2024		
2	ТМ	Issued for 50%	Mar 22, 2024		
1	TM	Issued for Review	May 06, 2023		
).	Ву:	Description	Date		
	REVISIONS TABLE FOR DRAWINGS				
0	<ul> <li>Copyright reserved. This drawing and design is the property of VDZ+A and may not be reproduced or used for other projects without permission.</li> </ul>				
).	Ву:	Description	Date		
	REVISIONS TABLE FOR SHEET				
	Project:				
	BURI	KE MOUNTAIN ATHLE	TIC PARK		

Location:

Drawn:

Checked:

Approved:

AS SHOWN

Scale:

TM

RMK

COQUITLAM, B.C.

3390 & 3400 DAVID AVENUE,

Original Sheet Size:


CONTRACTOR SHALL CHECK ALL
DIMENSIONS ON THE WORK AND REPORT
ANYDISCREPANCY TO THE CONSULTANT
BEFORE PROCEEDING. ALL DRAWINGS
AND SPECIFICATIONS ARE THE EXCLUSIVE
PROPERTY OF THE OWNER AND MUST BE
RETURNED AT THE COMPLETION OF THE
WORK. ALL REZONING/DP/PPA/FHA/BP
DRAWINGS MUST NOT BE PRICED FOR
CONSTRUCTION UNLESS LABELED ISSUED
FOR TENDER/CONSTRUCTION.


24"x36"

0

CTION

VDZ Project #: PR20,

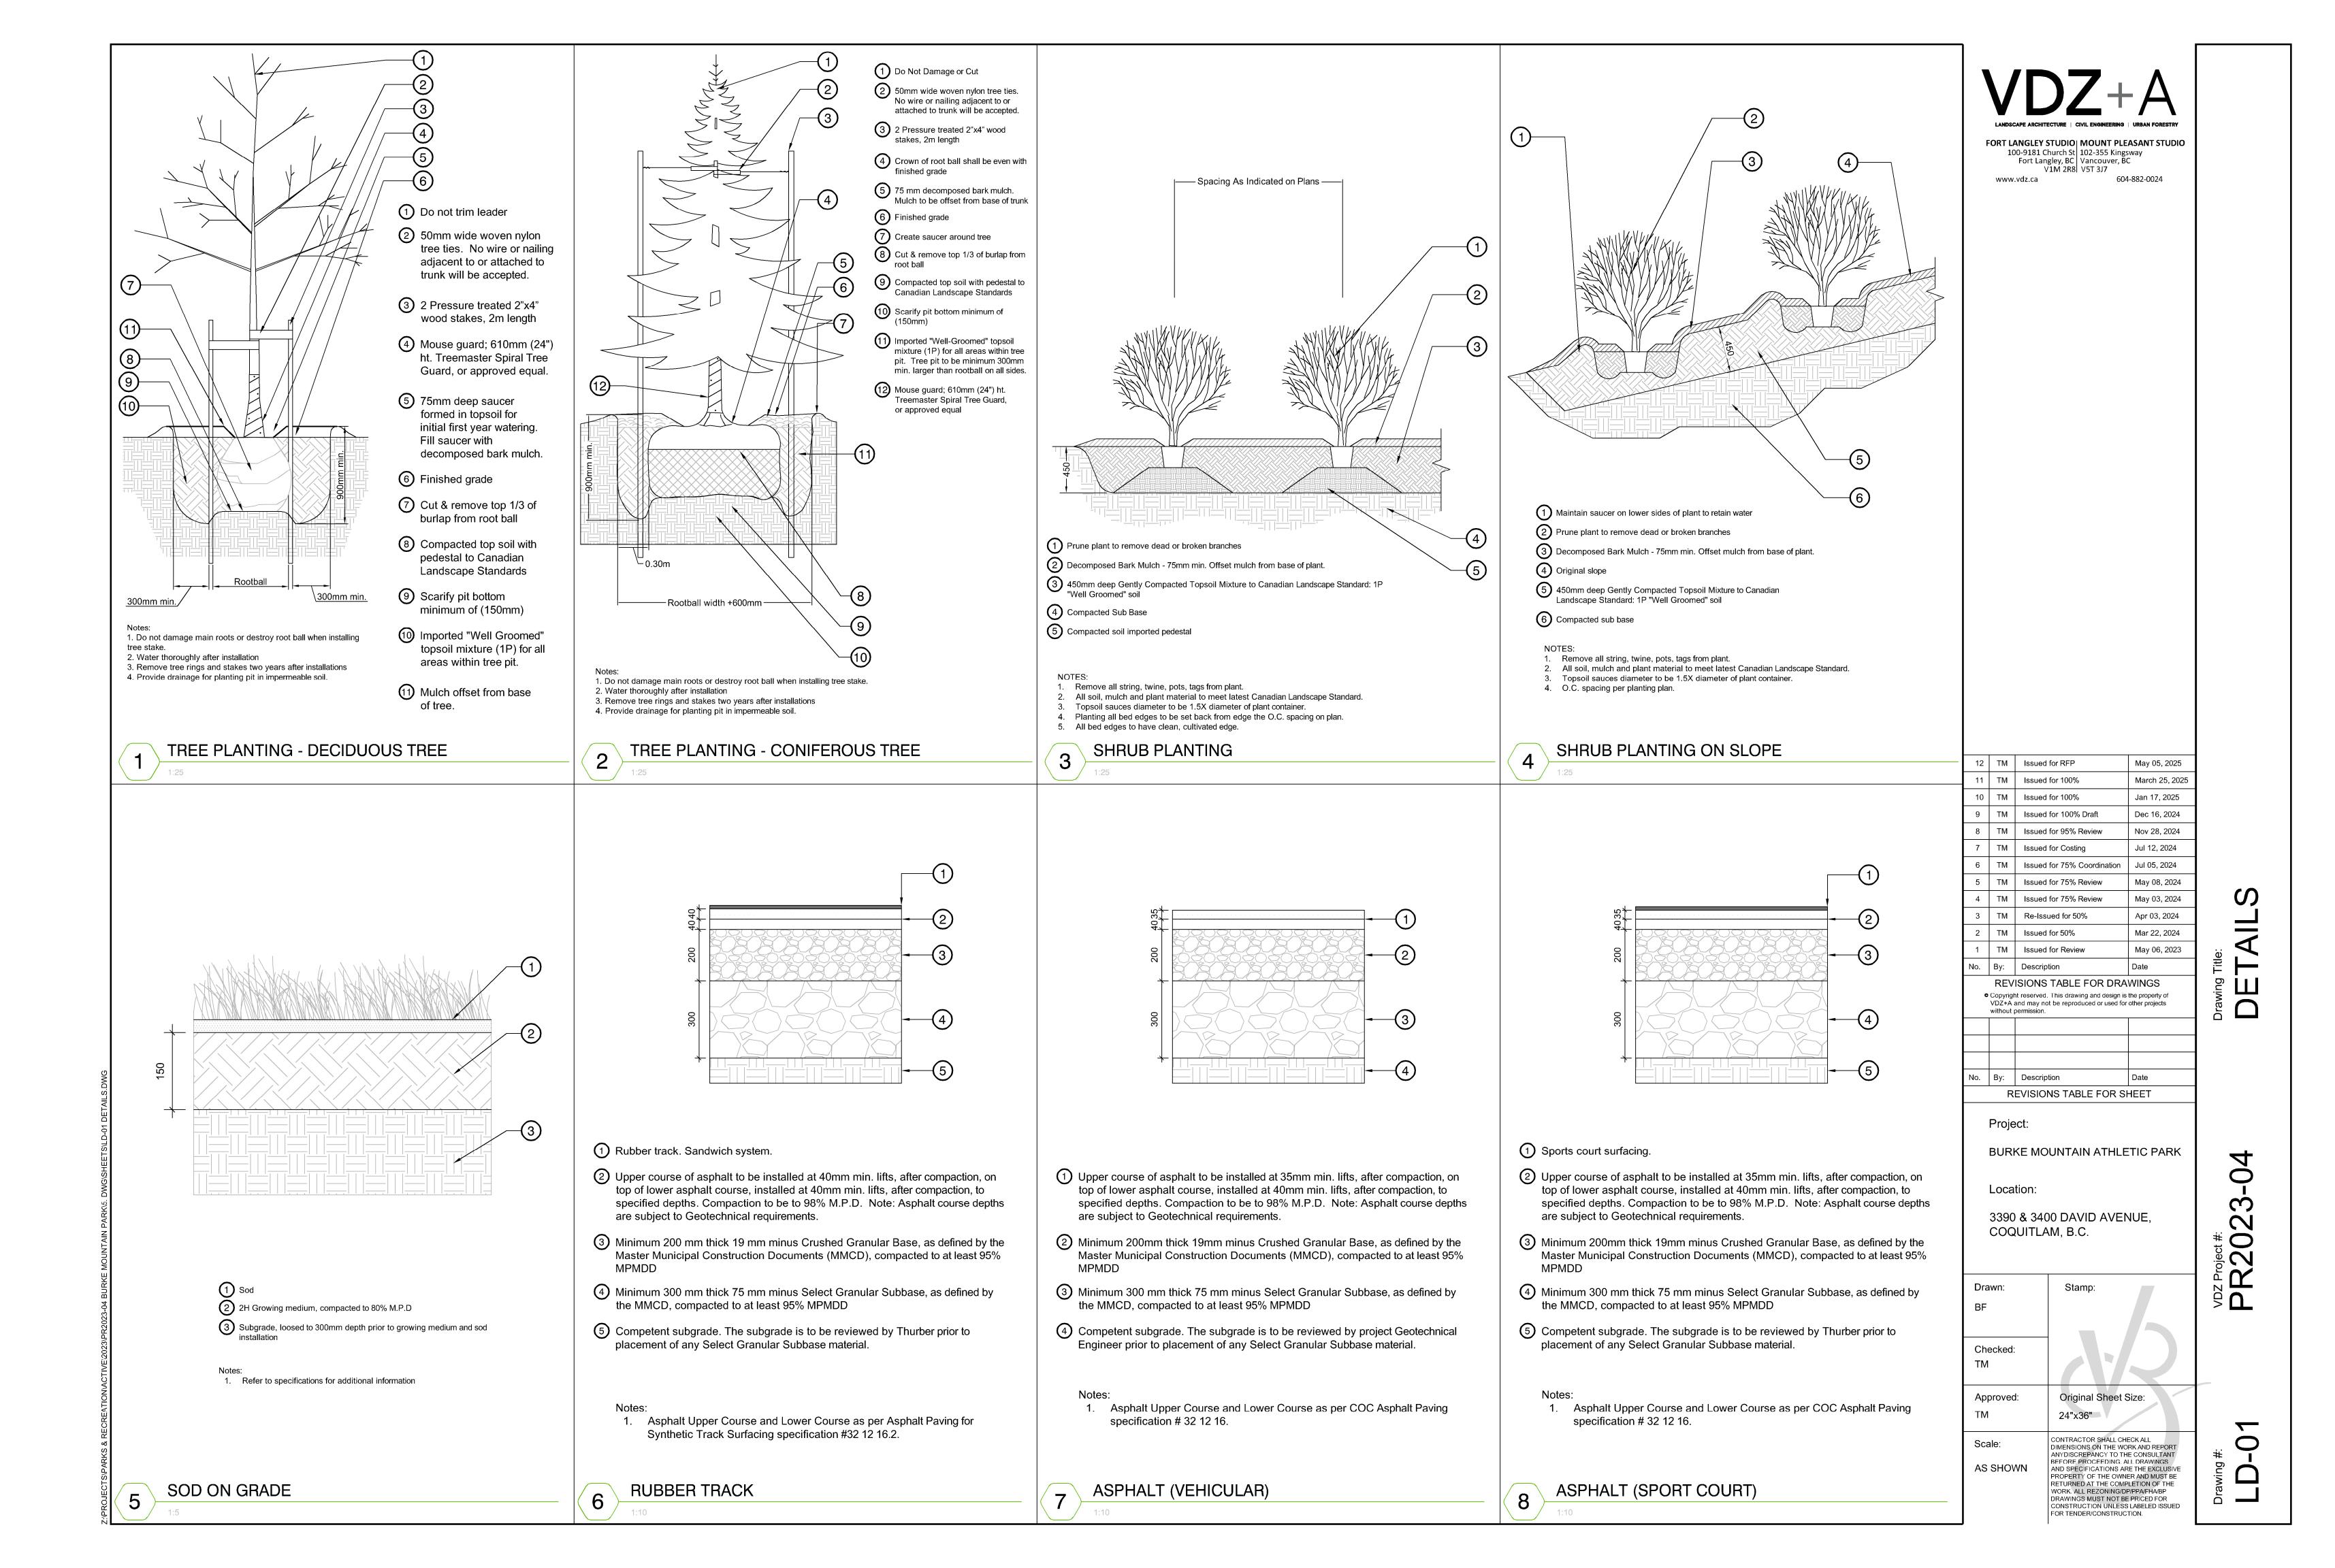


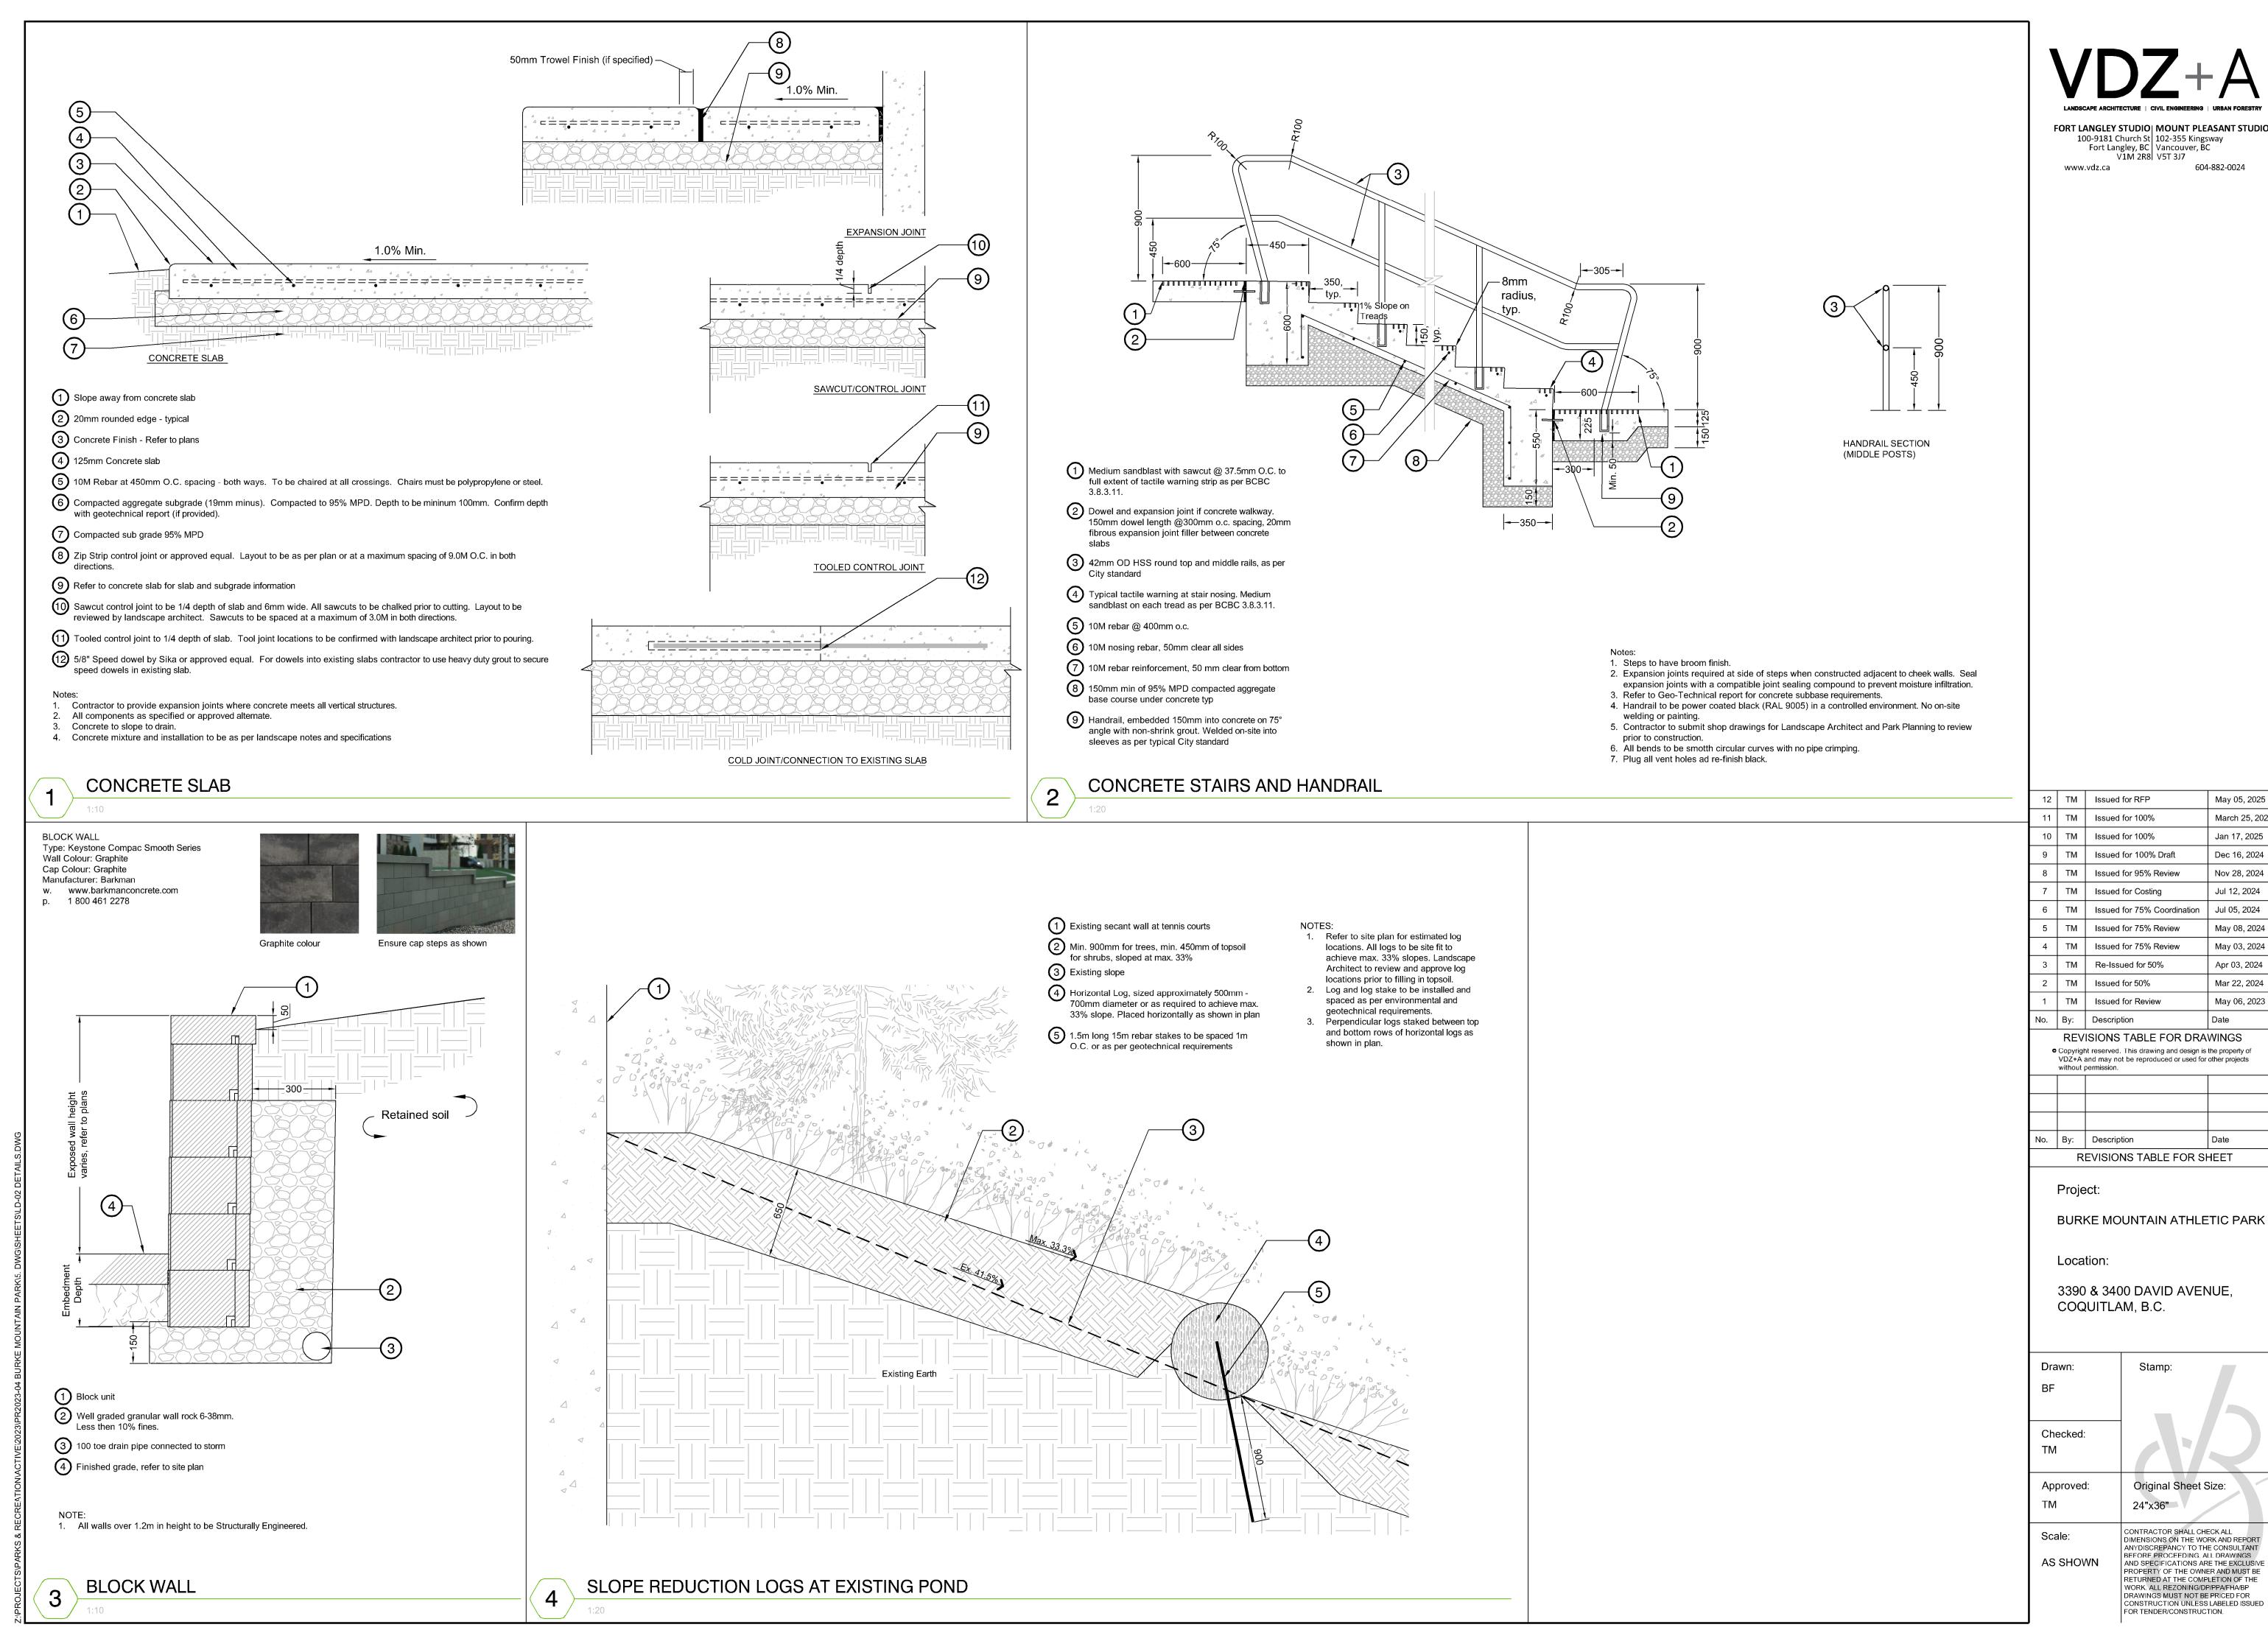


FORT LANGLEY STUDIO | MOUNT PLEASANT STUDIO

March 25, 2025 Dec 16, 2024 May 08, 2024 May 03, 2024 Mar 22, 2024 May 06, 2023

0 

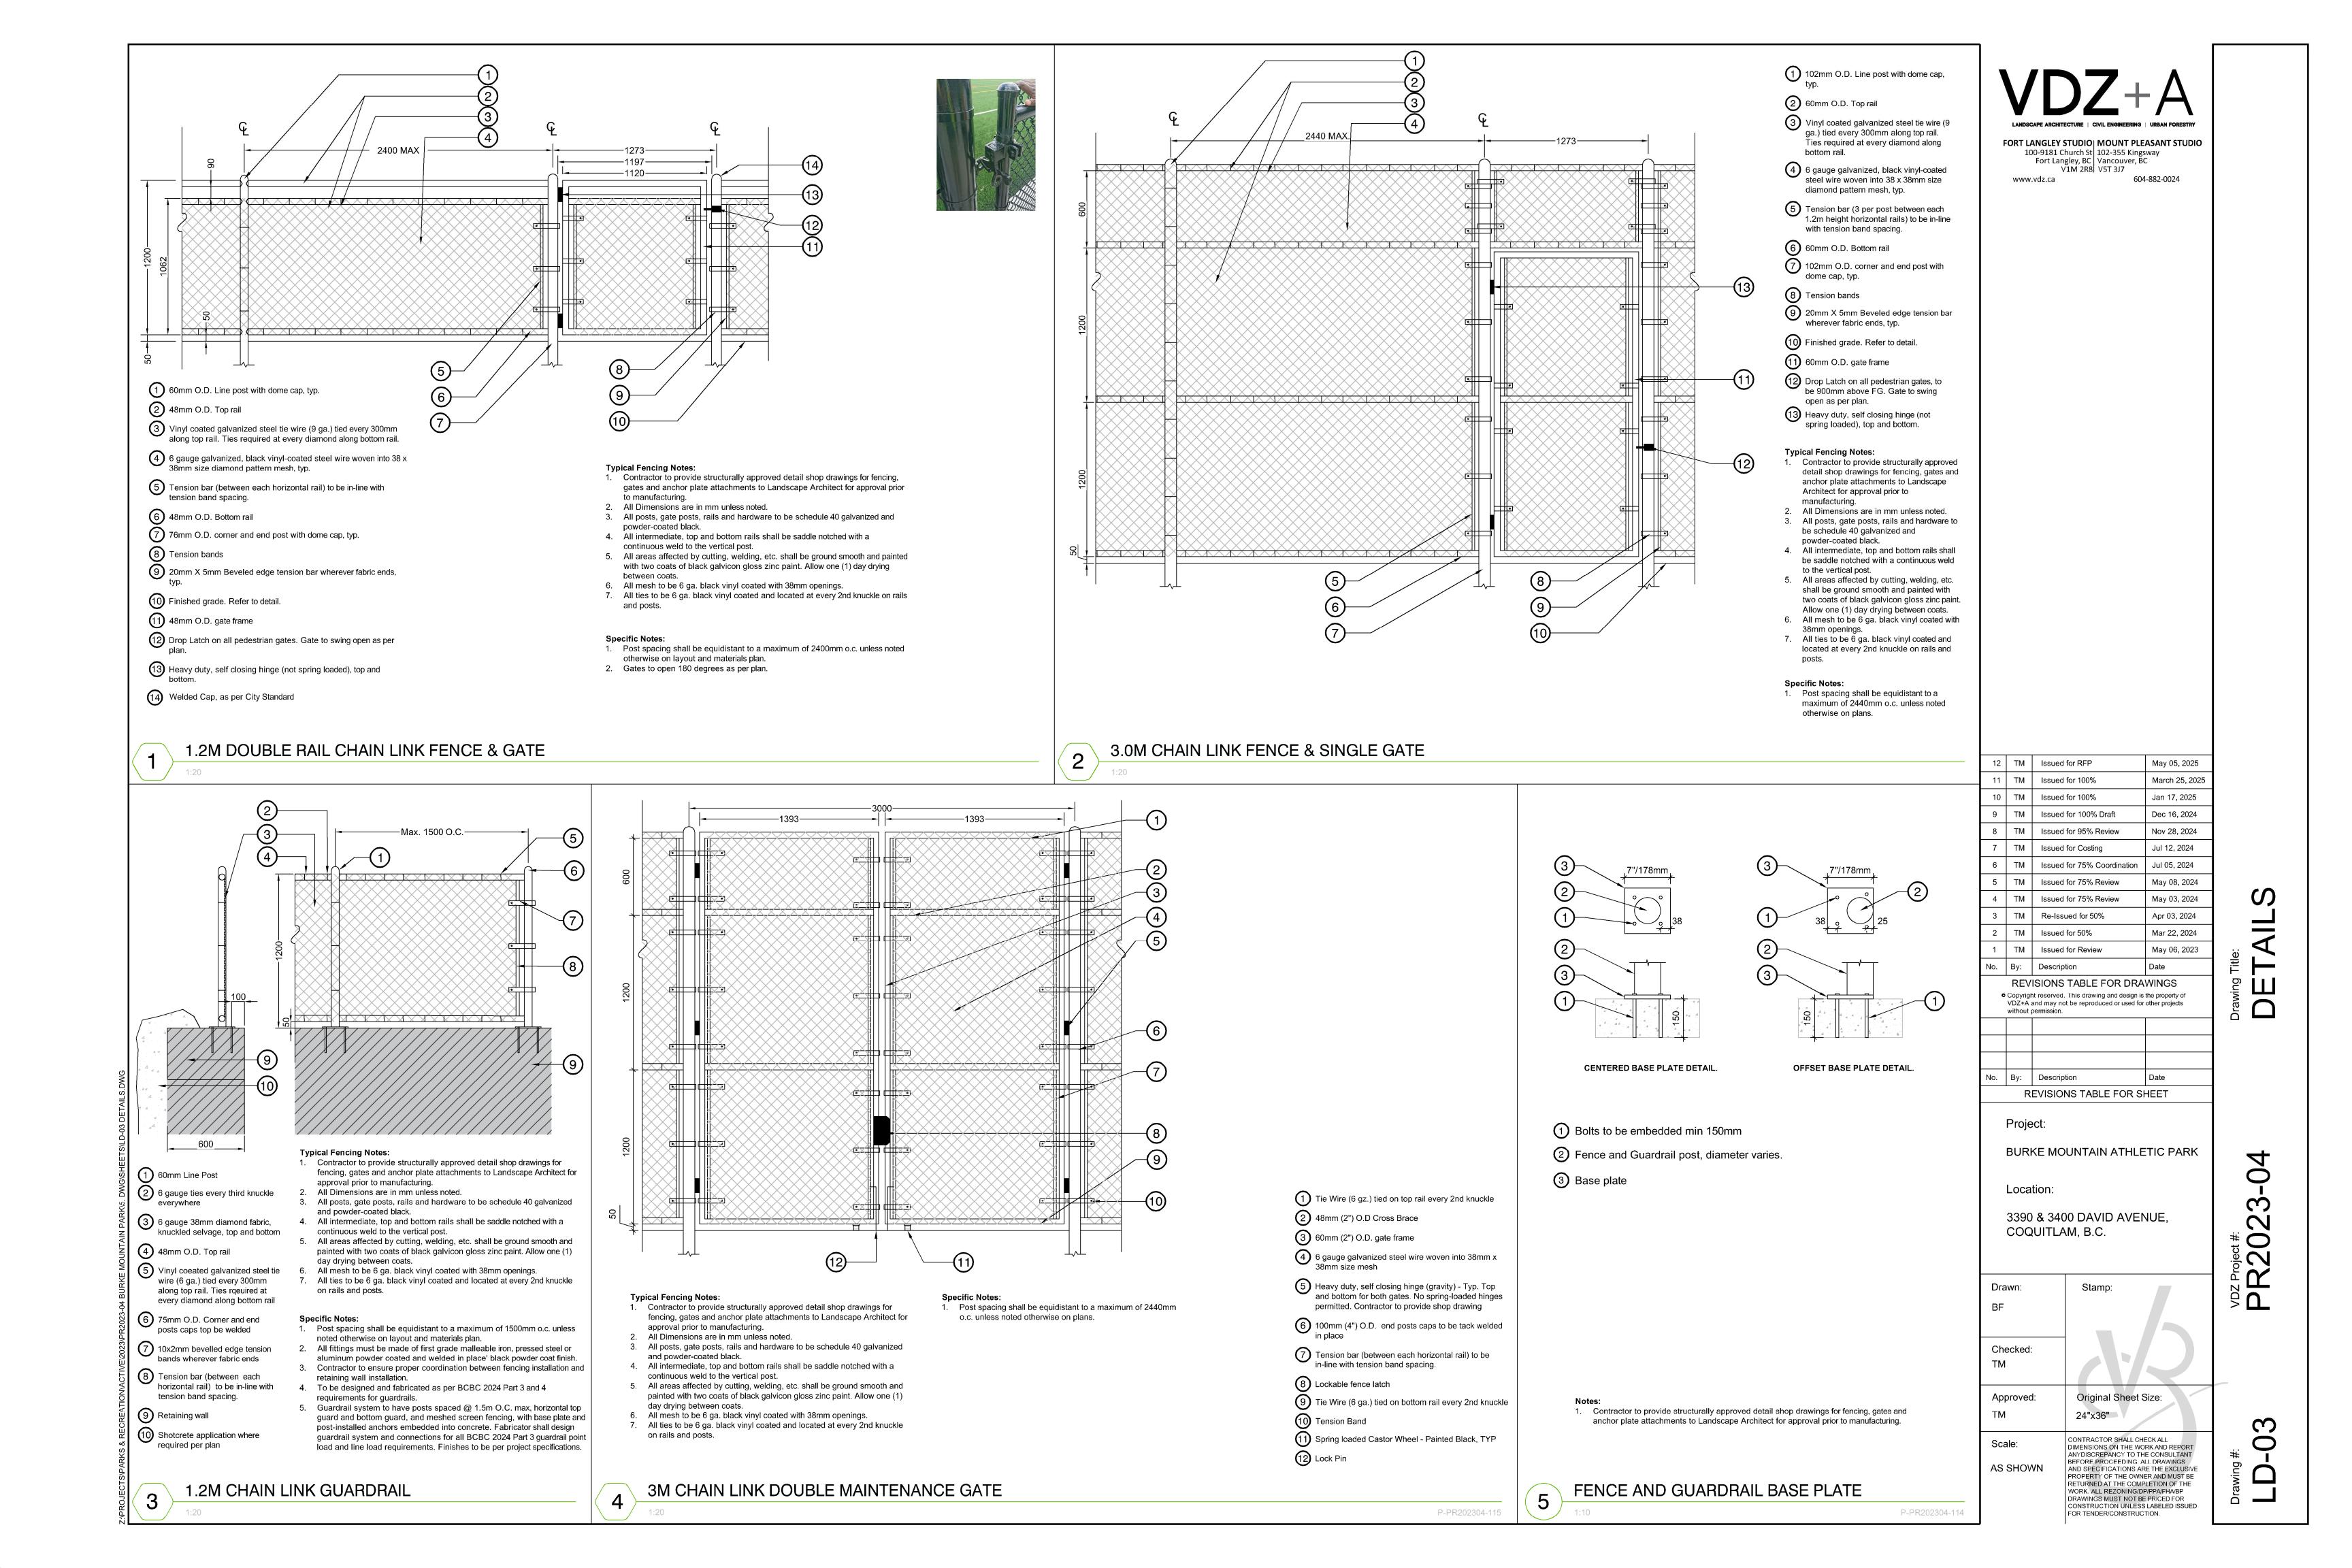

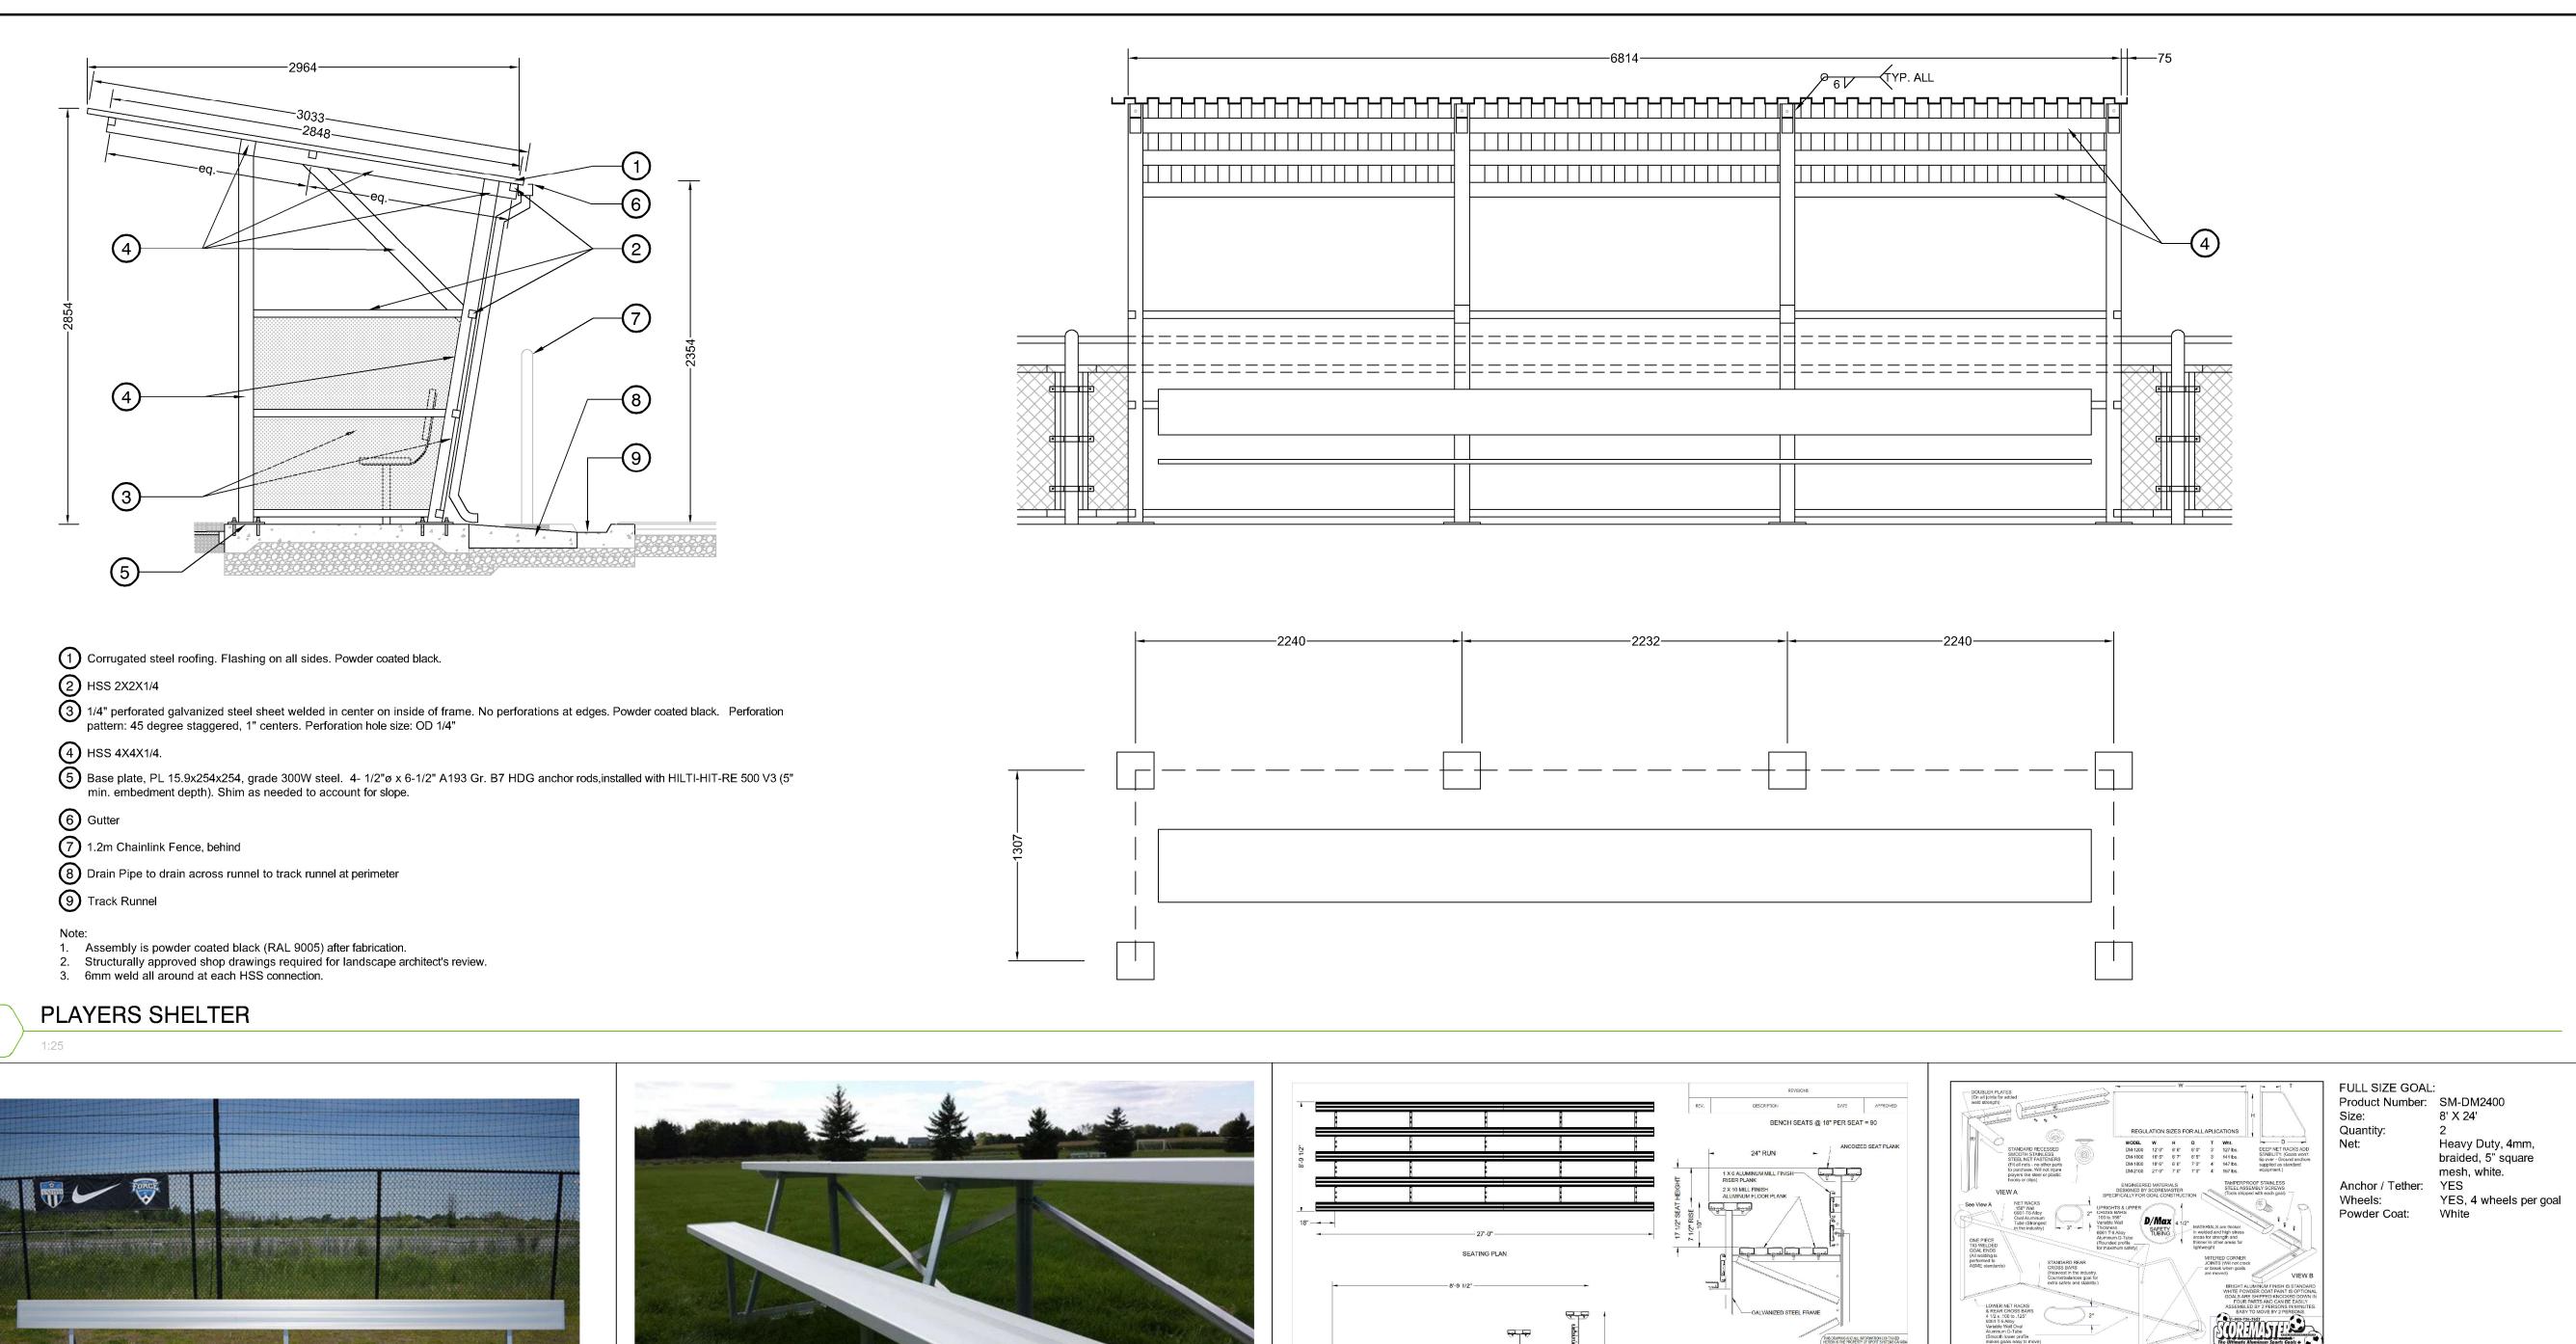



Product Name: Permanent In-Ground Players Bench Product Number: BL-IGB-21-BR Backrest: YES Quantity: Location: Tennis Court Tennis Court Benches require bench pad 3.0m long by 0.5m wide. Product Number: BL-IGB-9 Size: 9' Backrest: YES Quantity: 2 Product Number: BL-IGB-9BR Size: 9' Backrest: NO Quantity: 2 Supplier: Sports Systems Canada p. 877.600.4667

w. www.sportsystemscanada.com

Install as per manufacturers specifications.

Location: Artificial Turf Field

SPORTS BENCHES




Product Name: OUTDOOR SCORING TABLES Product Number: BL-TIMERTABLE-6 Size: Quantity:

> Sports Systems Canada p. 877.600.4667 w. www.sportsystemscanada.com


Install as per manufacturers specifications.


Supplier:

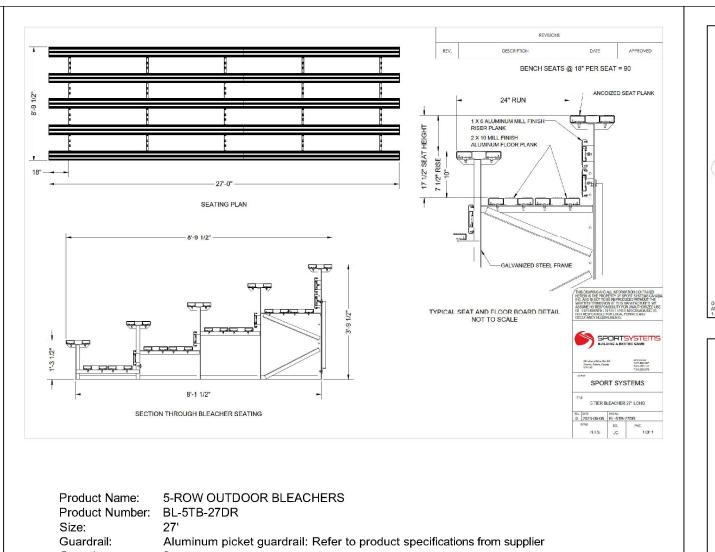

Quantity: Supplier: Sports Systems Canada p. 877.600.4667 w. www.sportsystemscanada.com

1. Install as per manufacturers specifications. 2. Final location to be reviewed and approved by City and consultant on site.

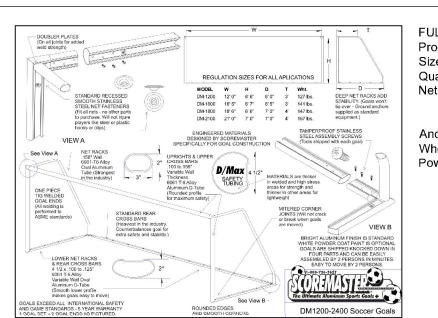

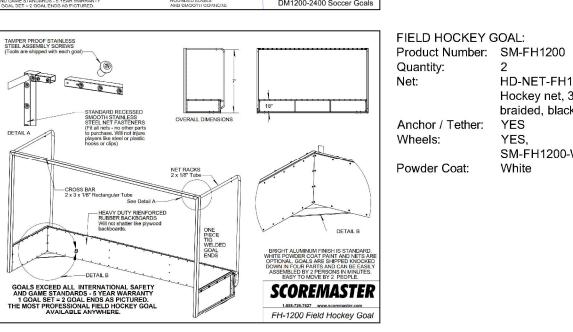

LACROSSE GOAL:

HD-NET-FH12 Field

SM-FH1200-WHEELS

Hockey net, 3mm,

braided, black

YES.

White

THE INFORMATION CONTAINED IN THIS DRAWING IS THE SCIE PROP SCOREMASTER. ANY REPRODUCTION IN PART OR WHOLE WITHOUT THE WRITTEN PERMISSION OF SCOREMASTER IS PROHIBITED. Product Number: SM-L1000 Quantity: SM-HD-NET-L10 Heavy Duty net, 3mm, braided, Powder Coat: Orange ALL WELDED JOINTS ARE TIG WELDED, LOWER AND UPPER HALF ARE JOINED WITH BARREL SCOREMASTER GOALS EXCEED ALL INTERNATIONAL SAFETY AND GAME STANDARDS - 5 YEAR WARRANTY 1 GOAL SET = 2 GOAL ENDS AS PICTURED. L-1000 Lacrosse Goal Manufacturer: Score Master Habitat Systems Install as per manufacturer's specifications. Supplier:

SOCCER AND HOCKEY GOALS

p. 1.866.422.4828

e. info@habitat-systems.com

	10	TM	Issued for 100%	Jan 17, 2025
	9	TM	Issued for 100% Draft	Dec 16, 2024
	8	TM	Issued for 95% Review	Nov 28, 2024
	7	TM	Issued for Costing	Jul 12, 2024
	6	TM	Issued for 75% Coordination	Jul 05, 2024
ıl	5	TM	Issued for 75% Review	May 08, 2024
	4	ТМ	Issued for 75% Review	May 03, 2024
	3	ТМ	Re-Issued for 50%	Apr 03, 2024
	2	ТМ	Issued for 50%	Mar 22, 2024
	1	ТМ	Issued for Review	May 06, 2023
	No.	Ву:	Description	Date
	REVISIONS TABLE FOR DRAWINGS  Copyright reserved. This drawing and design is the property of VDZ+A and may not be reproduced or used for other projects without permission.			
	No.	Ву:	Description	Date
	REVISIONS TABLE FOR SHEET			HEET

May 05, 2025

March 25, 2025

12 TM Issued for RFP

11 TM Issued for 100%

FORT LANGLEY STUDIO | MOUNT PLEASANT STUDIO 100-9181 Church St | 102-355 Kingsway

604-882-0024

Fort Langley, BC | Vancouver, BC V1M 2R8 V5T 3J7

www.vdz.ca

Project: BURKE MOUNTAIN ATHLETIC PARK

3390 & 3400 DAVID AVENUE, COQUITLAM, B.C.

Location:

Drawn:	Stamp:
BF	
Checked:	
TM	
Approved:	Original Sheet Size:

24"x36" TM CONTRACTOR SHALL CHECK ALL DIMENSIONS ON THE WORK AND REPORT Scale: ANYDISCREPANCY TO THE CONSULTANT

BEFORE PROCEEDING. ALL DRAWINGS AND SPECIFICATIONS ARE THE EXCLUSIVE AS SHOWN PROPERTY OF THE OWNER AND MUST BE RETURNED AT THE COMPLETION OF THE WORK. ALL REZONING/DP/PPA/FHA/BP DRAWINGS MUST NOT BE PRICED FOR CONSTRUCTION UNLESS LABELED ISSUED

FOR TENDER/CONSTRUCTION.


0 

# 0

AIL

SCORER'S TABLE

**BLEACHERS** 

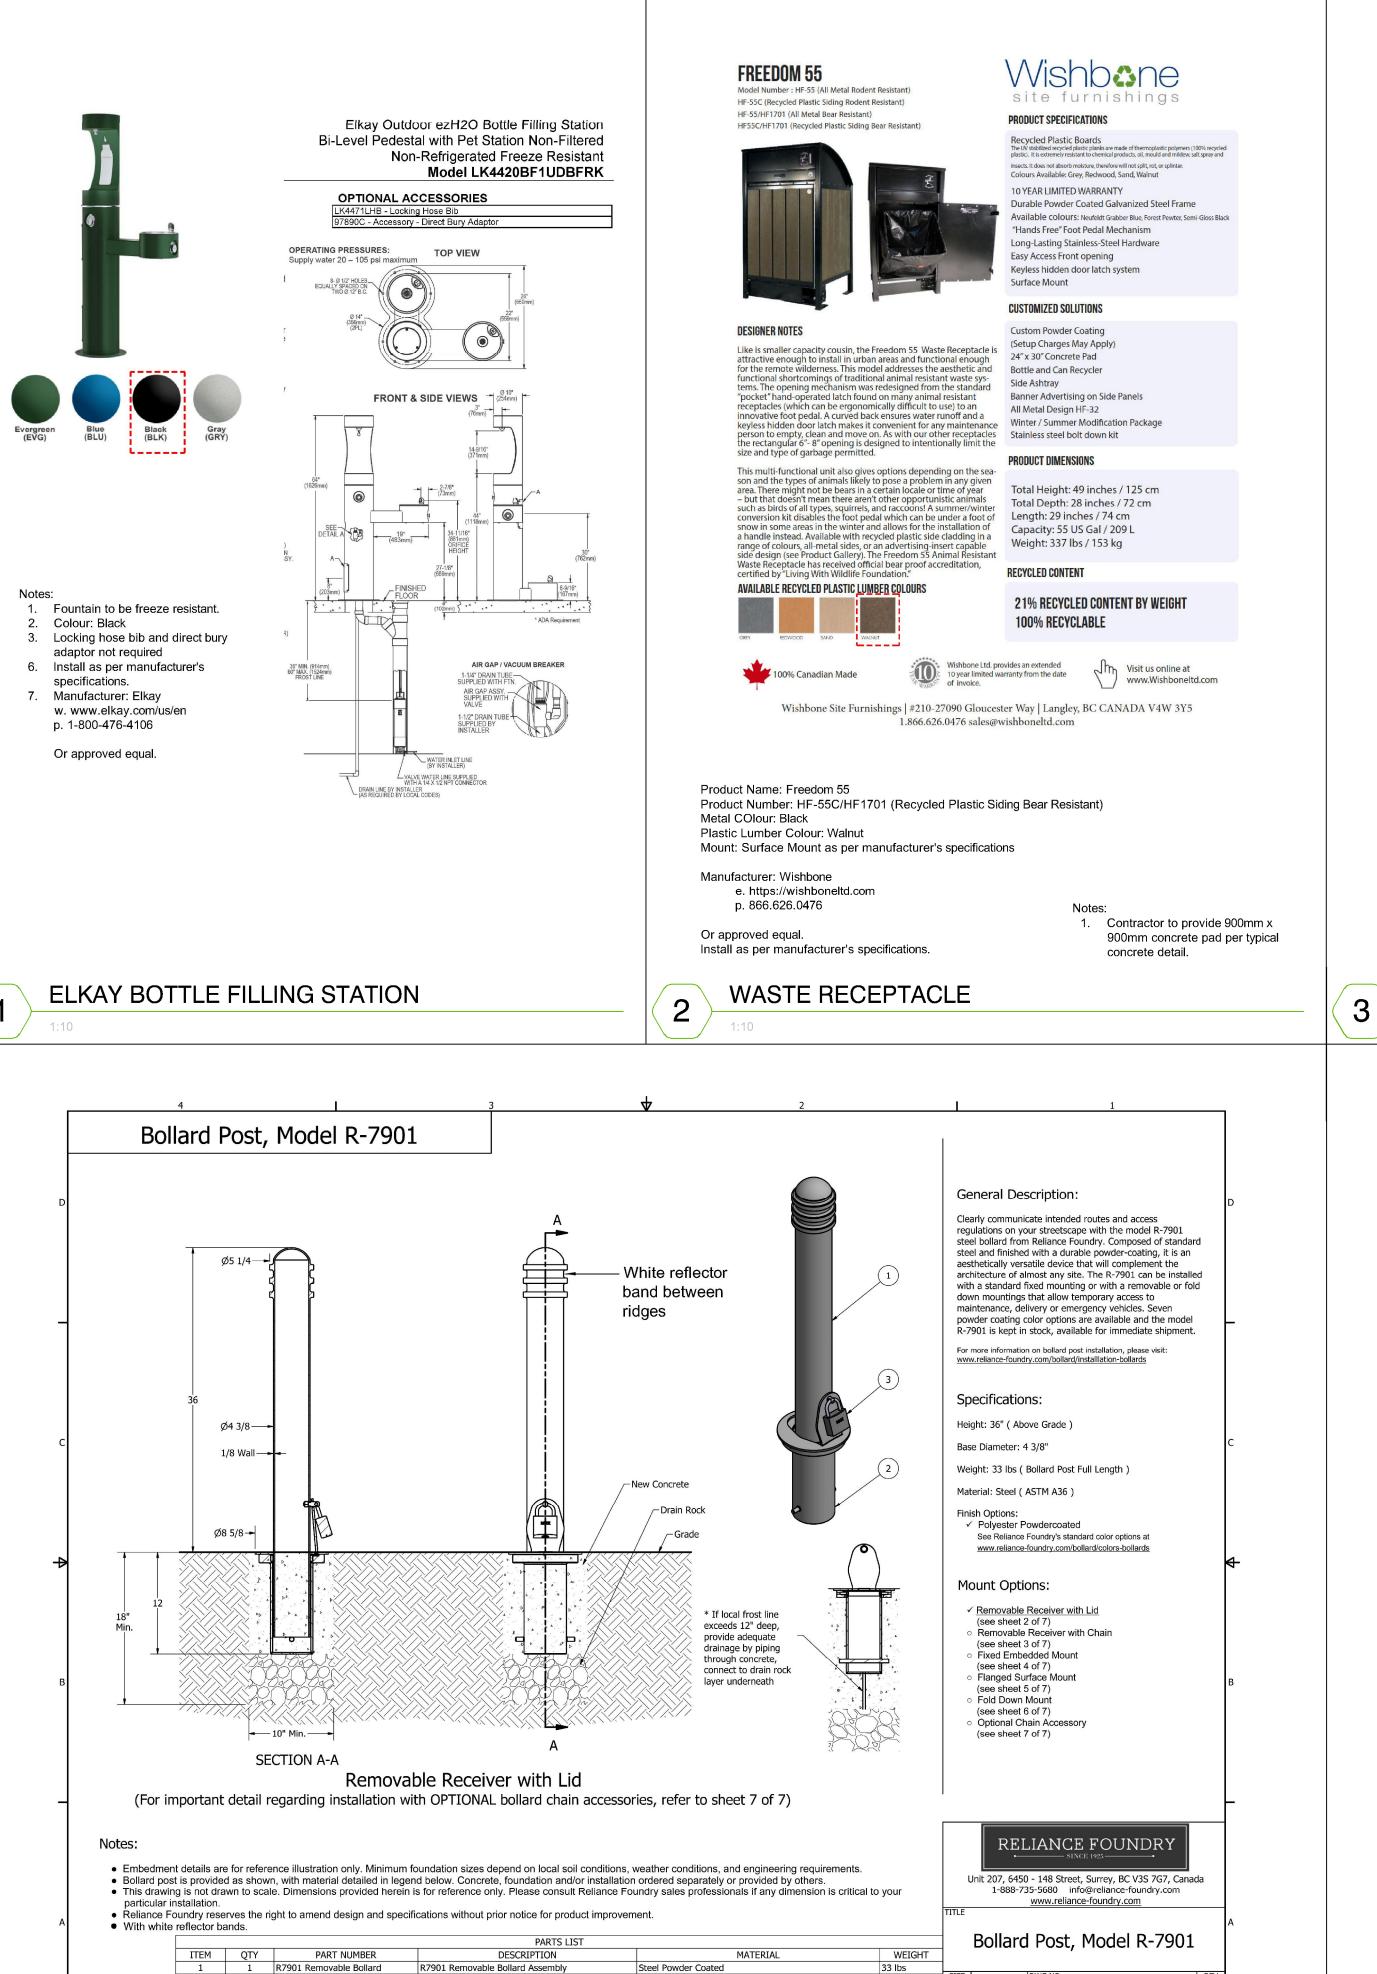

R7901R Receiver

Padlock (Optional)

REMOVABLE BOLLARD

R7901R Receiver Assembly w/ Lid

Optional Padlock (Brass or Stainless Steel)


COPYRIGHT RESERVED THIS PLAN DRAWING AND DESIGN ARE, AND AT ALL TIMES REMAIN, THE EXCLUSIVE PROPERTY OF RELIANCE FOUNDRY CO. LTD.

Galvanized Steel w/ 316 Stainless Steel Cover

Choice of Brass or Stainless Steel

5/8 lbs



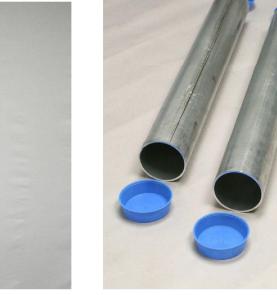



Product Name: Douglas® Premier™ XS Tennis Posts, 2-7/8" OD Product Number: 63034SS

Color: Stainless Steel 60" in length and sit 42" above court surface Height:

SLEEVES: Product Name: GS-24RD/AL Aluminum Ground Sleeves 24" Long for 2-7/8" OD Posts

Product Number: 63171

Product Name: Douglas® TN-28DM Tennis Net, 3.5mm Double Mesh Tapered Product Number: 30060 Size: 42' x 42"

Quantity: Manufacturer: Douglas Sports Sports Systems Canada Supplier: p. 877.600.4667 w. www.sportsystemscanada.com

Install as per manufacturers specifications.

# **TENNIS NETTING**








Product Name: Goal Secure Turf Anchors Product Number: 10B5301 4 anchors for 2 goals.

KWIK GOAL p. 1-800-531-4252 w. info@kwikgoal.com

Install as per manufacturer's specifications.

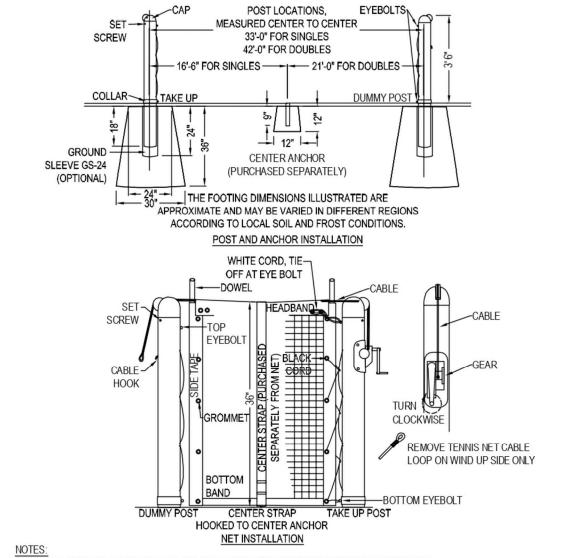

IONALS

OVED BY

REFERENCE NUMBER 2763-009.

CONSTRUCTION NOTES:

1. The Tennis Court Net Post must be installed after the entire tennis court has been paved. 2. The Asphalt paving shall be cut at the location of the net posts and the base and sub-base

gravels shall be vacuumed out using a purpose-suited hydrovac truck.

3. Net Posts shall be installed as per manufacturer's specifications.

4. The top of the net posts concrete footing shall be set 'no higher' than the underside of the surrounding asphalt, such that a full depth asphalt patch can be placed over-top the concrete footing, once the concrete has cured.

5. Once all the asphalt, including the net post patches, have cured the tennis court surfacing can be applied.

16'-6" FOR SINGLES 21'-0" FOR DOUBLES
COLLAR TAKE UP DUMMY POST
GROUND SLEEVE GS-24 (OPTIONAL)  GROUND (PURCHASED SEPARATELY)
THE FOOTING DIMENSIONS ILLUSTRATED ARE  APPROXIMATE AND MAY BE VARIED IN DIFFERENT REGIONS  ACCORDING TO LOCAL SOIL AND FROST CONDITIONS.
POST AND ANCHOR INSTALLATION
WHITE CORD, TIE OFF AT EYE BOLT DOWEL  CABLE HOOK  CABLE HOOK  GROMMET  GRO
DUMMY POST CENTER STRAP TAKE UP POST HOOKED TO CENTER ANCHOR
NET INSTALLATION
INSTALLATION TO BE COMPLETED IN ACCORDANCE WITH MANUFACTURER'S SPECIFICATIONS.  DO NOT SCALE DRAWING.  THIS DRAWING IS INTENDED FOR USE BY ARCHITECTS, ENGINEERS, CONTRACTORS, CONSULTANTS AND DESIGN PROFESSION FOR PLANNING PURPOSES ONLY. THIS DRAWING MAY NOT BE USED FOR CONSTRUCTION.  ALL INFORMATION CONTAINED HEREIN WAS CURRENT AT THE TIME OF DEVELOPMENT BUT MUST BE REVIEWED AND APPROVITHE PRODUCT MANUFACTURER TO BE CONSIDERED ACCURATE.  CONTRACTOR'S NOTE: FOR PRODUCT AND COMPANY INFORMATION VISIT www.CADdetails.com/info AND ENTER

TENNIS POST AND ANCHOR FOOTINGS



Model: TS-SCSC Product Name: Scrusher Mount: Surface mount

Supplier: Tomko Sports Systems p. (604) 273-0257 w. tomkosports.com

Install as per manufacturer's specifications.

**BOOT BRUSH STATION** 

<b>VD</b> 2	$\mathbf{Z} + \mathbf{A}$
LANDSCAPE ARCHITECTURE   0	CIVIL ENGINEERING   URBAN FORESTRY
FORT LANGLEY STUDIO 100-9181 Church St Fort Langley, BC	

V1M 2R8 V5T 3J7 604-882-0024 www.vdz.ca

TM Issued for Costing Jul 12, 2024 Jul 05, 2024 6 TM Issued for 75% Coordination TM Issued for 75% Review May 08, 2024 TM Issued for 75% Review May 03, 2024 3 TM Re-Issued for 50% Apr 03, 2024 2 TM Issued for 50% Mar 22, 2024 TM Issued for Review May 06, 2023 REVISIONS TABLE FOR DRAWINGS Copyright reserved. This drawing and design is the property of VDZ+A and may not be reproduced or used for other projects

May 05, 2025

March 25, 2025

Jan 17, 2025

Dec 16, 2024

Nov 28, 2024

Project: **BURKE MOUNTAIN ATHLETIC PARK** 

REVISIONS TABLE FOR SHEET

12 TM Issued for RFP

11 | TM | Issued for 100%

10 TM Issued for 100%

By: Description

without permission.

Location:

9 TM Issued for 100% Draft

8 | TM | Issued for 95% Review

3390 & 3400 DAVID AVENUE, COQUITLAM, B.C.

Drawn: Checked: TM

Original Sheet Size: Approved: 24"x36"


CONTRACTOR SHALL CHECK ALL Scale: DIMENSIONS ON THE WORK AND REPORT ANYDISCREPANCY TO THE CONSULTANT BEFORE PROCEEDING. ALL DRAWINGS AS SHOWN AND SPECIFICATIONS ARE THE EXCLUSIVE PROPERTY OF THE OWNER AND MUST BE RETURNED AT THE COMPLETION OF THE WORK. ALL REZONING/DP/PPA/FHA/BP

DRAWINGS MUST NOT BE PRICED FOR CONSTRUCTION UNLESS LABELED ISSUED

FOR TENDER/CONSTRUCTION.

0

**GOAL ANCHORS** 

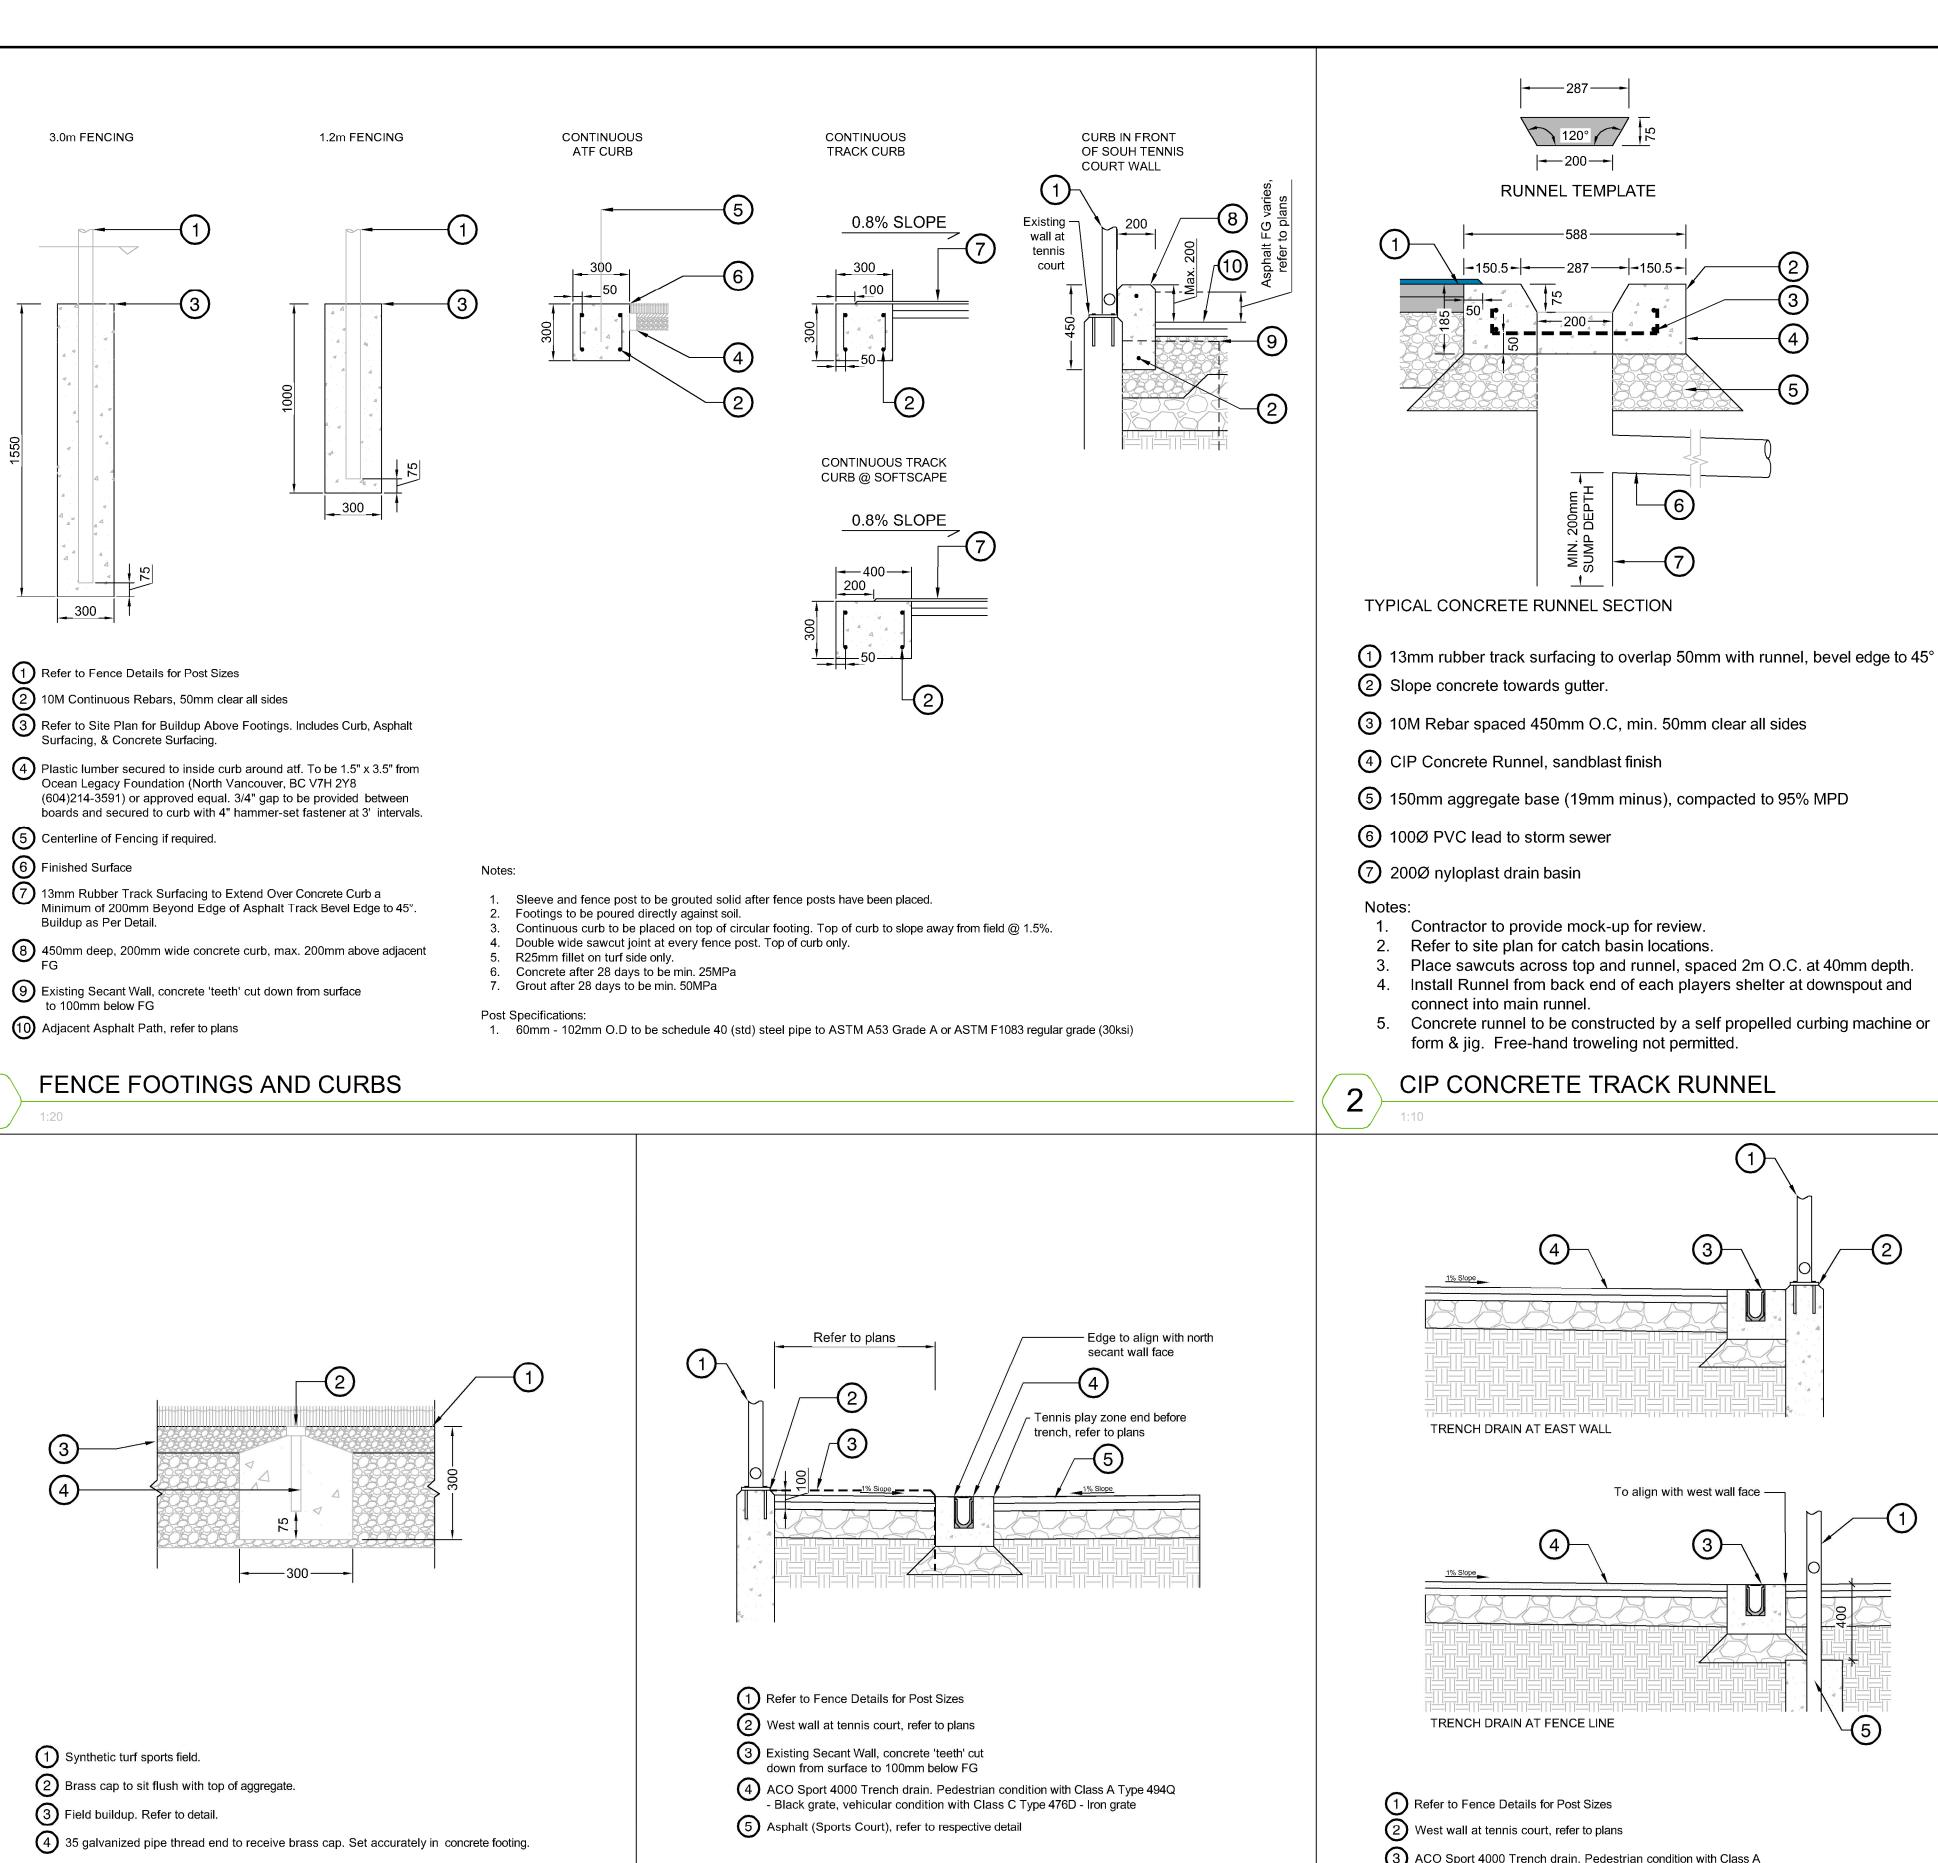

1. Refer to landscape and Civil plans for trench and

Vehicular (Class E): Type 478Q - Longitudinal Iron

**TENNIS COURT AT WEST WALL** 

Black Plastic / Iron Longitudinal

Trench Drain Product: Aco Sport System 4000

Pedestrian (Class A): Type 494Q - Black -

Longitudinal Plastic (Part 97393)

wall locations.

Supplier: ACO


w. acoswm.com

(Part 03314)

Monument to be laid out by a BCLS in accordance with world athletics standards.

MONUMENT


e. sales@acousa.com

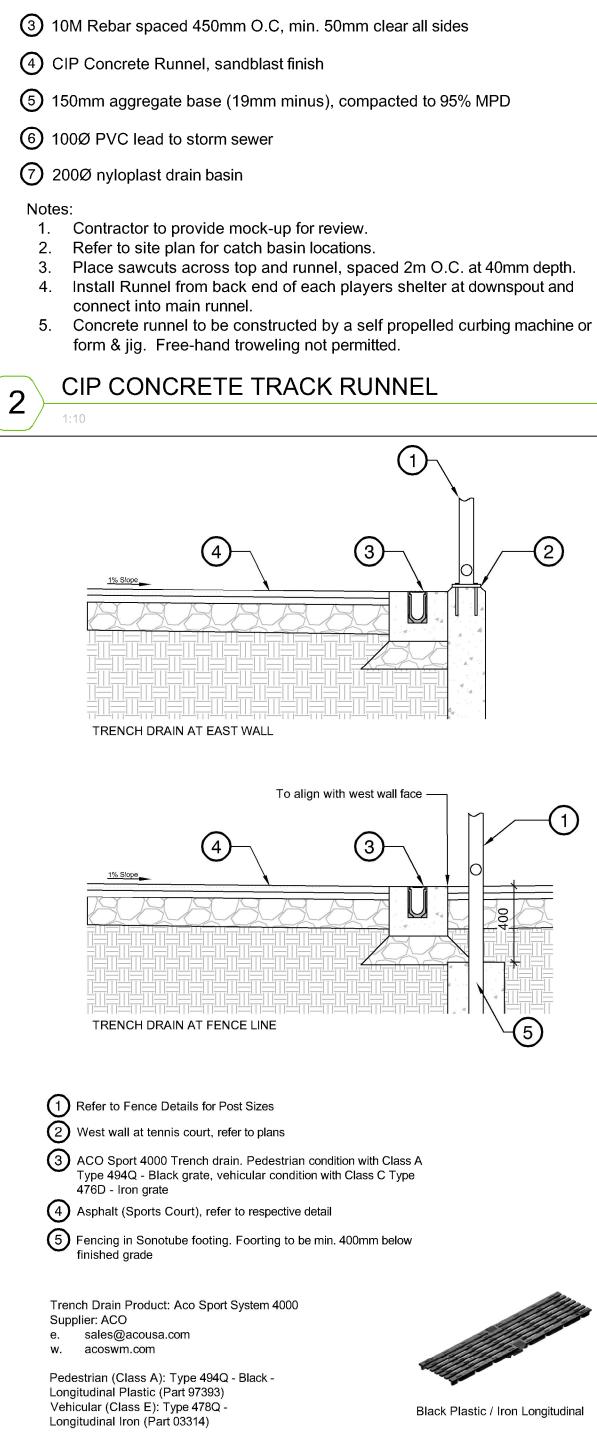


200-


RUNNEL TEMPLATE

200

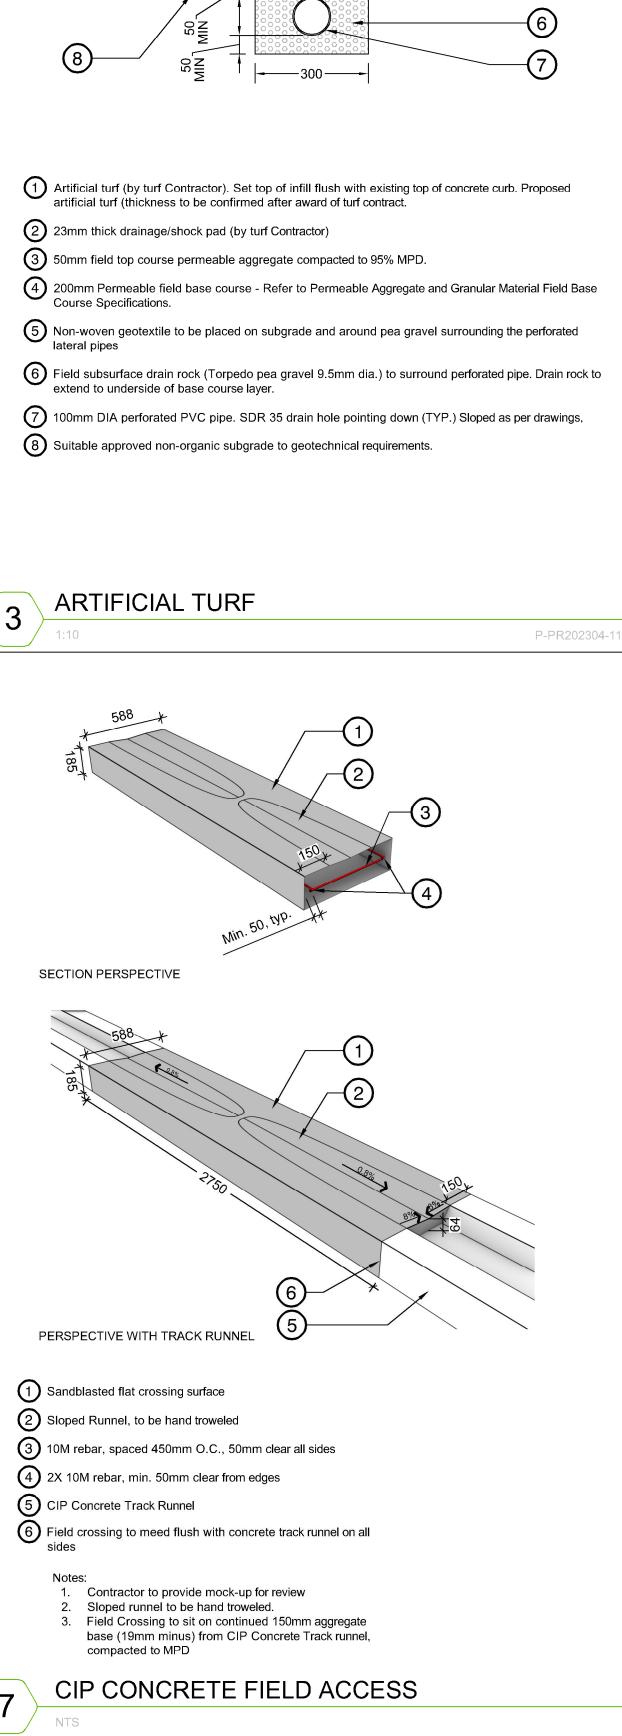

SURFACE FLOW DIRECTION (IF APPLICABLE)

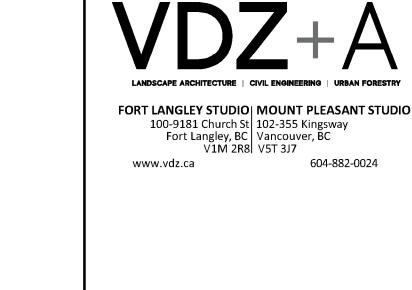

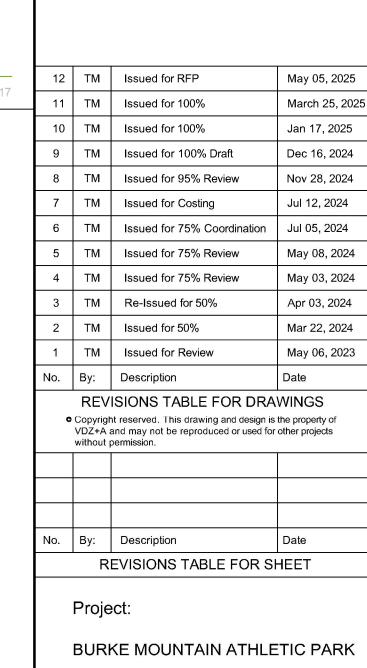

Location:

Drawn:

Checked:

Approved:

Scale:

3390 & 3400 DAVID AVENUE,

Original Sheet Size:

CONTRACTOR SHALL CHECK ALL DIMENSIONS ON THE WORK AND REPORT

ANYDISCREPANCY TO THE CONSULTANT

BEFORE PROCEEDING. ALL DRAWINGS

AND SPECIFICATIONS ARE THE EXCLUSIVE PROPERTY OF THE OWNER AND MUST BE RETURNED AT THE COMPLETION OF THE

WORK. ALL REZONING/DP/PPA/FHA/BP DRAWINGS MUST NOT BE PRICED FOR CONSTRUCTION UNLESS LABELED ISSUED

FOR TENDER/CONSTRUCTION.


24"x36"


COQUITLAM, B.C.


O

TENNIS COURT DRAIN ALONG EAST EDGE

Black Plastic / Iron Longitudinal

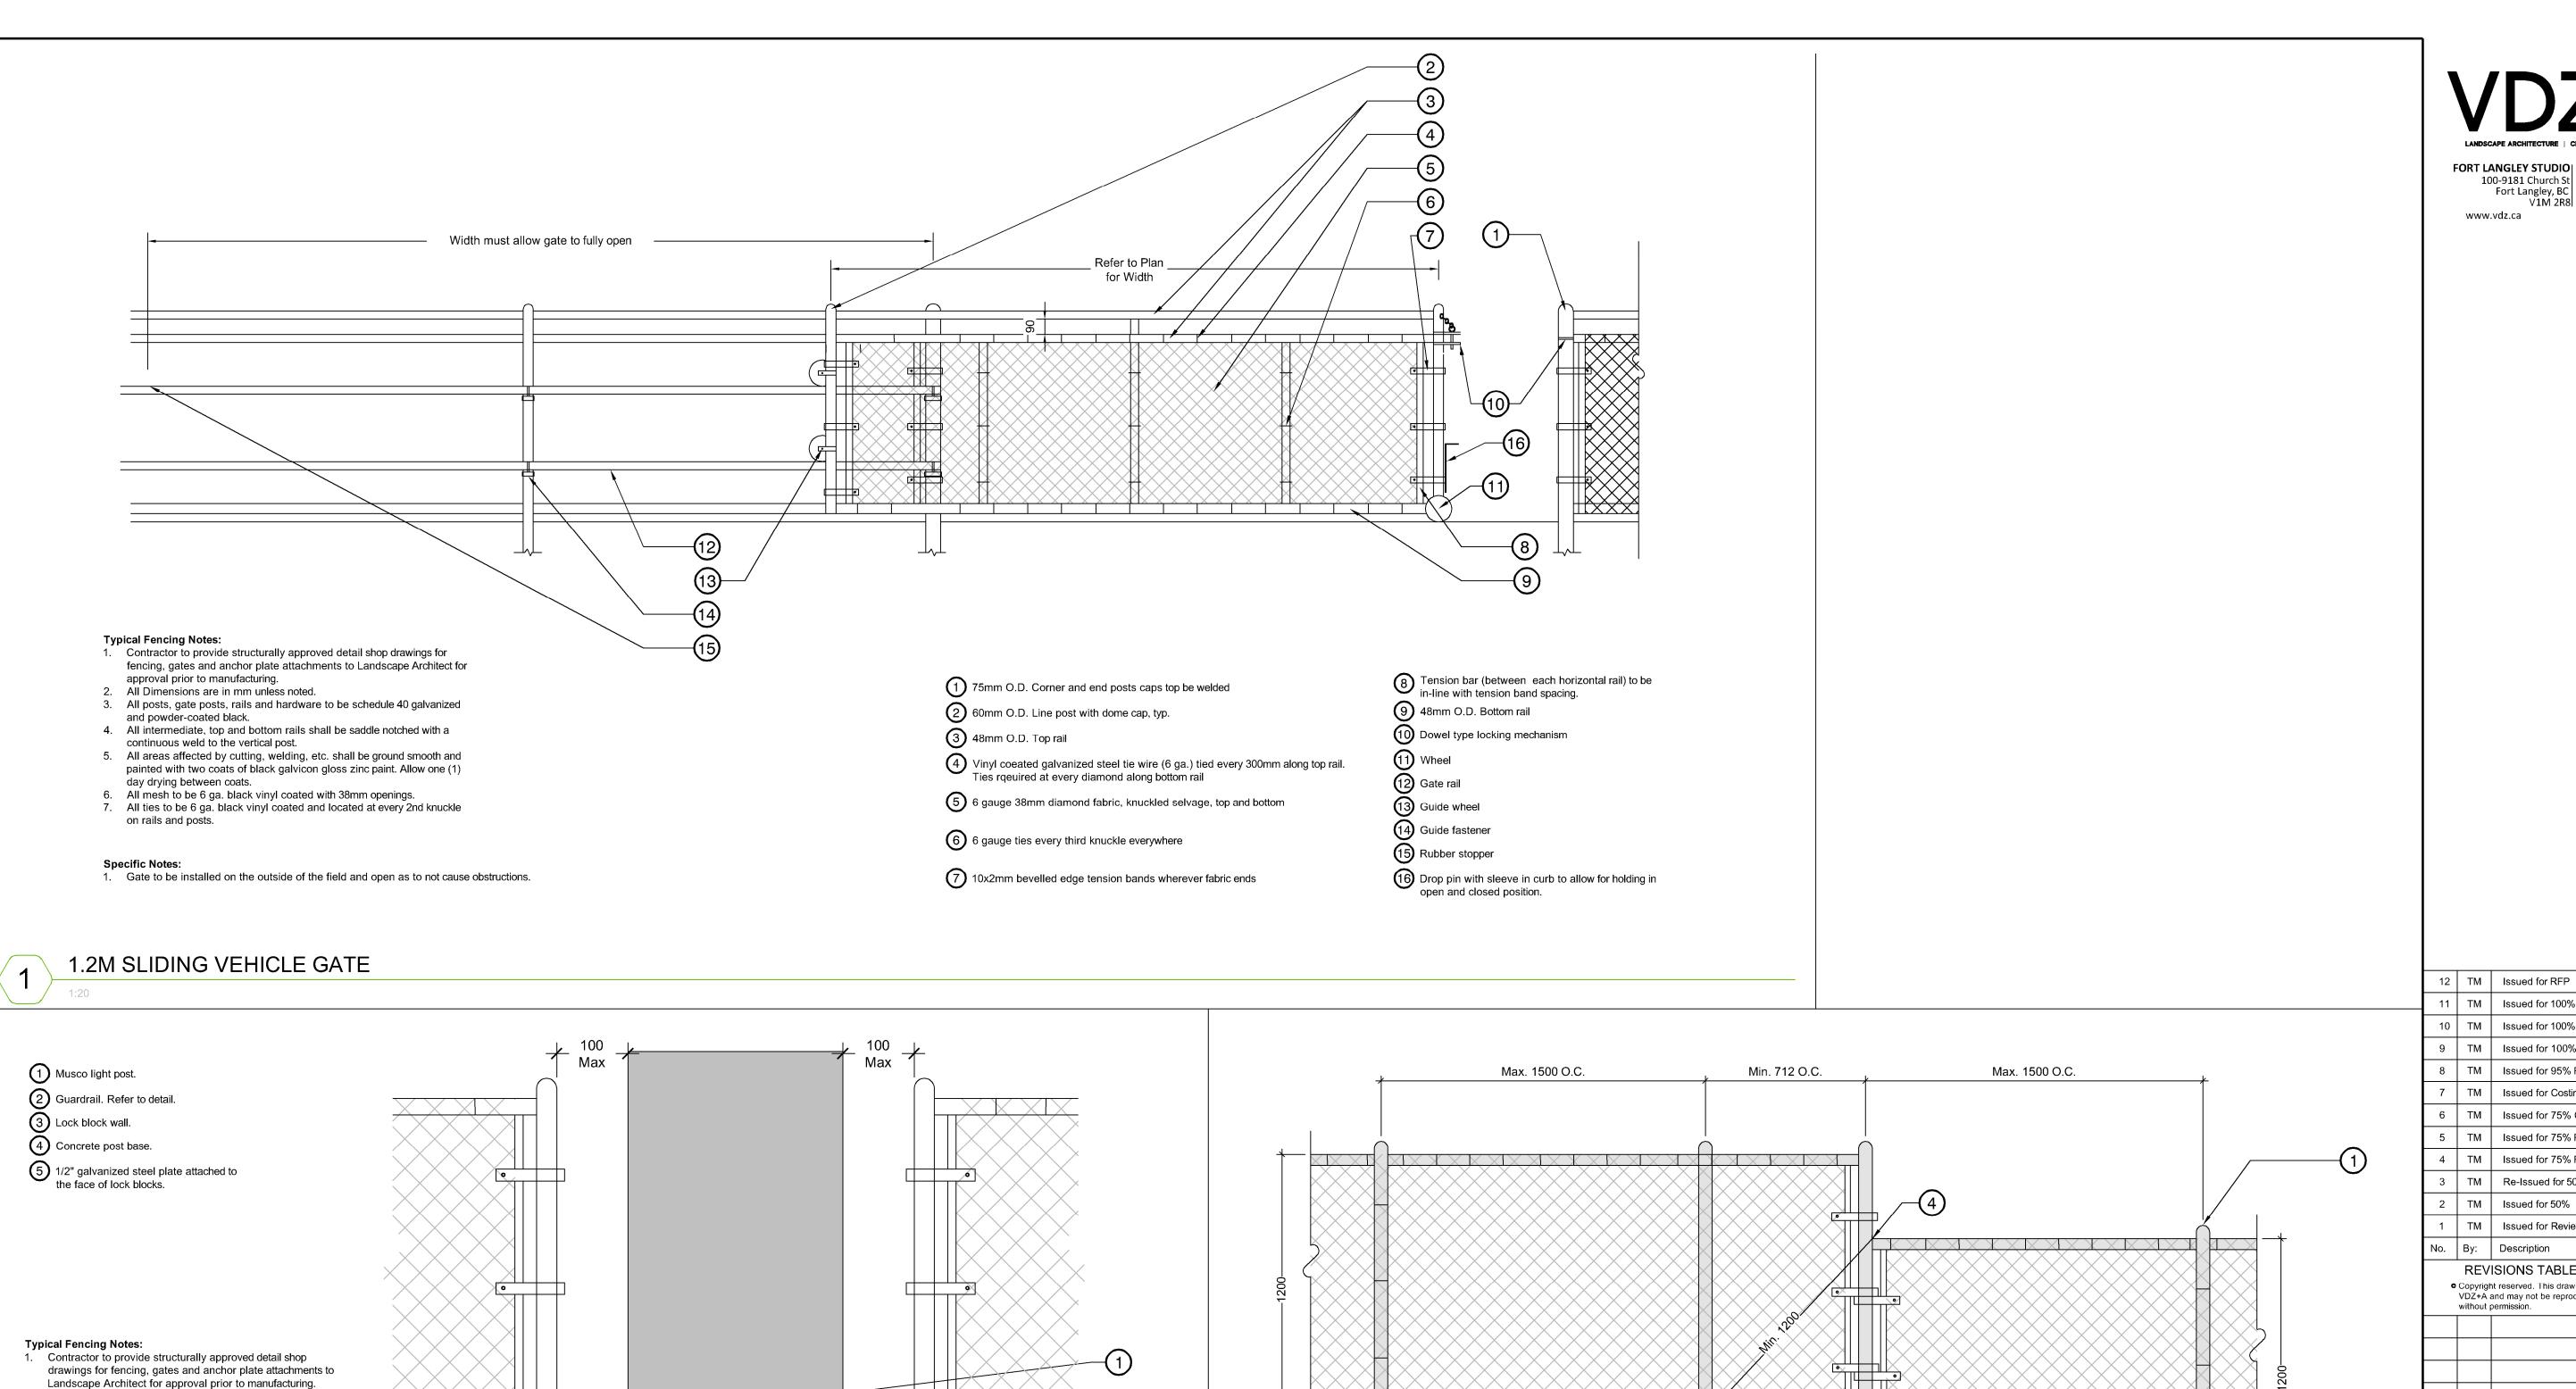

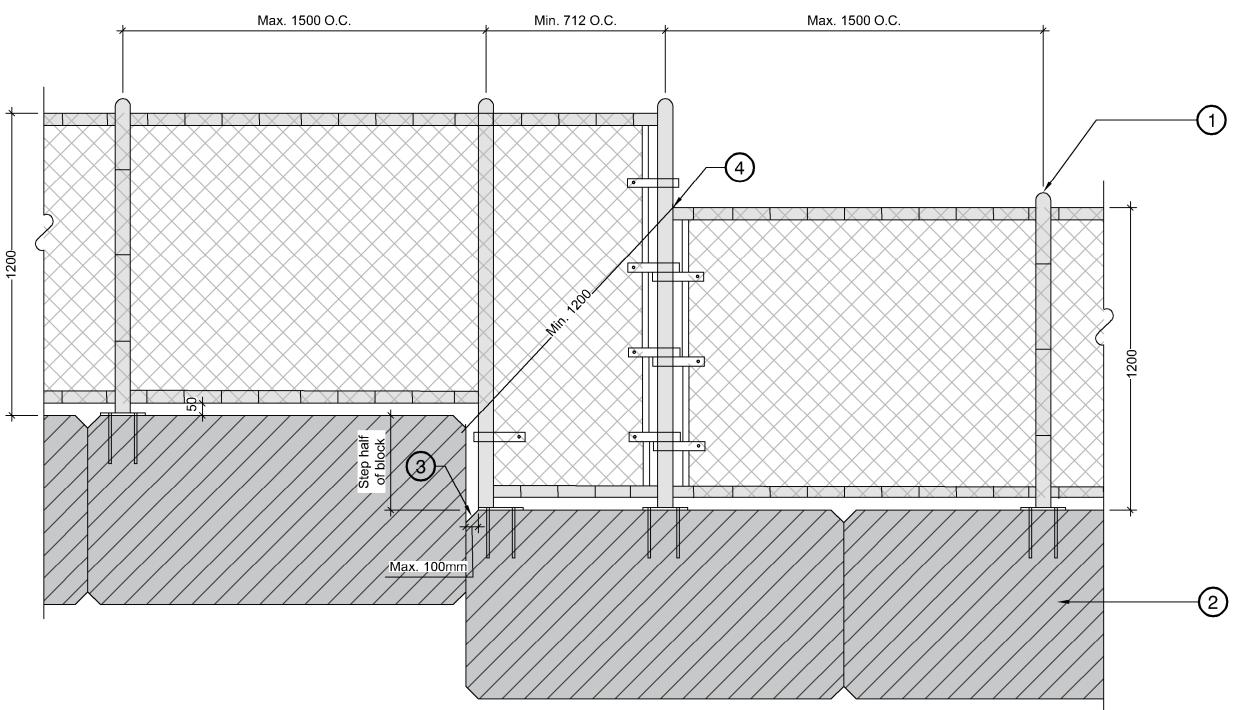

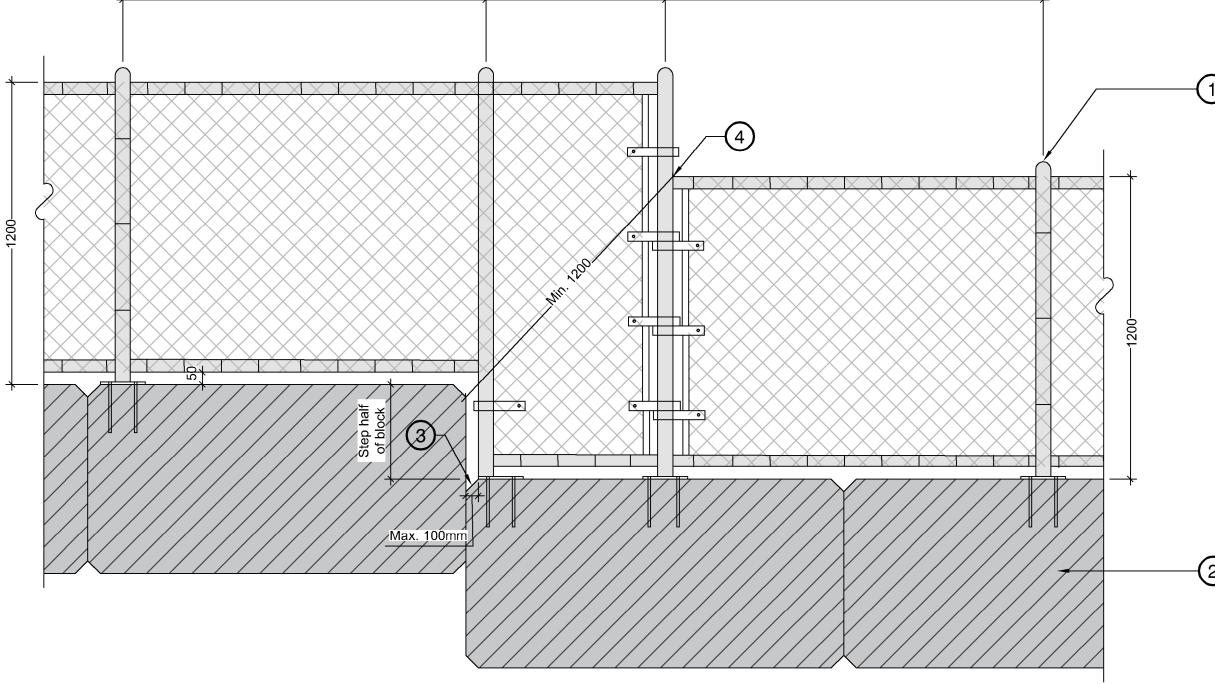

1	Guardrail.	Refer to	detail

- 2 Lock Block Unit 3 50mm typical chamfer on lock block. Fence post base plate to align with
- 4 Corner of step in fence to be min. 1.2m from lock block edge as per BCBC
- **Typical Fencing Notes:** 1. Contractor to provide structurally approved detail shop drawings for fencing, gates and anchor plate attachments to Landscape Architect for approval prior to manufacturing.
- 2. All Dimensions are in mm unless noted. 3. All posts, gate posts, rails and hardware to be schedule 40
- galvanized and powder-coated black. 4. All intermediate, top and bottom rails shall be saddle notched with a continuous weld to the vertical post. 4. To be designed and fabricated as per BCBC 2024 Part 3 and 4
- 5. All areas affected by cutting, welding, etc. shall be ground smooth and painted with two coats of black galvicon gloss zinc 5. paint. Allow one (1) day drying between coats. 6. All mesh to be 6 ga. black vinyl coated with 38mm openings. 7. All ties to be 6 ga. black vinyl coated and located at every 2nd

knuckle on rails and posts.

Specific Notes:

powder coat finish.

requirements for guardrails. Guardrail system to have posts spaced @ 1.5m O.C. max, horizontal top guard and bottom guard, and meshed screen fencing, with base plate and post-installed anchors embedded into concrete. Fabricator shall design guardrail system and connections for all BCBC 2024 Part 3 guardrail point load and line load requirements. Finishes to be per project specifications.

Post spacing shall be equidistant to a maximum of 1500mm o.c.

All fittings must be made of first grade malleable iron, pressed

steel or aluminum powder coated and welded in place' black

Contractor to ensure proper coordination between fencing

unless noted otherwise on layout and materials plan.

installation and retaining wall installation.

LANDSCAPE ARCHITECTURE	CIVIL ENGINEERING   URBAN FORESTRY
100-9181 Church Fort Langley, E	IO MOUNT PLEASANT STUDIO St 102-355 Kingsway BC Vancouver, BC R8 V5T 3J7
www.vdz.ca	604-882-0024

I IVI	Issued for RFP	May 05, 2025		
TM	Issued for 100%	March 25, 2025		
TM	Issued for 100%	Jan 17, 2025		
TM	Issued for 100% Draft	Dec 16, 2024		
TM	Issued for 95% Review	Nov 28, 2024		
TM	Issued for Costing	Jul 12, 2024		
TM	Issued for 75% Coordination	Jul 05, 2024		
TM	Issued for 75% Review	May 08, 2024		
TM	Issued for 75% Review	May 03, 2024		
TM	Re-Issued for 50%	Apr 03, 2024		
TM	Issued for 50%	Mar 22, 2024		
TM	Issued for Review	May 06, 2023		
Ву:	Description	Date		
	and may not be reproduced or used for permission.	other projects		
Ву:	Description	Date		
R	EVISIONS TABLE FOR SE	HEET		
Project:  BURKE MOUNTAIN ATHLETIC PARK  Location:  3390 & 3400 DAVID AVENUE,  COQUITLAM, B.C.				

Original Sheet Size:

CONTRACTOR SHALL CHECK ALL DIMENSIONS ON THE WORK AND REPORT

ANYDISCREPANCY TO THE CONSULTANT BEFORE PROCEEDING. ALL DRAWINGS
AND SPECIFICATIONS ARE THE EXCLUSIVE

PROPERTY OF THE OWNER AND MUST BE

RETURNED AT THE COMPLETION OF THE

WORK. ALL REZONING/DP/PPA/FHA/BP DRAWINGS MUST NOT BE PRICED FOR CONSTRUCTION UNLESS LABELED ISSUED

FOR TENDER/CONSTRUCTION.

24"x36"

Drawn:

Checked:

Approved:

Scale:

AS SHOWN

TM

May 05, 2025

1.2M CHAIN LINK GUARDRAIL AT LIGHT POSTS

All Dimensions are in mm unless noted.

galvanized and powder-coated black.

knuckle on rails and posts.

powder coat finish.

specifications.

requirements for guardrails.

Specific Notes:

with a continuous weld to the vertical post.

All posts, gate posts, rails and hardware to be schedule 40

4. All intermediate, top and bottom rails shall be saddle notched

5. All areas affected by cutting, welding, etc. shall be ground smooth and painted with two coats of black galvicon gloss zinc paint. Allow one (1) day drying between coats. All mesh to be 6 ga. black vinyl coated with 38mm openings. All ties to be 6 ga. black vinyl coated and located at every 2nd

. Post spacing shall be equidistant to a maximum of 1500mm o.c. unless noted otherwise on layout and materials plan. 2. All fittings must be made of first grade malleable iron, pressed steel or aluminum powder coated and welded in place' black

Contractor to ensure proper coordination between fencing

4. To be designed and fabricated as per BCBC 2024 Part 3 and 4

Guardrail system to have posts spaced @ 1.5m O.C. max, horizontal top guard and bottom guard, and meshed screen

fencing, with base plate and post-installed anchors embedded

connections for all BCBC 2024 Part 3 guardrail point load and


into concrete. Fabricator shall design guardrail system and

line load requirements. Finishes to be per project

installation and retaining wall installation.


P-PR202304-113

CHAIN LINK GUARDRAIL TRAVERSING STEPPED LOCK BLOCK WALL

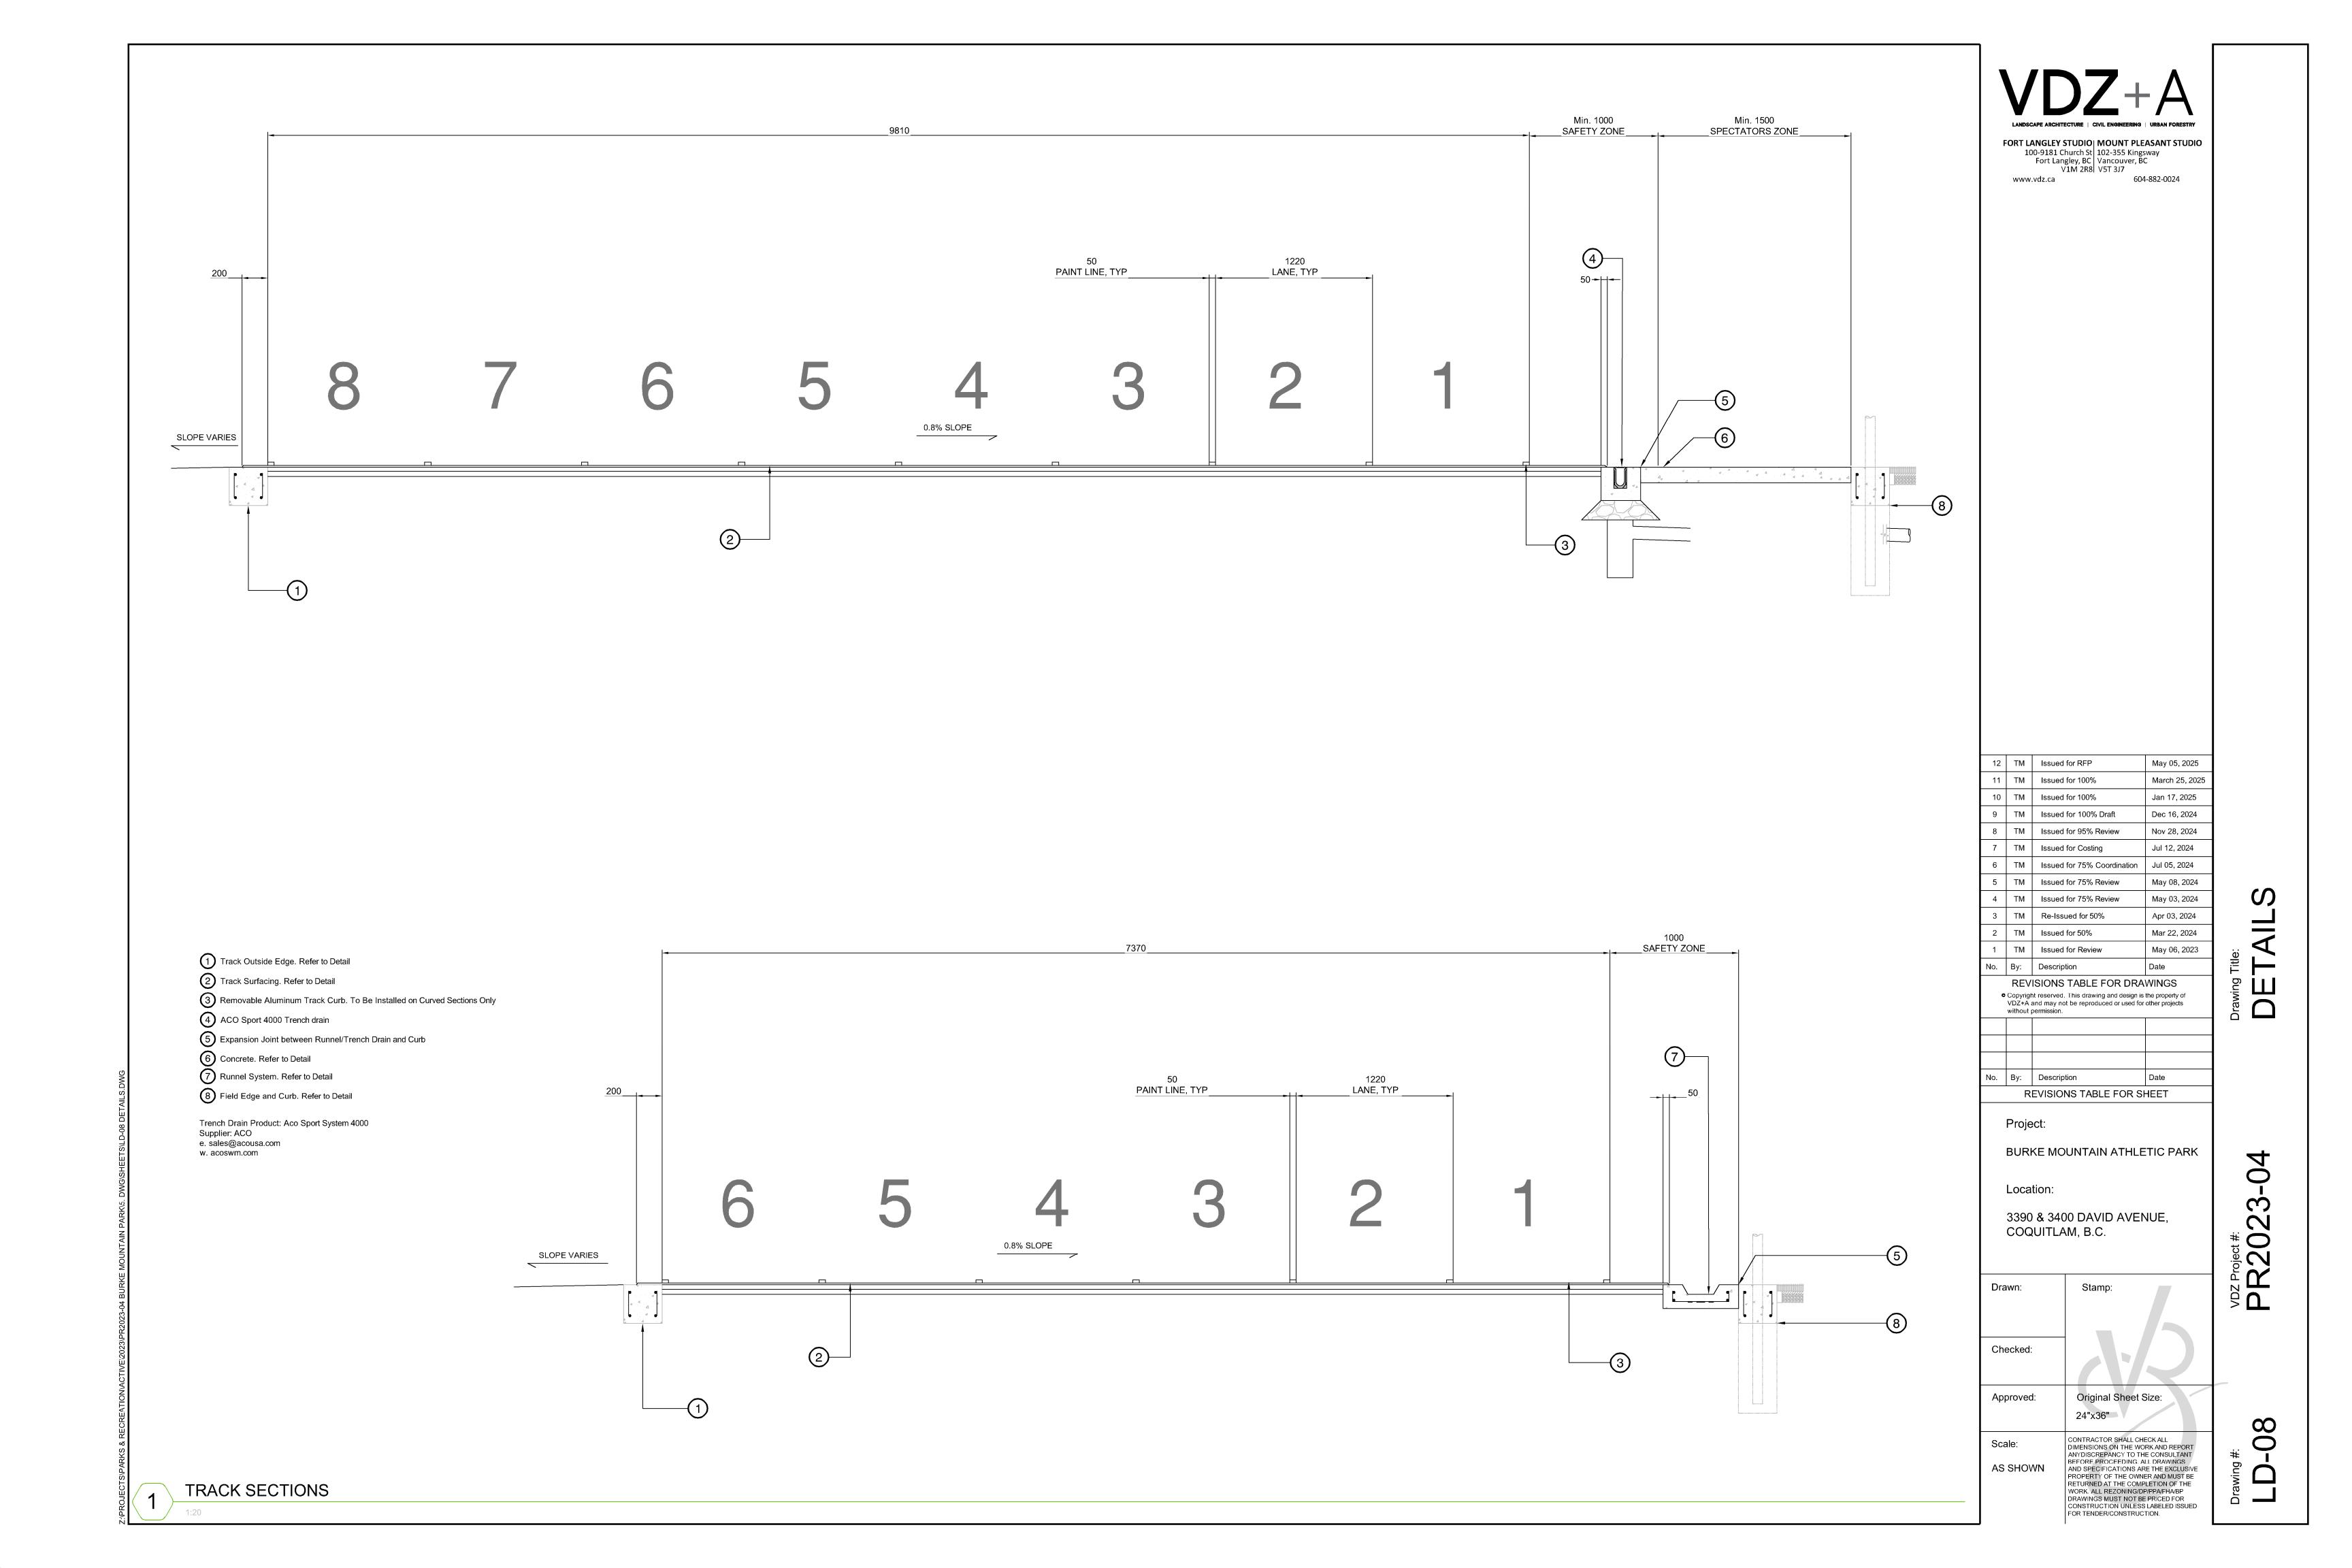

SCALE: 1:500

OVERALL

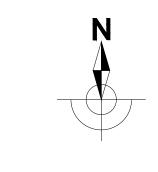



4	DEP	Issued for FP	May 05, 2025	
3	DEP	100% Design	March 24, 20	
2	DEP	Issued for Final 100% Design	Jan. 17, 202	
1	DEP	Issued for 100% Draft Review	Dec. 16, 202	
No.	Ву:	Description	Date	
REVISIONS TABLE FOR DRAWINGS				
•	<ul> <li>Copyright reserved. This drawing and design is the property of VDZ+A and may not be reproduced or used for other projects.</li> </ul>			

<ul> <li>Copyright reserved. This drawing and design is the property of VDZ+A and may not be reproduced or used for other projects without permission.</li> </ul>				
2	DEP	Updated Base Plan & Charts	May 05, 2025	
1	DEP	Updated Tree Layout	March 19, 2025	
No.	Ву:	Description	Date	
REVISIONS TABLE FOR SHEET				

Project:

Location:

BURKE MOUNTAIN PARK

3390 & 3400 DAVID AVENUE. COQUITLAM, BC

Drawn:	Stamp:
D.E.P.	COMMER
Checked:	第一類W 多
ТМ	AVID PETER MAN
Approved:	Original Sheet Size:
TM	24"x36"

CONTRACTOR SHALL CHECK ALL DIMENSIONS ON THE WORK AND REPORT ANY DISCREPANCY TO THE CONSULTANT BEFORE PROCEEDING. ALL DRAWINGS AND SPECIFICATIONS ARE THE EXCLUSIVE PROPERTY OF THE OWNER AND MUST BE RETURNED AT THE COMPLETION OF THE DRAWINGS MUST NOT BE PRICED FOR CONSTRUCTION UNLESS LABELED ISSUED FOR TENDER/CONSTRUCTION.

VDZ Projv.
PR20,

# LEGEND

SYMBOL	DESCRIPTION
©	IRRIGATION CONTROLLER - TORO SENTINEL DXI, 2-WIRE ACCONTROLLER CABINET TO BE A STAINLESS STEEL WALL MOUNT - INCLUDES A TORO M8C CELLULAR KIT & ANTENNA MODEL NUMBER TO BE VERIFIED FROM TORO
• • •	RAINBIRD 1806-SAM-PRS SERIES, 100mm FIXED POP-UP SPRAY HEAD - MPR NOZZLES per Plans
<b>○ • • </b>	RAINBIRD 1812-SAM-PRS SERIES, 150mm FIXED POP-UP SPRAY HEAD - MPR NOZZLES per Plans
	RAINBIRD 5004+SAM-PRS SERIES, 125mm MEDIUM POP-UP ROTOR with RAIN CURTAIN NOZZLES - Sized per Plans
	RAINBIRD PEB SERIES ECV with 24V. SOLENOID PRE-INSTALLED - Size per Plans
	RAINBIRD ROOT WATERING SYSTEM: RWS-B-C-1402 w/SOC
<b>*</b>	50mm BRASS DRAIN VALVE ASSEMBLY
■ QC	RAINBIRD 5RC SERIES 25mm QUICK COUPLER VALVE
X	TOYO 206A R&W ISOLATION GATE VALVE, Size per Pipe
$\overline{\boxtimes}$	75mm POINT OF CONNECTION - LOCATION per PLANS
G	TWO-WIRE COPPER GROUNDING PLATE - FROM PAIGE ELECTION DEVICE: SB-BLA
~~~~~	IRRIGATION TWO-WIRE PATHWAY - PAIGE ELEC. P7350D, RED OUTER SHEATHING - #14 GAUGE SINGLE PAIR CABLE SUPPLY & INSTALL A SINGLE CONDUCTOR SPARE WIRE, CSA APPROVED #14 TWU-40 FOR ENTIRE PATHWAY - BLUE
	50mm/75mm SCH40 CSA PVC MAINLINE PIPE - SW*
	25mm - 50mm CLASS 200 CSA PVC LATERAL PIPE - SW*
**********	SCH40 PVC SLEEVING - MIN. 100mm or 2 x TOTAL PIPE DIA.
	50mm DB2 PVC WIRE CONDUIT


\* NOTE: (SW) - SOLVENT WELD


NOTE: ALL CONSTRUCTION INSTALLATION DETAIL CALL-OUTS WILL REFER TO THE CITY OF COQUITLAM - PARK DEVELOPMENT STANDARD DRAWINGS AS PROVIDED - TYP.


PIPE SIZI	NG C	HARI
SPRINKLER	# OF SPK's	PIPE SIZE
RAINBIRD 1806/12-SAM-PRS	1-12	25mm
RAINBIRD 1806/12-SAM-PRS	13-25	38mm
RAINBIRD 1806/12-SAM-PRS	26-40	50mm
RAINBIRD 5004+SAM-PRS-PC	1-5	25mm
RAINBIRD 5004+SAM-PRS-PC	6-12	38mm
RAINBIRD 5004+SAM-PRS-PC	13-20	50mm
RAINBIRD 5004+SAM-PRS-FC	2	25mm
RAINBIRD 5004+SAM-PRS-FC	3-6	38mm
RAINBIRD 5004+SAM-PRS-FC	7-9	50mm

# NOZZLE CHART

SPRINKLER	NOZZLE SIZE
RAINBIRD 1806/12-SAM-PRS	MPR - Per Plans
RAINBIRD 5004+SAM-PRS QUARTER CIRCLE	1.5 US GPM
RAINBIRD 5004+SAM-PRS HALF CIRCLE	3.0 US GPM
RAINBIRD 5004+SAM-PRS THREE-QUARTER CIRCLE	4.5 US GPM
RAINBIRD 5004+SAM-PRS FULL CIRCLE	6.0 US GPM

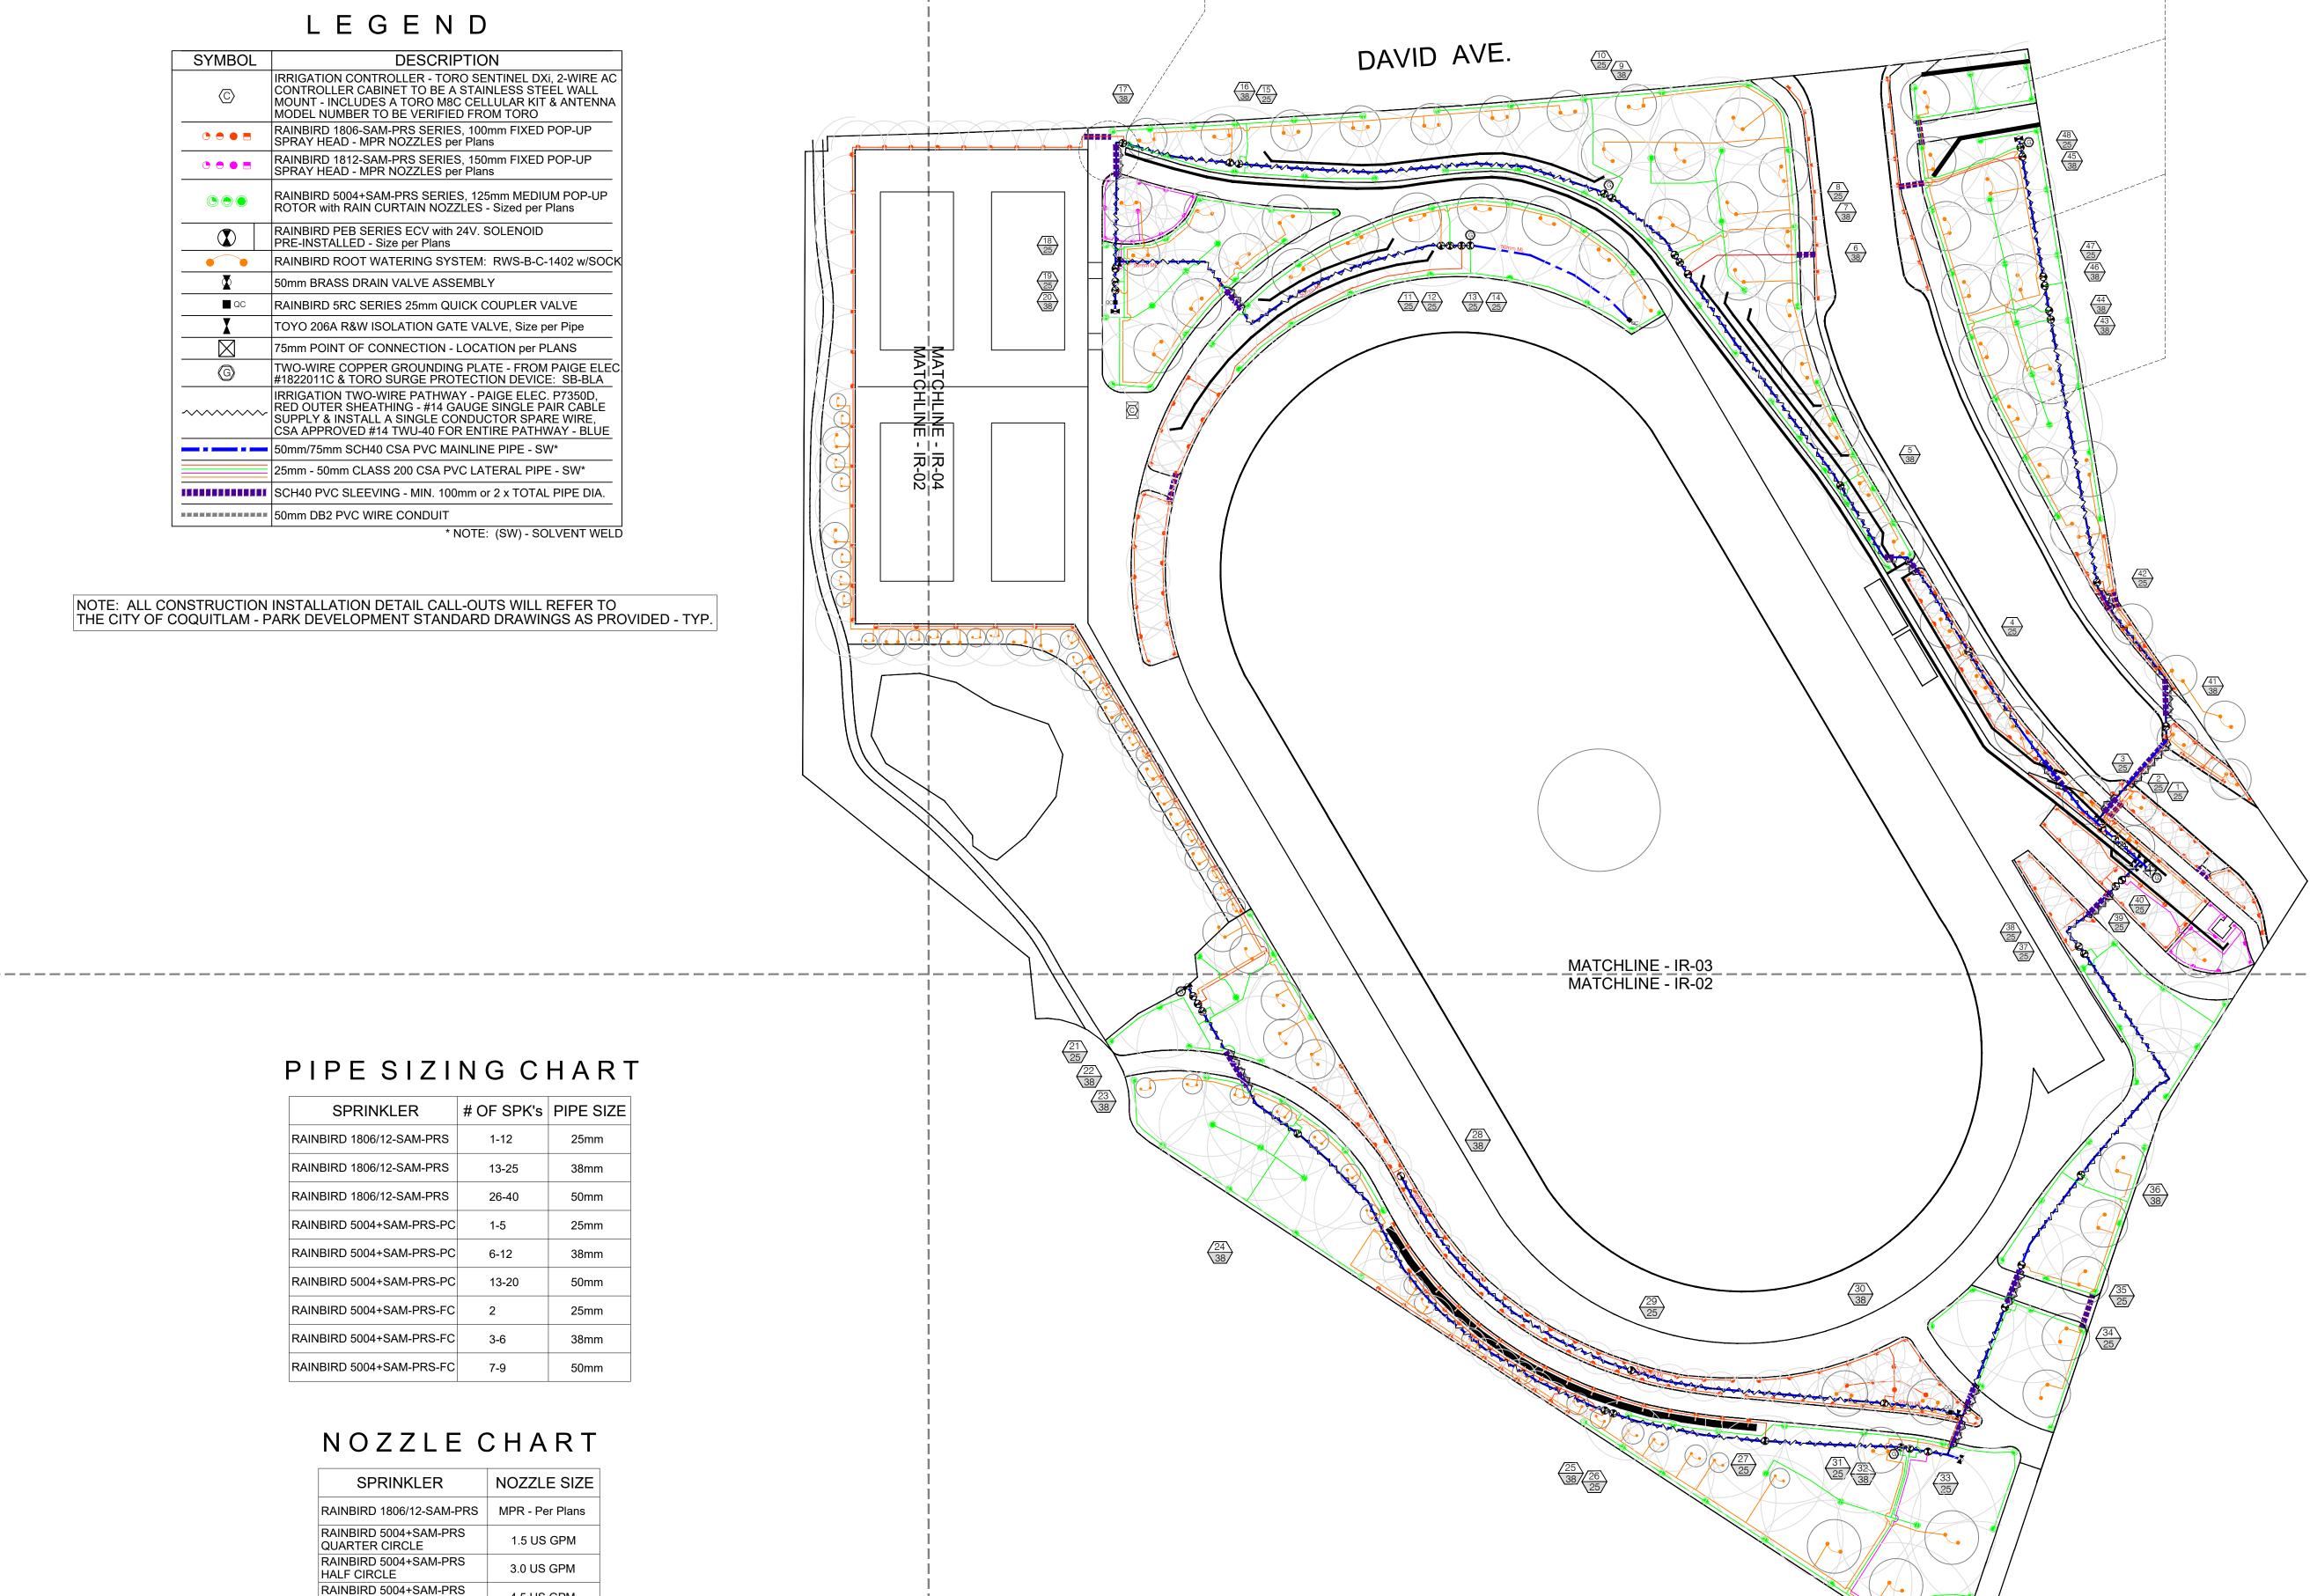

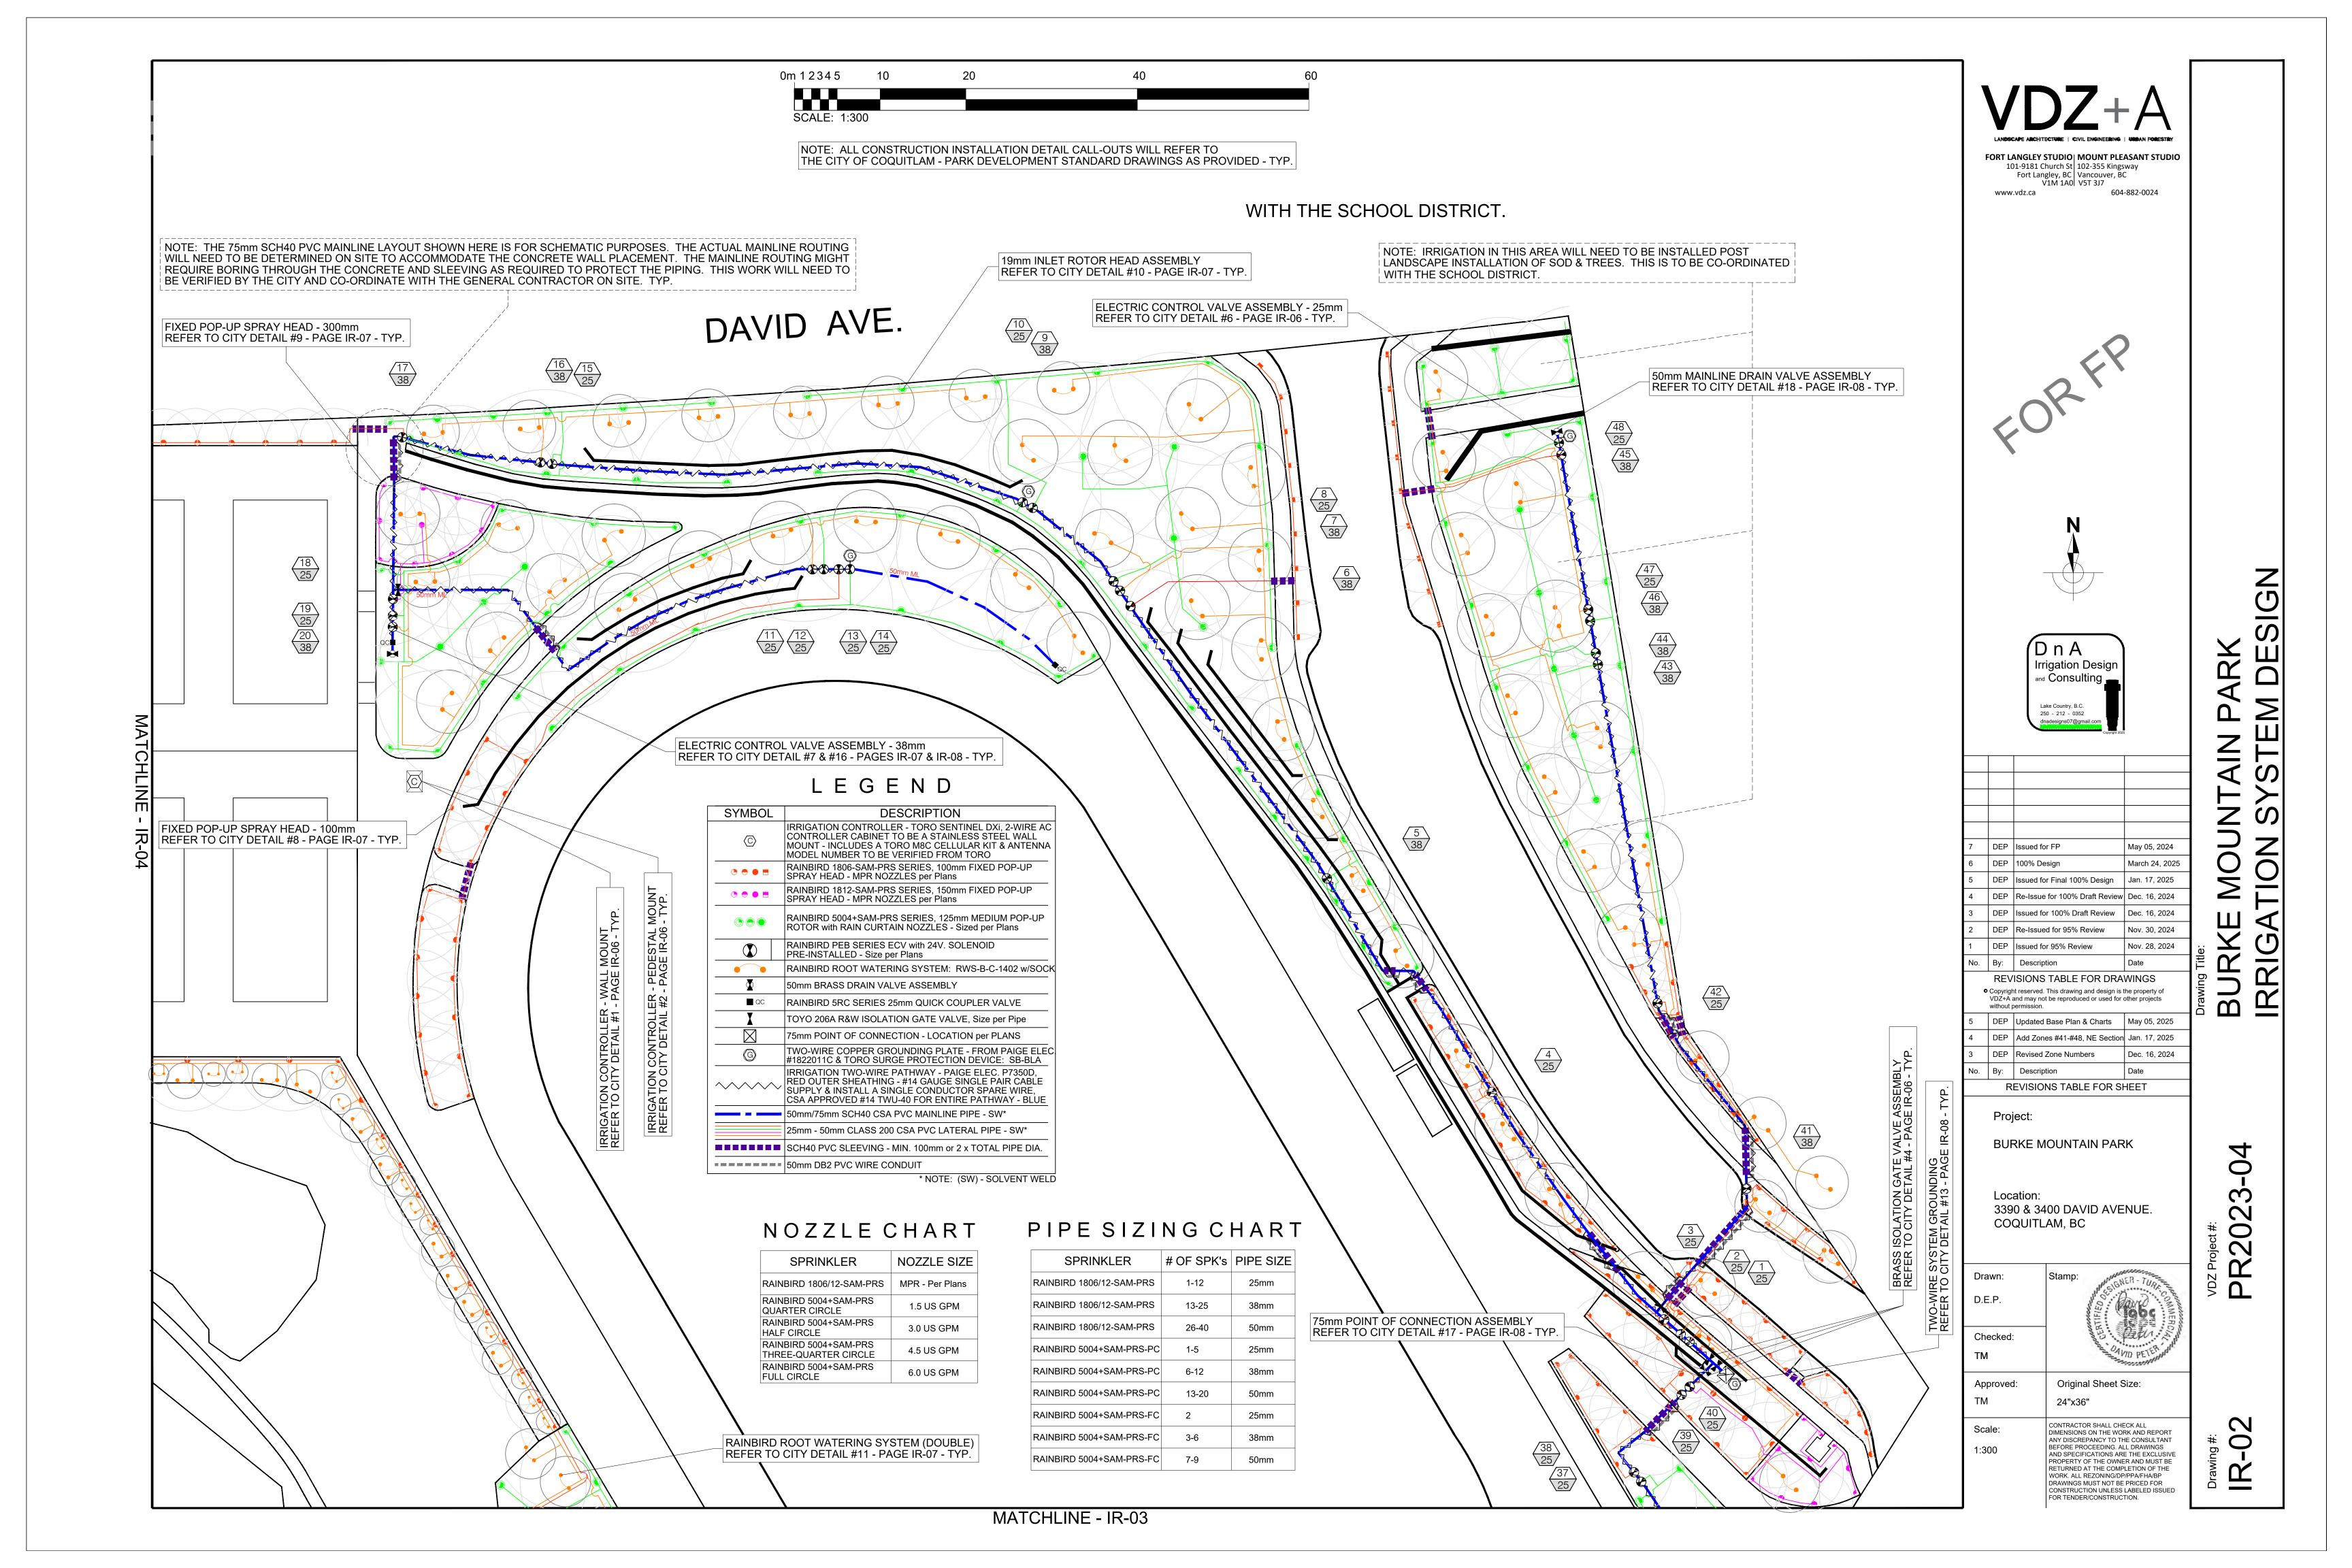


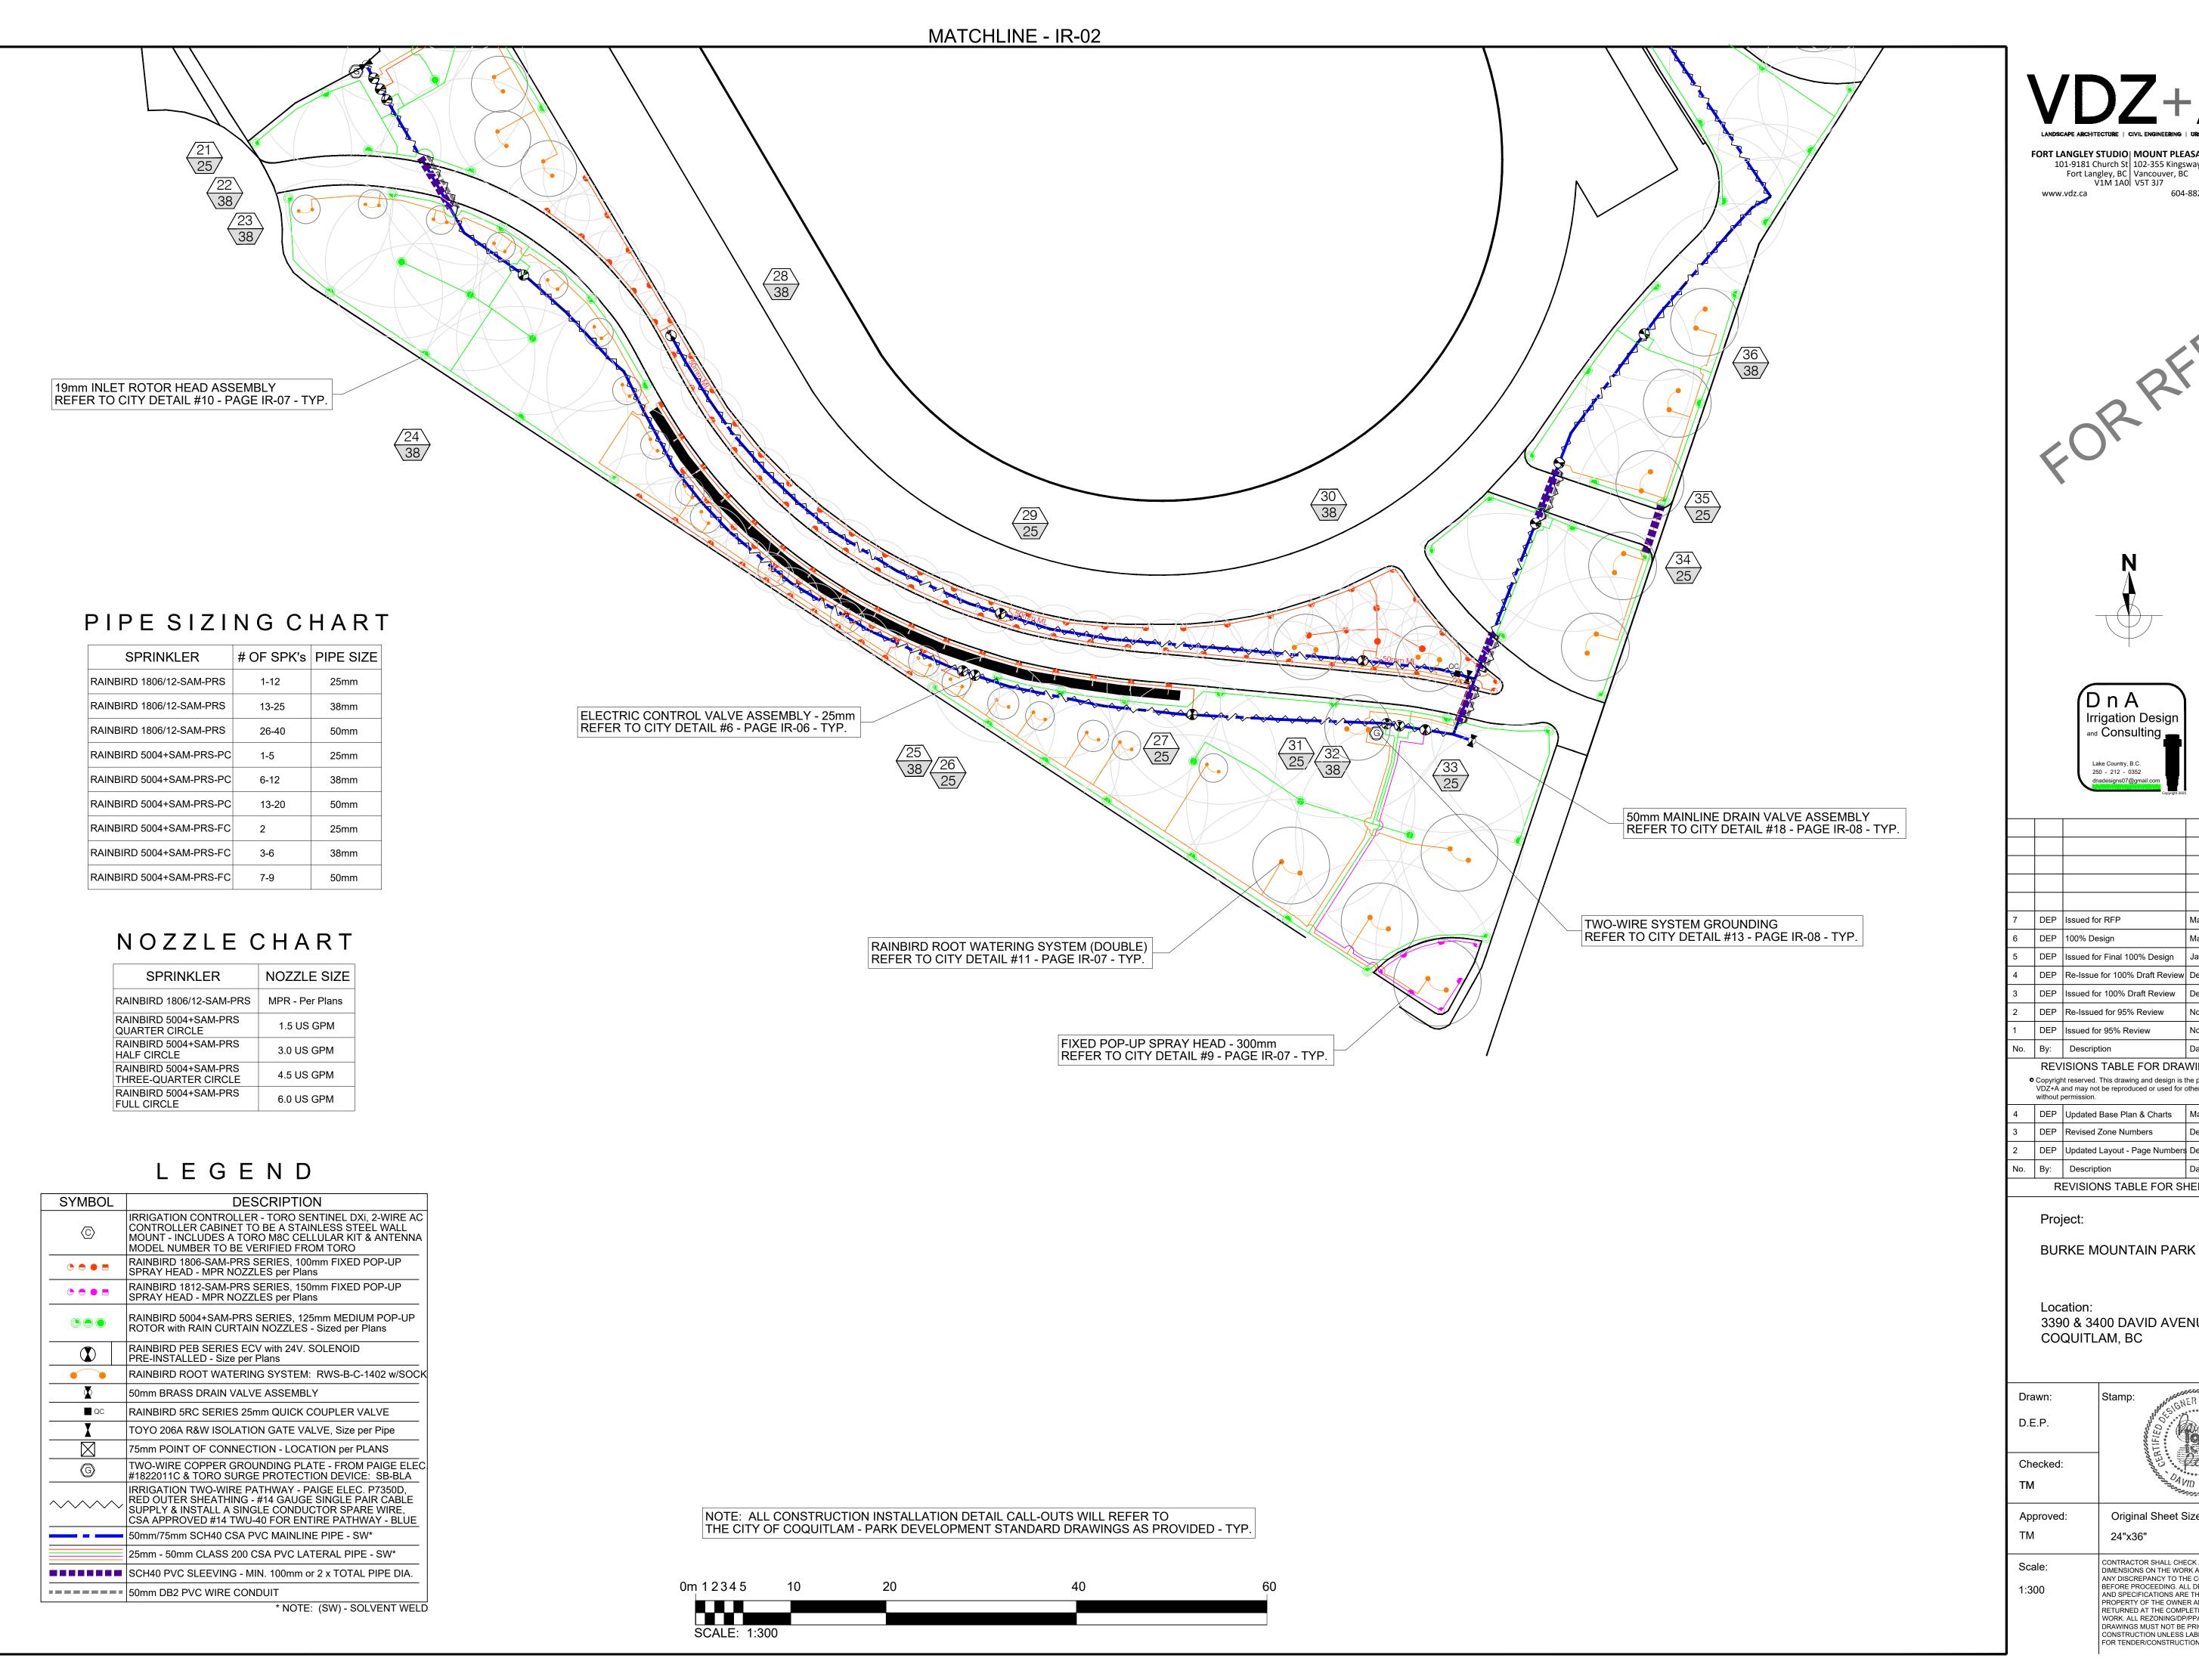

FORT LANGLEY STUDIO

101-9181 Church St
Fort Langley, BC
V1M 1A0

MOUNT PLEASANT STUDIO
102-355 Kingsway
Vancouver, BC
V5T 3J7

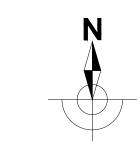



7	DEP	Issued for RFP	May 05, 2024
6	DEP	100% Design	March 24, 202
5	DEP	Issued for Final 100% Design	Jan. 17, 2025
4	DEP	Re-Issue for 100% Draft Review	Dec. 16, 2024
3	DEP	Issued for 100% Draft Review	Dec. 16, 2024
2	DEP	Re-Issued for 95% Review	Nov. 30, 2024
1	DEP	Issued for 95% Review	Nov. 28, 2024
No.	Ву:	Description	Date
	REV	ISIONS TABLE FOR DRA	WINGS
0	VDZ+A	nt reserved. This drawing and design is to and may not be reproduced or used for opermission.	
4	DEP	Updated Base Plan & Charts	May 05, 2025

	without p				
4	DEP	Updated Base Plan & Charts	May 05, 2025		
3	DEP	Revised Zone Numbers	Dec. 16, 2024		
2	DEP	Updated Layout - Page Numbers	Dec. 16, 2024		
No.	Ву:	Description	Date		
REVISIONS TABLE FOR SHEET					

Project:

Location: 3390 & 3400 DAVID AVENUE.

Drawn:	Stamp:
D.E.P.	Stamp: St
Checked:	10.黄桃、
ТМ	AVID PETER
Approved:	Original Sheet Size:
TM	24"x36"
	CONTRACTOR CHALL CHECK ALL

CONTRACTOR SHALL CHECK ALL DIMENSIONS ON THE WORK AND REPORT ANY DISCREPANCY TO THE CONSULTANT BEFORE PROCEEDING ALL DRAWINGS AND SPECIFICATIONS ARE THE EXCLUSIVE PROPERTY OF THE OWNER AND MUST BE RETURNED AT THE COMPLETION OF THE WORK. ALL REZONING/DP/PPA/FHA/BP DRAWINGS MUST NOT BE PRICED FOR CONSTRUCTION UNLESS LABELED ISSUED FOR TENDER/CONSTRUCTION.

0

3

### Toro 2-Wire Decoder System Specifications

- 1. ALL COMMUNICATION CABLE SPLICES MUST ALWAYS FOLLOW THE FACTORY COLOR CODE, (BLACK TO BLACK, WHITE TO WHITE).
- 2. ALL ELECTRIC CONTROL VALVES (ECV'S) MUST BE EQUIPPED WITH 24 VOLT AC SOLENOIDS.
- 3. ALL DECODER TO SOLENOID WIRES MUST BE CONNECTED WITH THE CORRECT ORDER TO PROPERLY OPERATE THE SOLENOID.
- 4. THE TORO AC 2-WIRE FIELD DECODERS RED & BLACK OUTPUT WIRES MUST BE CONNECTED ONLY TO THE 2-WIRE PATHWAY (BLK & WHITE CONDUCTORS).
- 5. THE TORO AC 2-WIRE FIELD DECODERS COLORED OUTPUT WIRES MUST BE CONNECTED ONLY TO THE 24V SOLENOID LEADS.
- 6. IF ADDITIONAL STATION OUTPUT WIRES ARE NOT BEING USED, INSTALL A WIRE NUT ON EACH END AND PLACE IN A DBY/R WATER PROOF CONNECTOR.
- 7. ALL COMMUNICATION CABLE SPLICES ARE TO BE WATERPROOF USING A 3M DBY/R SPLICE KIT.
- 8. ALL TORO AC 2-WIRE DECODER SYSTEMS MUST BE PROPERLY GROUNDED TO PROTECT FROM POWER & LIGHTNING SURGES.
- 9. THE 2-WIRE COMMUNICATION CABLE MUST BE GROUNDED NO FURTHER THAN 300m FROM ANY DECODER.
- 10. THE SURGE PROTECTION DEVICE (TORO SB-BLA) MUST BE GROUNDED TO A COPPER GROUNDING PLATE. (100mm x 300mm)
- 11. DO NOT LOOP OR JOIN TOGETHER THE 2-WIRE DECODER PATHWAYS BACK TO THE CONTROLLER CIRCUIT BOARD.
- 12. ALL 2-WIRE PATHWAYS FROM THE CONTROLLER CIRCUIT BOARD ARE TO END AT A DECODER INSTALLED IN A VALVE BOX.
- 13. ABSOLUTELY ALL WIRE SPLICES MUST BE JOINED TOGETHER WITH THE USE OF AN APPROVED WIRE SPLICE KIT (3M DBY/R).
- 14. ALL COMMUNICATION CABLE TO BE CONSISTENT TYPE/SIZE THROUGHOUT PROJECT. (PAIGE WIRE, P7350D, AWG/2C, #14 GAUGE, PE UL).
- 15. THE ENTIRE TORO AC 2-WIRE CONTROL SYSTEM MUST BE INSTALLED ACCORDING TO THE TORO COMPANY FACTORY SPECIFICATIONS.
- 16. FOR ADDITIONAL INFORMATION ON THE INSTALLATION OF THIS TORO AC 2-WIRE DECODER SYSTEM PLEASE REFER TO: www.toro.com

# PIPE SIZING CHART

SPRINKLER	# OF SPK's	PIPE SIZE
RAINBIRD 1806/12-SAM-PRS	1-12	25mm
RAINBIRD 1806/12-SAM-PRS	13-25	38mm
RAINBIRD 1806/12-SAM-PRS	26-40	50mm
RAINBIRD 5004+SAM-PRS-PC	1-5	25mm
RAINBIRD 5004+SAM-PRS-PC	6-12	38mm
RAINBIRD 5004+SAM-PRS-PC	13-20	50mm
RAINBIRD 5004+SAM-PRS-FC	2	25mm
RAINBIRD 5004+SAM-PRS-FC	3-6	38mm
RAINBIRD 5004+SAM-PRS-FC	7-9	50mm


### NOZZLE CHART

SPRINKLER	NOZZLE SIZE
RAINBIRD 1806/12-SAM-PRS	MPR - Per Plans
RAINBIRD 5004+SAM-PRS QUARTER CIRCLE	1.5 US GPM
RAINBIRD 5004+SAM-PRS HALF CIRCLE	3.0 US GPM
RAINBIRD 5004+SAM-PRS THREE-QUARTER CIRCLE	4.5 US GPM
RAINBIRD 5004+SAM-PRS FULL CIRCLE	6.0 US GPM

### LEGEND

SYMBOL	DESCRIPTION
©	IRRIGATION CONTROLLER - TORO SENTINEL DXI, 2-WIRE AC CONTROLLER CABINET TO BE A STAINLESS STEEL WALL MOUNT - INCLUDES A TORO M8C CELLULAR KIT & ANTENNA MODEL NUMBER TO BE VERIFIED FROM TORO
• • • <b>=</b>	RAINBIRD 1806-SAM-PRS SERIES, 100mm FIXED POP-UP SPRAY HEAD - MPR NOZZLES per Plans
• • • =	RAINBIRD 1812-SAM-PRS SERIES, 150mm FIXED POP-UP SPRAY HEAD - MPR NOZZLES per Plans
	RAINBIRD 5004+SAM-PRS SERIES, 125mm MEDIUM POP-UP ROTOR with RAIN CURTAIN NOZZLES - Sized per Plans
	RAINBIRD PEB SERIES ECV with 24V. SOLENOID PRE-INSTALLED - Size per Plans
	RAINBIRD ROOT WATERING SYSTEM: RWS-B-C-1402 w/SOCK
<b>∑</b>	50mm BRASS DRAIN VALVE ASSEMBLY
■ QC	RAINBIRD 5RC SERIES 25mm QUICK COUPLER VALVE
<b>X</b>	TOYO 206A R&W ISOLATION GATE VALVE, Size per Pipe
	75mm POINT OF CONNECTION - LOCATION per PLANS
G	TWO-WIRE COPPER GROUNDING PLATE - FROM PAIGE ELEC #1822011C & TORO SURGE PROTECTION DEVICE: SB-BLA
\\\\\\\\\\\\\\\\\\\\\\\\\\\\\\\\\\\\\\	IRRIGATION TWO-WIRE PATHWAY - PAIGE ELEC. P7350D, RED OUTER SHEATHING - #14 GAUGE SINGLE PAIR CABLE SUPPLY & INSTALL A SINGLE CONDUCTOR SPARE WIRE, CSA APPROVED #14 TWU-40 FOR ENTIRE PATHWAY - BLUE
	50mm/75mm SCH40 CSA PVC MAINLINE PIPE - SW*
	25mm - 50mm CLASS 200 CSA PVC LATERAL PIPE - SW*
	SCH40 PVC SLEEVING - MIN. 100mm or 2 x TOTAL PIPE DIA.
	50mm DB2 PVC WIRE CONDUIT

\* NOTE: (SW) - SOLVENT WELD

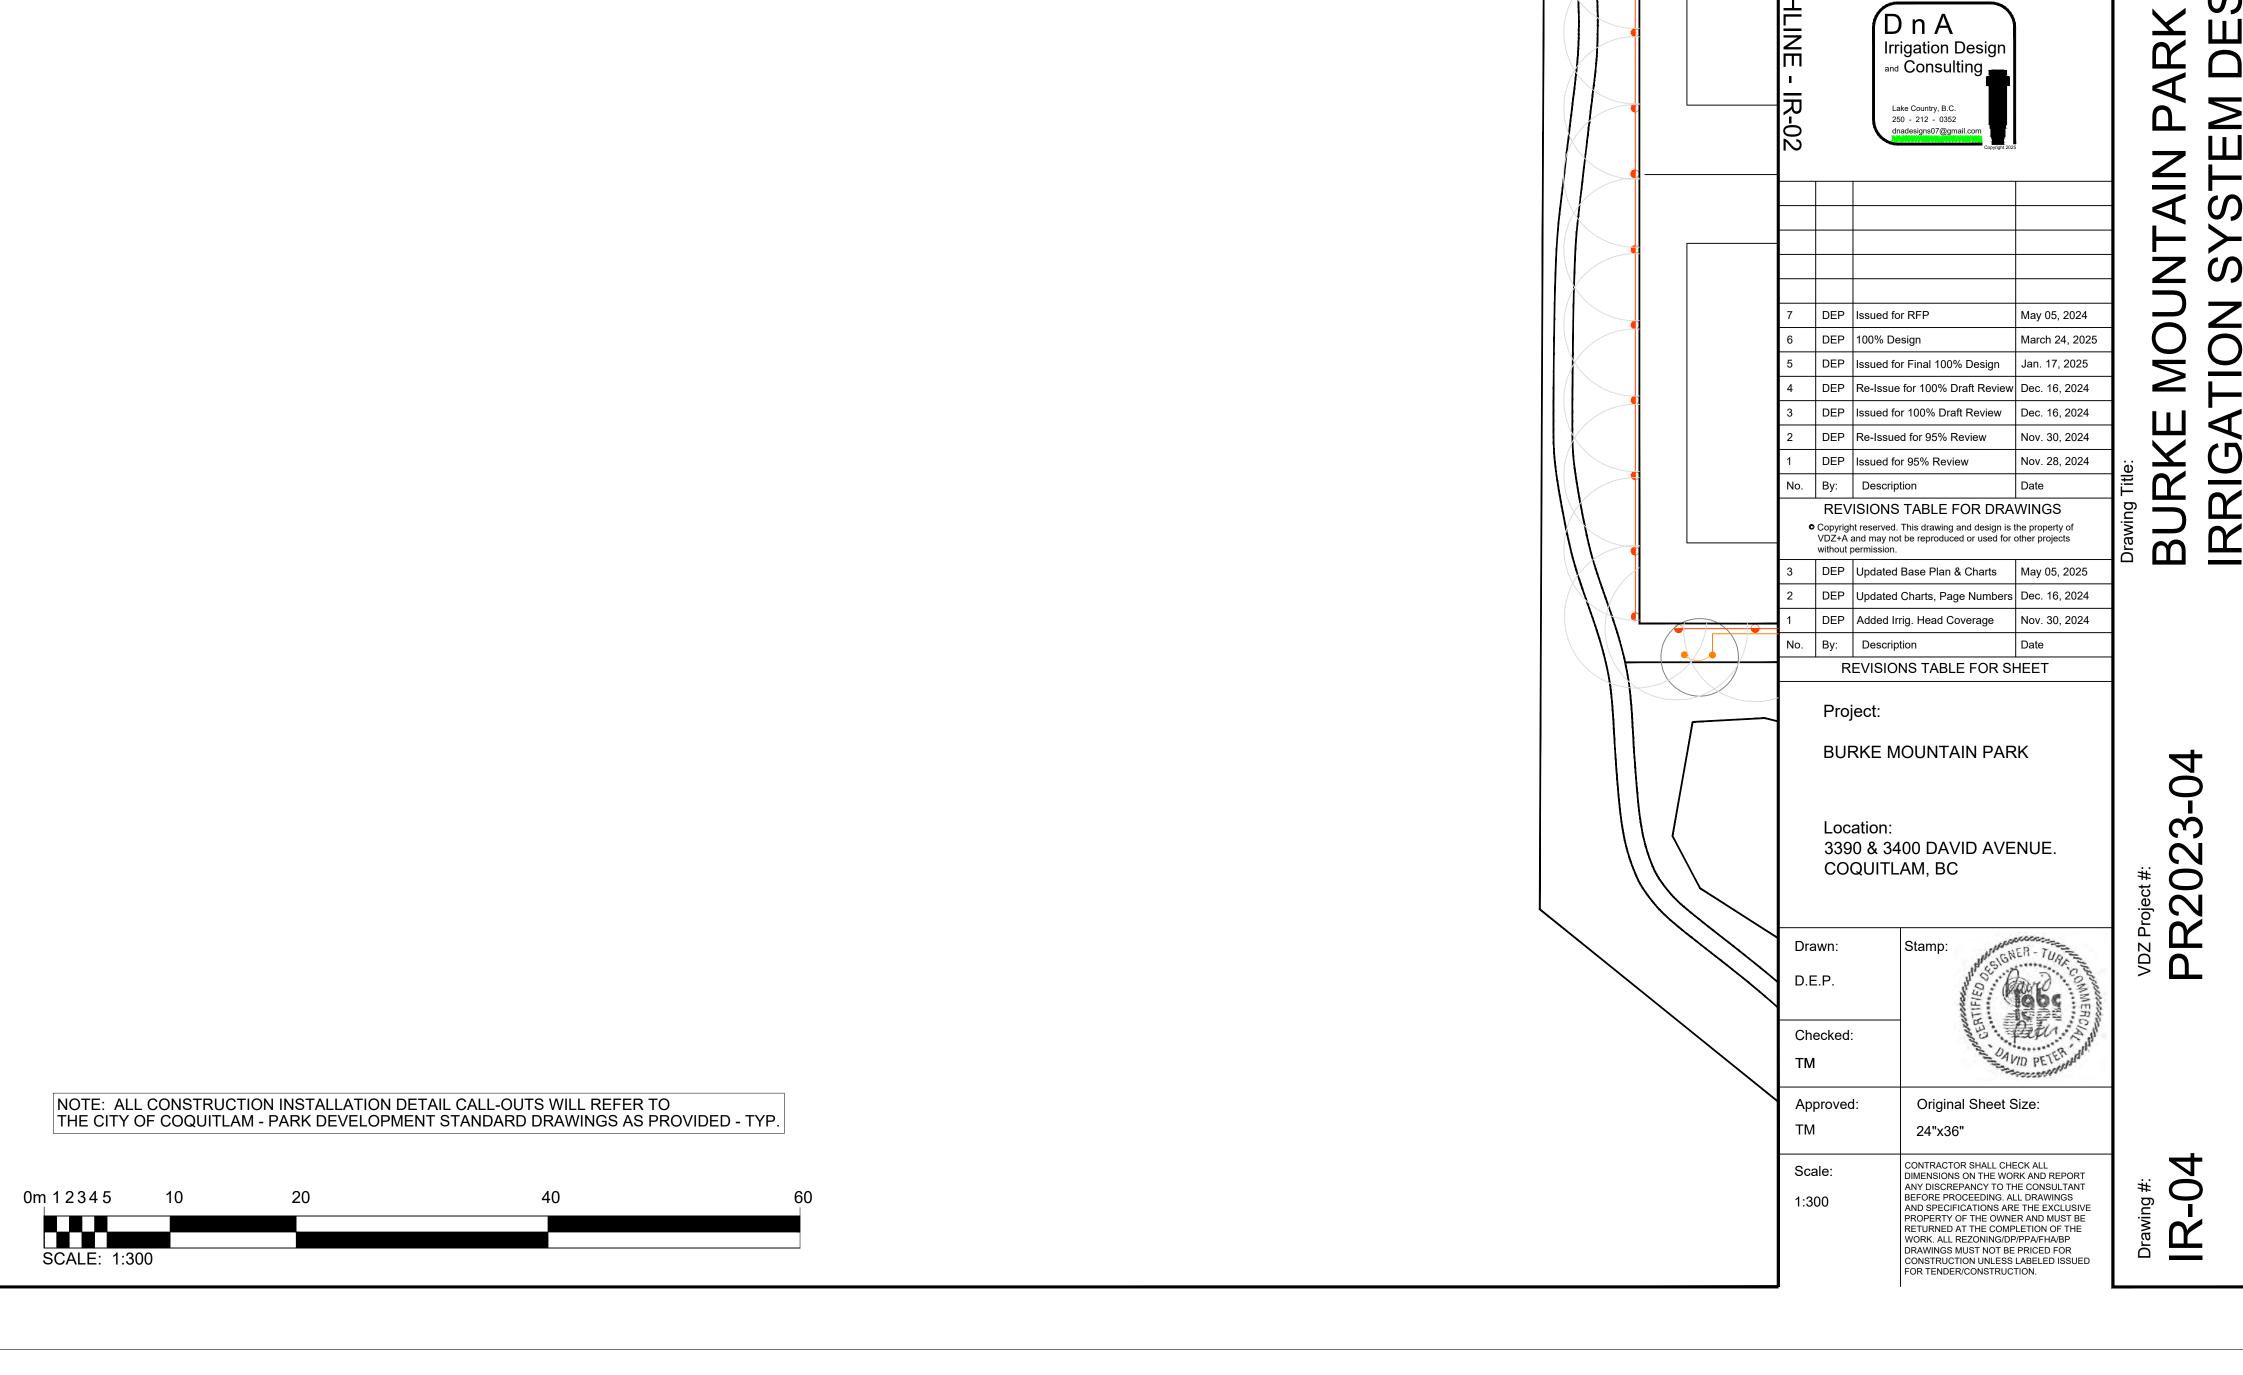

FORT LANGLEY STUDIO | MOUNT PLEASANT STUDIO | 101-9181 Church St | 102-355 Kingsway

Fort Langley, BC Vancouver, BC V1M 1A0 V5T 3J7

### IRRIGATION SCHEDULE & ZONE DATA

STA. #	ZONE DESCRIPTION	SPRINKLER MAKE, MODEL & TYPE	NOZZLE TYPE	ECV SIZE	DESIGN PSI ECV SETTING	DESIGN FLOW U.S.G.P.M.	PRECIPITATION RATE	RUN DAYS	PROGRAM DAYS	RUN TIME Minutes
1	FIXED SPRAY POP-UP SPRINKLER	RAINBIRD 1806-SAM-PRS	MPR - PER PLAN	25mm	40	U.S.G.P.W.	1.54	4	EVEN	15
2	RAINBIRD RWS - TREE BUBBLER	RAINBIRD RWS-B-C-1402-SOCKED	0.5 GPM	25mm	50			4	EVEN	30
3	FIXED SPRAY POP-UP SPRINKLER	RAINBIRD 1806-SAM-PRS	MPR - PER PLAN	25mm	40		1.54	4	EVEN	15
4	FIXED SPRAY POP-UP SPRINKLER	RAINBIRD 1806-SAM-PRS	MPR - PER PLAN	25mm	40		1.54	4	EVEN	15
5	MEDIUM POP-UP ROTOR - PC	RAINBIRD 5004+SAM-PRS	per PLAN	38mm	55		0.45	4	EVEN	50
6	FIXED SPRAY POP-UP SPRINKLER	RAINBIRD 1806-SAM-PRS	MPR - PER PLAN	38mm	40		1.54	4	EVEN	15
7	RAINBIRD RWS - TREE BUBBLER	RAINBIRD RWS-B-C-1402-SOCKED	0.5 GPM		50			4	EVEN	30
				38mm			0.45	<u> </u>		
8	MEDIUM POP-UP ROTOR - FC	RAINBIRD 5004+SAM-PRS	per PLAN	25mm	55		0.45	4	EVEN	50x2
9	MEDIUM POP-UP ROTOR - PC	RAINBIRD 5004+SAM-PRS	per PLAN	38mm	55		0.45	4	EVEN	50
10	MEDIUM POP-UP ROTOR - PC	RAINBIRD 5004+SAM-PRS	per PLAN	25mm	55		0.45	4	EVEN	50
11	RAINBIRD RWS - TREE BUBBLER	RAINBIRD RWS-B-C-1402-SOCKED	0.5 GPM	25mm	50			4	EVEN	30
12	MEDIUM POP-UP ROTOR - PC	RAINBIRD 5004+SAM-PRS	per PLAN	25mm	55		0.45	4	EVEN	50
13	FIXED SPRAY POP-UP SPRINKLER	RAINBIRD 1806-SAM-PRS	MPR - PER PLAN	25mm	40		1.54	4	EVEN	15
14	MEDIUM POP-UP ROTOR - PC	RAINBIRD 5004+SAM-PRS	per PLAN	25mm	55		0.45	4	EVEN	50
15	MEDIUM POP-UP ROTOR - PC	RAINBIRD 5004+SAM-PRS	per PLAN	25mm	55		0.45	4	EVEN	50
16	RAINBIRD RWS - TREE BUBBLER	RAINBIRD RWS-B-C-1402-SOCKED	0.5 GPM	38mm	50			4	EVEN	30
17	FIXED SPRAY POP-UP SPRINKLER	RAINBIRD 1806-SAM-PRS	MPR - PER PLAN	38mm	40	Ш Z	1.54	4	EVEN	15
18	FIXED SPRAY POP-UP SPRINKLER	RAINBIRD 1812-SAM-PRS	MPR - PER PLAN	25mm	40	Σ	1.54	4	EVEN	15
19	MEDIUM POP-UP ROTOR - PC/FC	RAINBIRD 5004+SAM-PRS	per PLAN	38mm	55	$oldsymbol{C}$	0.42	4	EVEN	55
20	RAINBIRD RWS - TREE BUBBLER	RAINBIRD RWS-B-C-1402-SOCKED	0.5 GPM	25mm	50	Ш		4	EVEN	30
21	RAINBIRD RWS - TREE BUBBLER	RAINBIRD RWS-B-C-1402-SOCKED	0.5 GPM	25mm	50	Щ		4	EVEN	30
22	FIXED SPRAY POP-UP SPRINKLER	RAINBIRD 1806-SAM-PRS	MPR - PER PLAN	38mm	40	<u>_</u>	1.54	4	EVEN	15
23	MEDIUM POP-UP ROTOR - PC/FC	RAINBIRD 5004+SAM-PRS	per PLAN	38mm	55	<u>Ш</u>	0.42	4	EVEN	55
24	MEDIUM POP-UP ROTOR - PC/FC	RAINBIRD 5004+SAM-PRS	per PLAN	38mm	55	0	0.42	4	EVEN	55
25	FIXED SPRAY POP-UP SPRINKLER	RAINBIRD 1806-SAM-PRS	MPR - PER PLAN	38mm	40	-	1.54	4	EVEN	15
26	RAINBIRD RWS - TREE BUBBLER	RAINBIRD RWS-B-C-1402-SOCKED	0.5 GPM	25mm	50	<u> </u>		4	EVEN	30
27	FIXED SPRAY POP-UP SPRINKLER	RAINBIRD 1806-SAM-PRS	MPR - PER PLAN	25mm	40	<u> Ш</u>	1.54	4	EVEN	15
	FIXED SPRAY POP-UP SPRINKLER	RAINBIRD 1806-SAM-PRS	MPR - PER PLAN	38mm	40	₹	1.54	4	EVEN	15
28	FIXED SPRAY POP-UP SPRINKLER		MPR - PER PLAN			<u></u>				
29		RAINBIRD 1806-SAM-PRS		25mm	40	<del></del>	1.54	4	EVEN	15
30	FIXED SPRAY POP-UP SPRINKLER	RAINBIRD 1806-SAM-PRS	MPR - PER PLAN	38mm	40	<u> </u>	1.54	4	EVEN	15
31	MEDIUM POP-UP ROTOR - FC	RAINBIRD 5004+SAM-PRS	per PLAN	25mm	55	<del>_</del>	0.45	4	EVEN	50x2
32	MEDIUM POP-UP ROTOR - PC	RAINBIRD 5004+SAM-PRS	per PLAN	38mm	55		0.45	4	EVEN	50
33	FIXED SPRAY POP-UP SPRINKLER	RAINBIRD 1812-SAM-PRS	MPR - PER PLAN	25mm	40		1.54	4	EVEN	15
34	MEDIUM POP-UP ROTOR - PC	RAINBIRD 5004+SAM-PRS	per PLAN	25mm	55		0.45	4	EVEN	50
35	MEDIUM POP-UP ROTOR - PC	RAINBIRD 5004+SAM-PRS	per PLAN	25mm	55		0.45	4	EVEN	50
36	MEDIUM POP-UP ROTOR - PC	RAINBIRD 5004+SAM-PRS	per PLAN	38mm	55		0.45	4	EVEN	50
37	MEDIUM POP-UP ROTOR - PC	RAINBIRD 5004+SAM-PRS	per PLAN	25mm	55		0.45	4	EVEN	50
38	FIXED SPRAY POP-UP SPRINKLER	RAINBIRD 1806-SAM-PRS	MPR - PER PLAN	25mm	40		1.54	4	EVEN	15
39	FIXED SPRAY POP-UP SPRINKLER	RAINBIRD 1806-SAM-PRS	MPR - PER PLAN	25mm	40		1.54	4	EVEN	15
40	FIXED SPRAY POP-UP SPRINKLER	RAINBIRD 1812-SAM-PRS	MPR - PER PLAN	25mm	40		1.54	4	EVEN	15
41	FIXED SPRAY POP-UP SPRINKLER	RAINBIRD 1812-SAM-PRS	MPR - PER PLAN	25mm	40		1.54	4	EVEN	15
42	FIXED SPRAY POP-UP SPRINKLER	RAINBIRD 1812-SAM-PRS	MPR - PER PLAN	25mm	40		1.54	4	EVEN	15
43	MEDIUM POP-UP ROTOR - FC	RAINBIRD 5004+SAM-PRS	per PLAN	38mm	55		0.45	4	EVEN	50x2
44	MEDIUM POP-UP ROTOR - PC	RAINBIRD 5004+SAM-PRS	per PLAN	38mm	55		0.45	4	EVEN	50
45	FIXED SPRAY POP-UP SPRINKLER	RAINBIRD 1812-SAM-PRS	MPR - PER PLAN	38mm	40		1.54	4	EVEN	15
46	MEDIUM POP-UP ROTOR - PC	RAINBIRD 5004+SAM-PRS	per PLAN	38mm	55		0.45	4	EVEN	50
47	RAINBIRD RWS - TREE BUBBLER	RAINBIRD RWS-B-C-1402-SOCKED	0.5 GPM	25mm	50			4	EVEN	30
-					55		0.45	-	· <b>_</b> · ·	50

NOTE(S): 1. SCHEDULE TO BE USED FOR 1 YEAR GROW IN PERIOD ONLY; 2. OPERATE (4) FOUR ZONES SIMULTANEOUSLY TO ACHIEVE AN (7) SEVEN HOUR WATER WINDOW.

## IRRIGATION INSTALLATION NOTES

- 1. ALL IRRIGATION PRODUCTS, MATERIALS AND INSTALLATIONS ARE TO FOLLOW THE WRITTEN SPECIFICATIONS INCLUDED WITH THIS DESIGN PACKAGE - FROM THE CITY OF COQUITLAM - PARK DEVELOPMENT SPECIFICATIONS - SECTION 32 84 23 - TYP.
- 2. THE IRRIGATION SYSTEM DESIGN IS BASED ON A MAXIMUM OF (100) U.S.G.P.M. & (80) PSI AVAILABLE AT THE POINT OF CONNECTION. THE CONTRACTOR IS TO VERIFY THE SAME AND NOTIFY THE OWNER'S REPRESENTATIVE IN WRITING PRIOR TO START OF WORK.
- 3. THE IRRIGATION SYSTEM DESIGN BASED UPON A MIN. WEEKLY REQUIREMENT OF 38mm. PEAK ET OCCURRING IN JULY/AUG OF 7.20mm.
- 4. PRECIPITATION RATES FOR TURF AREAS IS BASED UPON AN AVERAGE OF NOZZLE SIZES. ALWAYS USE MATCHED NOZZLES.
- 5. DESIGN DAILY RUN TIMES ARE BASED UPON A (4) FOUR DAY per WEEK WATERING SCHEDULE. BASED ON (1) ONE YEAR GROW IN PERIOD.
- 6. A MAX. WATER WINDOW OF (7) SEVEN Hrs. IS REQ'D FOR THE IRRIGATION SYSTEM AS DESIGNED. PROGRAMMED TO OPERATE (4) FOUR ZONES SIMULTANEOUSLY.
- 7. POP UP SPRINKLER SPACING IS NOT TO EXCEED 50% ACCOUNTING FOR A MINIMUM 4 MPH WIND FACTOR.
- 8. PIPING SHOWN IS FOR SCHEMATIC PURPOSES. NO CROSSING OF ANY PIPING IS ALLOWED. MAXIMUM 2 PIPES per TRENCH SIDE BY SIDE WITH Min. 50mm CLEARANCE.
- 9. INSTALL ALL 24V. WIRING TO A MIN. BURY DEPTH OF 450mm with PIPING COVER or 600mm WITHOUT PIPING COVER. BED ALL WIRE WITH 150mm OF CLEAN, ROCK FREE SAND. ALL COMMON WIRE TO BE TWU-40 #12 GAUGE - CONSISTENTLY WHITE COLOR. ALL CONTROL WIRE TO BE TWU-40 #14 GAUGE - CONSISTENTLY ONE COLOR per RUN - OTHER THAN GREEN, WHITE, RED or BLUE.
- 10. INSTALL ALL ELECTRICAL CONDUIT AS per PLANS. USE CSA NON-METALLIC DB2 PVC CONDUIT GREY IN COLOR. SIZES as SHOWN ON DESIGN.
- 11. INSTALL ALL ELECTRIC CONTROL VALVES (ECV's) WITH MINIMUM 50mm CLEARANCE AROUND THE VALVE AND BETWEEN THE VALVE AND THE VALVE BOX. ENSURE ADEQUATE (Min. 50mm) CLEARANCE BETWEEN THE BOTTOM OF THE EVC AND THE DRAIN ROCK FOR MAINTENANCE PURPOSES.
- 12. ALL WIRE SPLICES ARE TO BE MADE WITH 3M-DBY/R WATER PROOF CONNECTIONS AND TO BE LOCATED AT AN ECV OR IN A VALVE BOX.
- 13. THE WIRE RUNS ARE TO BE INSTALLED WITH A Min. OF 600mm LENGTH OF WIRE COILED UP SLACK AT EVERY CHANGE OF DIRECTION, IN WIRE SPLICE BOXES AND AT ALL CONNECTIONS MADE TO VARIOUS ELECTRICALLY CONTROLLED COMPONENTS.
- 14. ALL SPRINKLERS ARC'S AND RADIUS'S ARE TO BE ADJUSTED TO MINIMIZE OVER SPRAY ONTO ADJACENT HARD SURFACES.
- 15. ALL SPRINKLERS TO BE INSTALLED WITH SCH40 PVC TRIPLE PVC SWING JOINTS AND SCH80 PVC NIPPLES.
- 16. INSTALL ALL MAINLINE PIPE AT A MINIMUM OF 600mm BURY DEPTH TOP OF PIPE. BED PIPE WITH 150mm OF CLEAN, ROCK FREE SAND.
- 17. INSTALL ALL LATERAL PIPING AT A MINIMUM OF 450mm BURY DEPTH TOP OF PIPE. BED PIPE WITH 100mm OF CLEAN, ROCK FREE SAND.
- 18. ASSEMBLY & INSTALLATION OF ALL IRRIGATION COMPONENTS ARE TO FOLLOW THE DETAILS & SPECIFICATIONS LISTED ON PAGES IR-04 & IR-05.
- 19. THE CONTRACTOR IS TO VERIFY THE LOCATION(S) OF ALL ON-SITE UTILITIES. RESTORATION OF DAMAGED UTILITIES SHALL BE MADE AT THE CONTRACTOR'S EXPENSE TO THE SATISFACTION OF THE CONTRACT ADMINISTRATOR and or THE OWNER'S REPRESENTATIVE.
- 20. THE CONTRACTOR IS TO INSTALL SLEEVING FOR IRRIGATION PIPING AND ELECTRICAL WIRING UNDER ALL WALKWAYS, DRIVEWAYS, WALLS (ROCK or BRICK). WATER LINES AND ELECTRICAL WIRES SHALL NOT SHARE THE SAME SLEEVE. MINIMUM SLEEVE TO BE 2x PIPE DIA.
- 21. THE CONTRACTOR MUST BE QUALIFIED TO INSTALL LARGE SCALE, COMMERCIAL IRRIGATION SYSTEMS. THE CONTRACTOR MUST HAVE A MINIMUM OF (5) FIVE YEARS INSTALLATION EXPERIENCE AND BE A MEMBER IN GOOD STANDING WITH THE IRRIGATION INDUSTRY ASSOCIATION of B.C. (I.I.A.B.C.)
- 22. THE CONTRACTOR IS RESPONSIBLE FOR CHECKING AND CONFIRMING ALL DIMENSIONS or ELEVATIONS SHOWN ON DRAWINGS. WHERE ANY DISCREPANCIES OCCUR, THE CONTRACTOR SHALL INFORM THE CONTRACT ADMINISTRATOR IMMEDIATELY.



Fort Langley, BC Vancouver, BC V1M 1A0 V5T 3J7



6	DEP	Issued for FP	May 05, 2024
5	DEP	Issued for Final 100% Design	Jan. 17, 2025
4	DEP	Re-Issue for 100% Draft Review	Dec. 16, 2024
3	DEP	Issued for 100% Draft Review	Dec. 16, 2024
2	DEP	Re-Issued for 95% Review	Nov. 30, 2024
1	DEP	Issued for 95% Review	Nov. 28, 2024
No.	Ву:	Description	Date
	REV	ISIONS TABLE FOR DRA	WINGS
0	VDZ+A	nt reserved. This drawing and design is t and may not be reproduced or used for o permission.	
2	DED	Add ad 7amaa #44 #40	In 47 000E

without permission.							
3	DEP	Added Zones #41-#48	Jan. 17, 2025				
2	DEP	Revised Zone Numbers	Dec. 16, 2024				
1	DEP	Updated Zone Data	Dec. 16, 2024				
No.	No. By: Description Date						

REVISIONS TABLE FOR SHEET

BURKE MOUNTAIN PARK


Project:


Location: 3390 & 3400 DAVID AVENUE. COQUITLAM, BC


	Drawn:	Stamp:
	D.E.P.	THE OWNER
	Checked:	· 董机》系
	ТМ	AVID PETER
	Approved:	Original Sheet Size:
	ТМ	24"x36"
	Scale:	CONTRACTOR SHALL CHECK ALL DIMENSIONS ON THE WORK AND REPORT

ANY DISCREPANCY TO THE CONSULTANT BEFORE PROCEEDING ALL DRAWINGS AND SPECIFICATIONS ARE THE EXCLUSIVE PROPERTY OF THE OWNER AND MUST BE RETURNED AT THE COMPLETION OF THE WORK. ALL REZONING/DP/PPA/FHA/BP DRAWINGS MUST NOT BE PRICED FOR CONSTRUCTION UNLESS LABELED ISSUED

FOR TENDER/CONSTRUCTION.

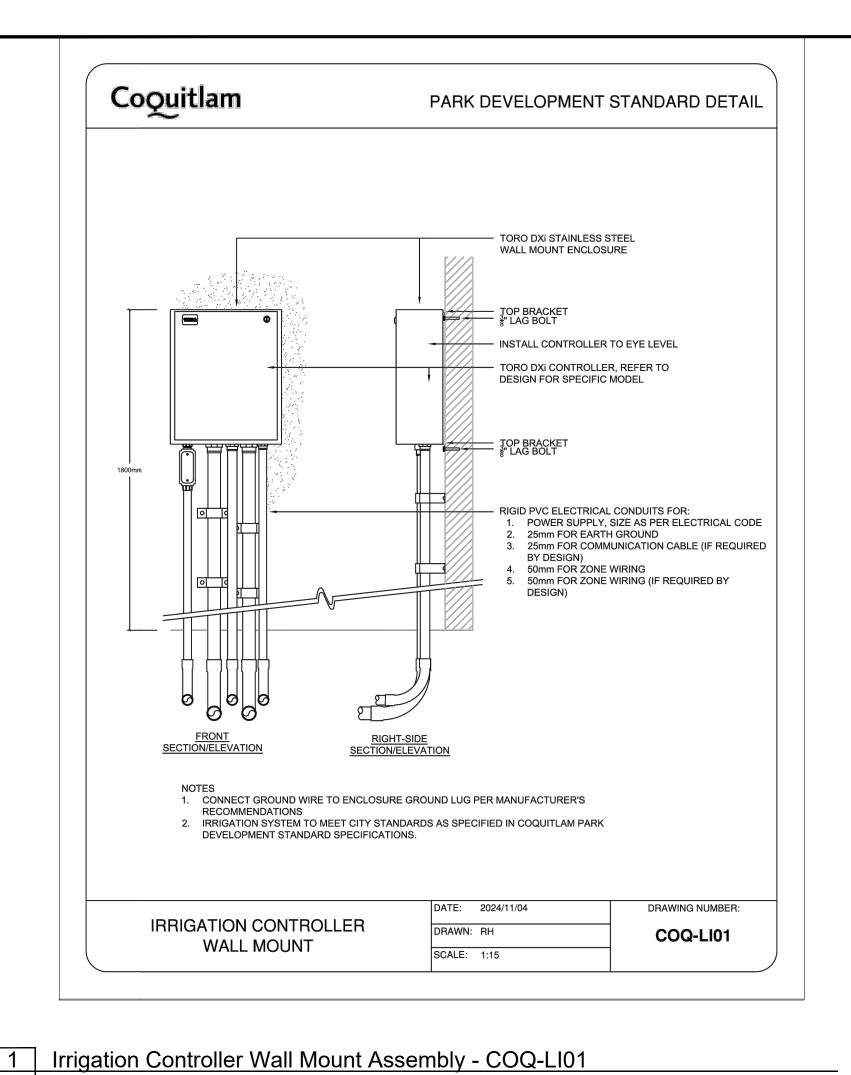


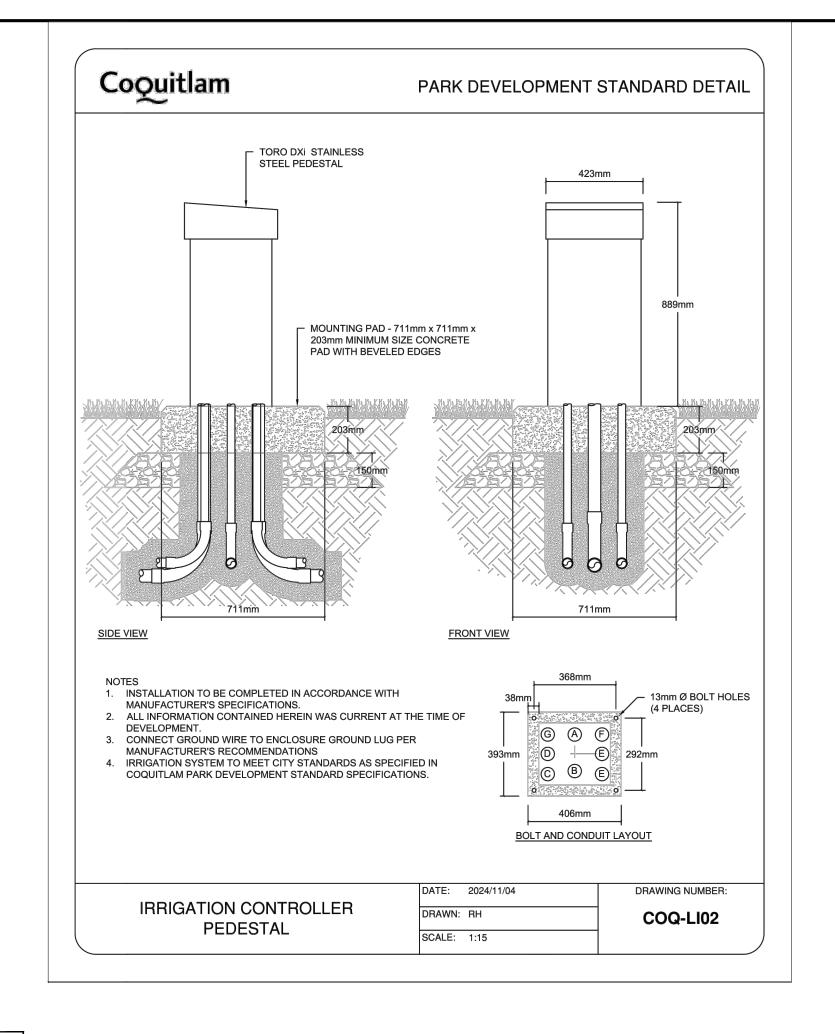


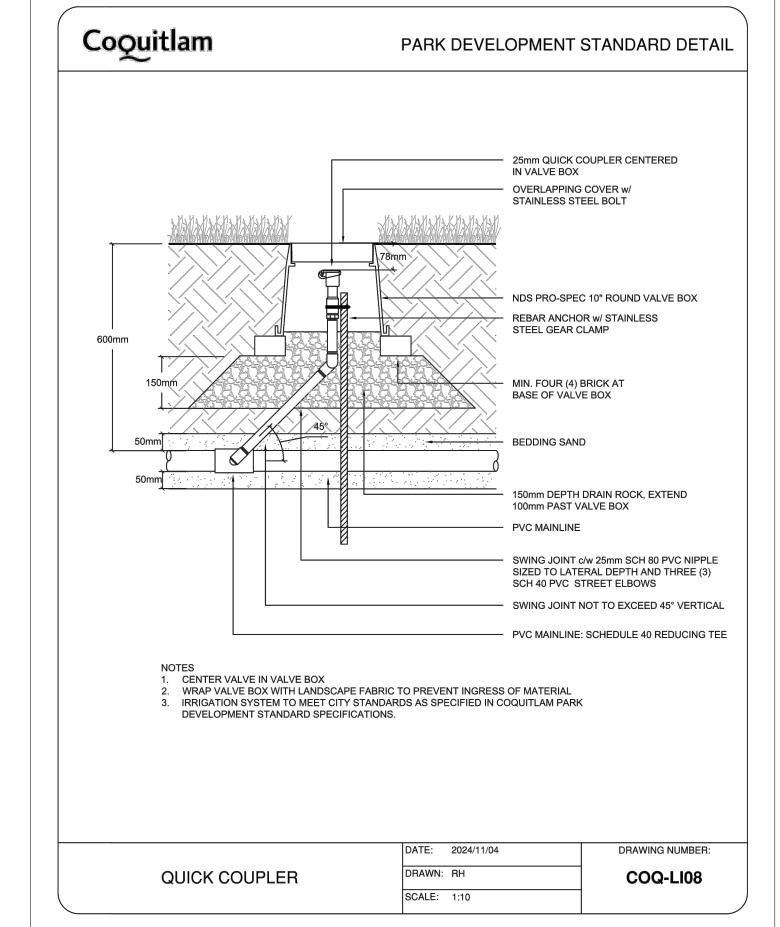







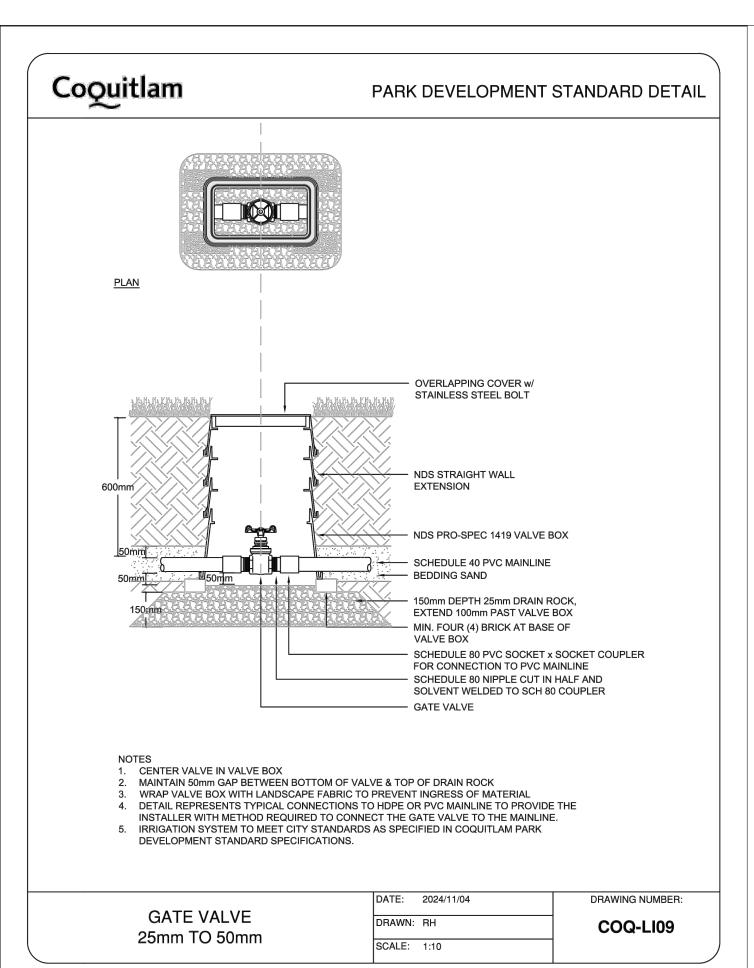

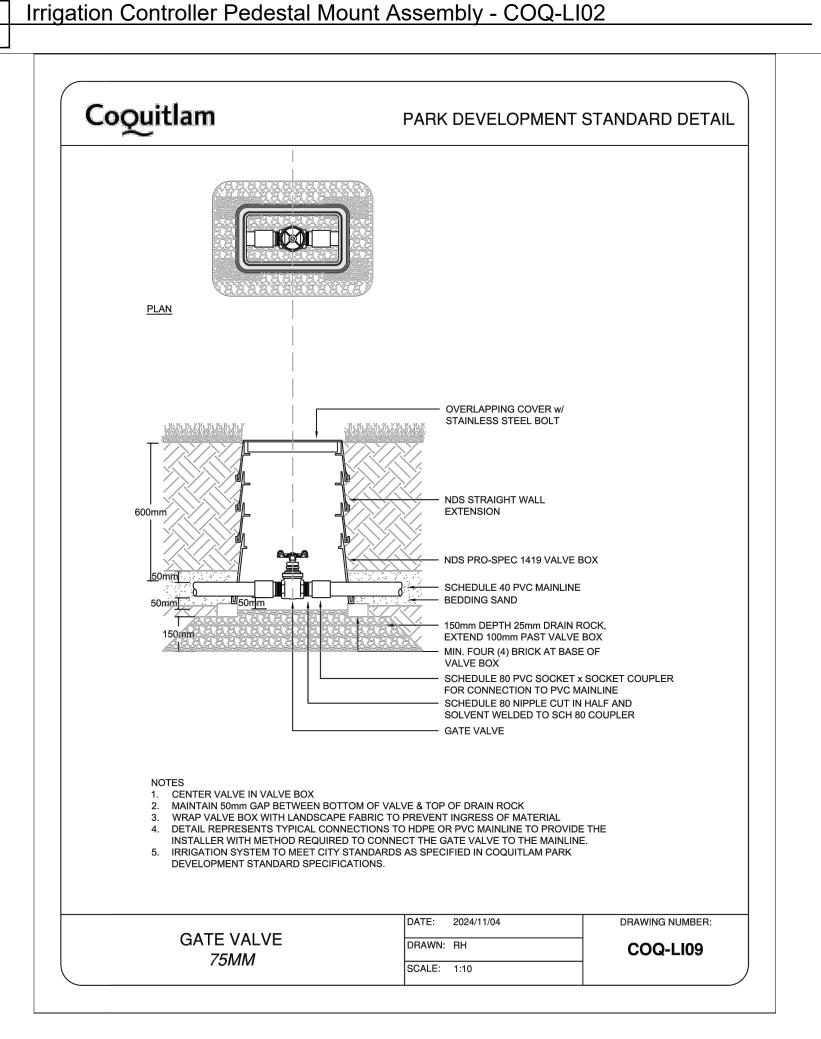

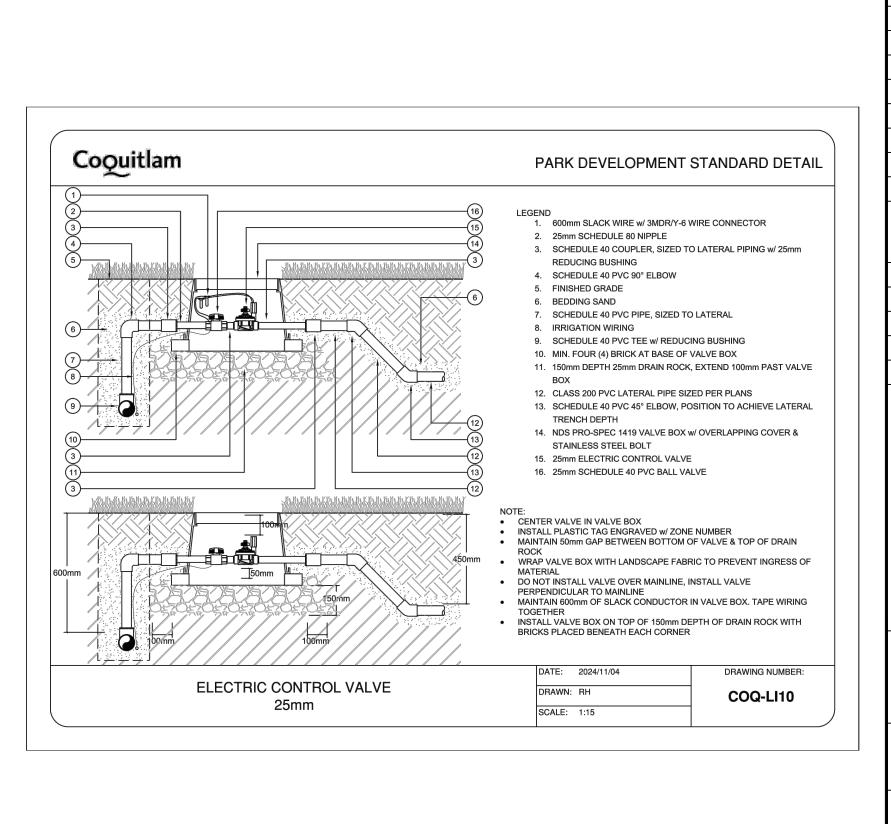

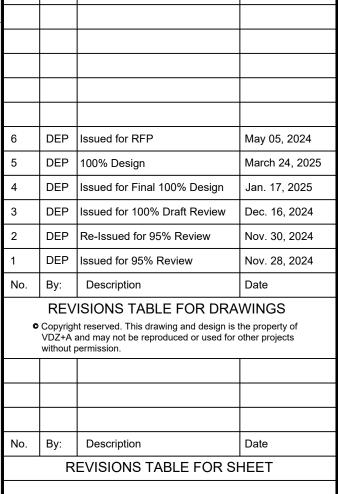

Project:

Location:

Drawn:

D.E.P.

Checked:

Approved:

TM

TM

COQUITLAM, BC

**BURKE MOUNTAIN PARK** 

3390 & 3400 DAVID AVENUE.

0

0

4 50mm Brass Isolation Gate Valve Assembly - COQ-LI09


5 75mm Brass Isolation Gate Valve Assembly - COQ-LI09 IR-06


6 25mm Electric Control Valve Assembly - COQ-LI10


3 25mm Quick Coupler Valve Assembly - COQ-LI08

CONTRACTOR SHALL CHECK ALL DIMENSIONS ON THE WORK AND REPORT ANY DISCREPANCY TO THE CONSULTANT BEFORE PROCEEDING, ALL DRAWINGS AND SPECIFICATIONS ARE THE EXCLUSIVE PROPERTY OF THE OWNER AND MUST BE RETURNED AT THE COMPLETION OF THE WORK. ALL REZONING/DP/PPA/FHA/BP DRAWINGS MUST NOT BE PRICED FOR CONSTRUCTION UNLESS LABELED ISSUED FOR TENDER/CONSTRUCTION.


Original Sheet Size:

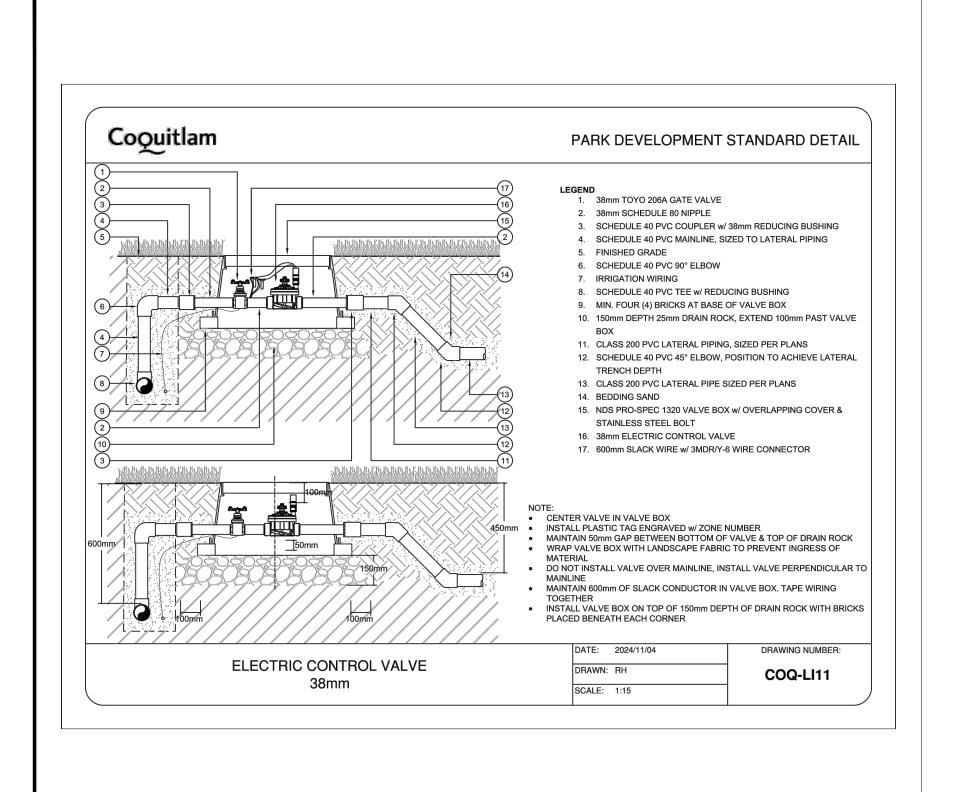

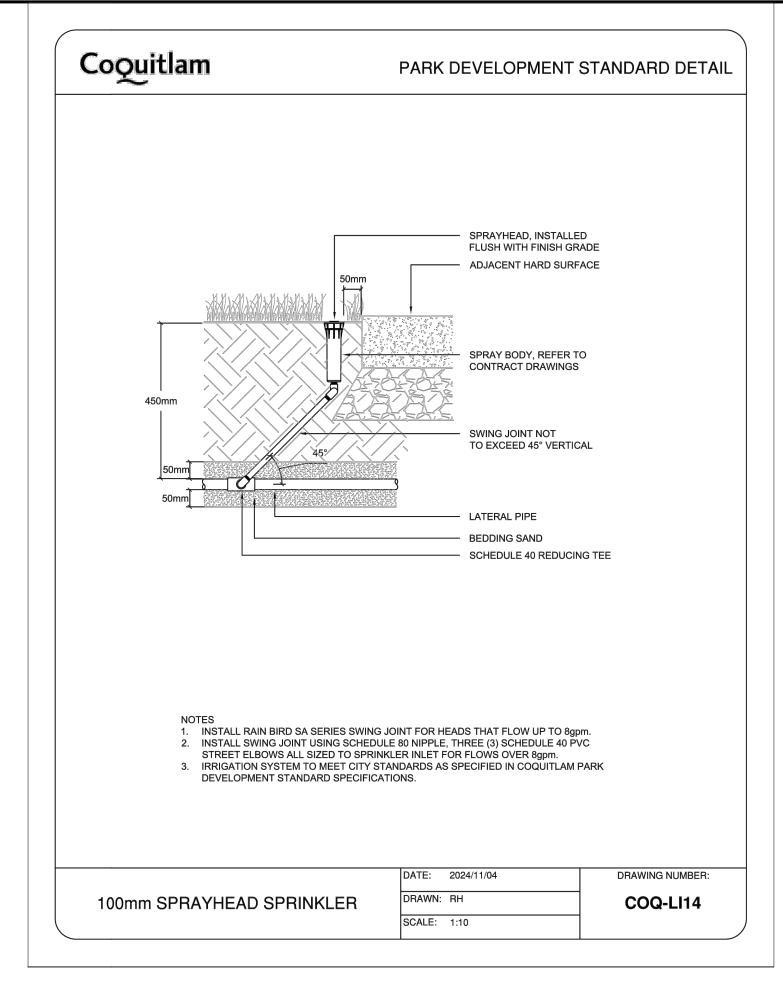

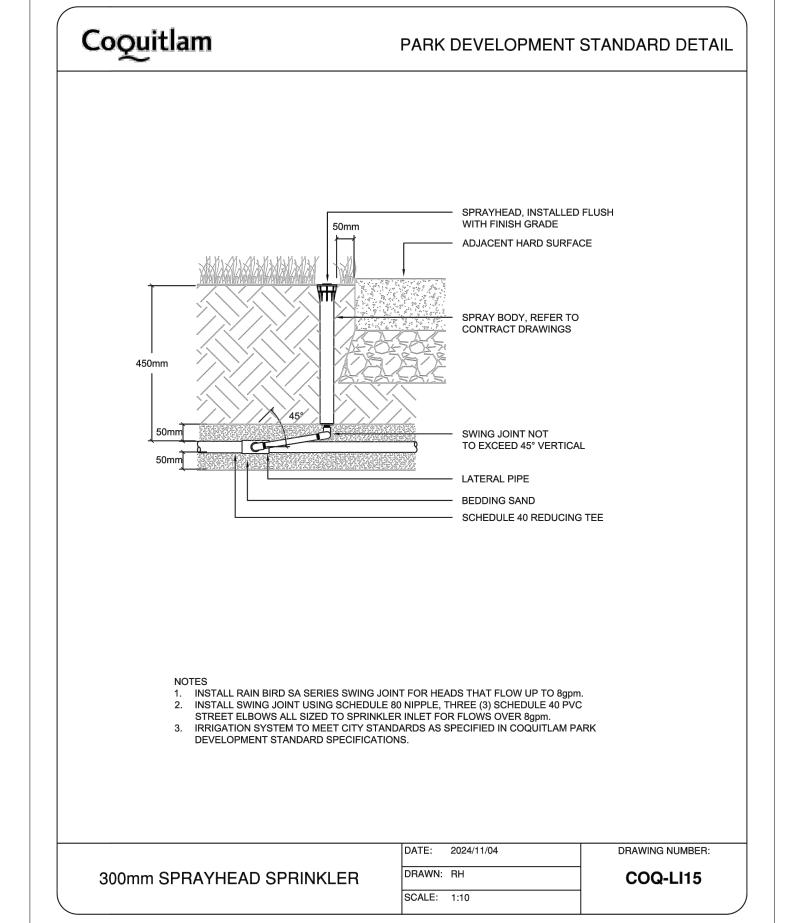

9 300mm Pop-Up Spray Head Assembly - COQ-LI15

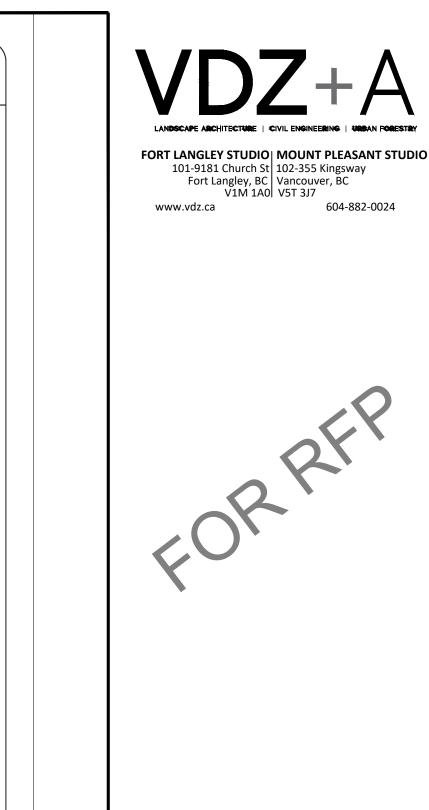



Coouitlam PARK DEVELOPMENT STANDARD DETAIL ROTOR, INSTALLED FLUSH WITH FINISH GRADE ROTOR SPRINKLER ADJACENT HARD SURFACE SPRAY BODY, REFER TO CONTRACT DRAWINGS SWING JOINT NOT TO EXCEED 45° VERTICAL BEDDING SAND SCHEDULE 40 REDUCING TEE 1. INSTALL RAIN BIRD SA SERIES SWING JOINT FOR HEADS THAT FLOW UP TO 8gpm.
2. INSTALL SWING JOINT USING SCHEDULE 80 NIPPLE, THREE (3) SCHEDULE 40 PVC STREET ELBOWS ALL SIZED TO SPRINKLER INLET FOR FLOWS OVER 8gpm. 3. IRRIGATION SYSTEM TO MEET CITY STANDARDS AS SPECIFIED IN COQUITLAM PARK DEVELOPMENT STANDARD SPECIFICATIONS.


DATE: 2024/11/04


SCALE: 1:10

DRAWING NUMBER:

COQ-LI16

7 38mm Electric Control Valve Assembly - COQ-LI11

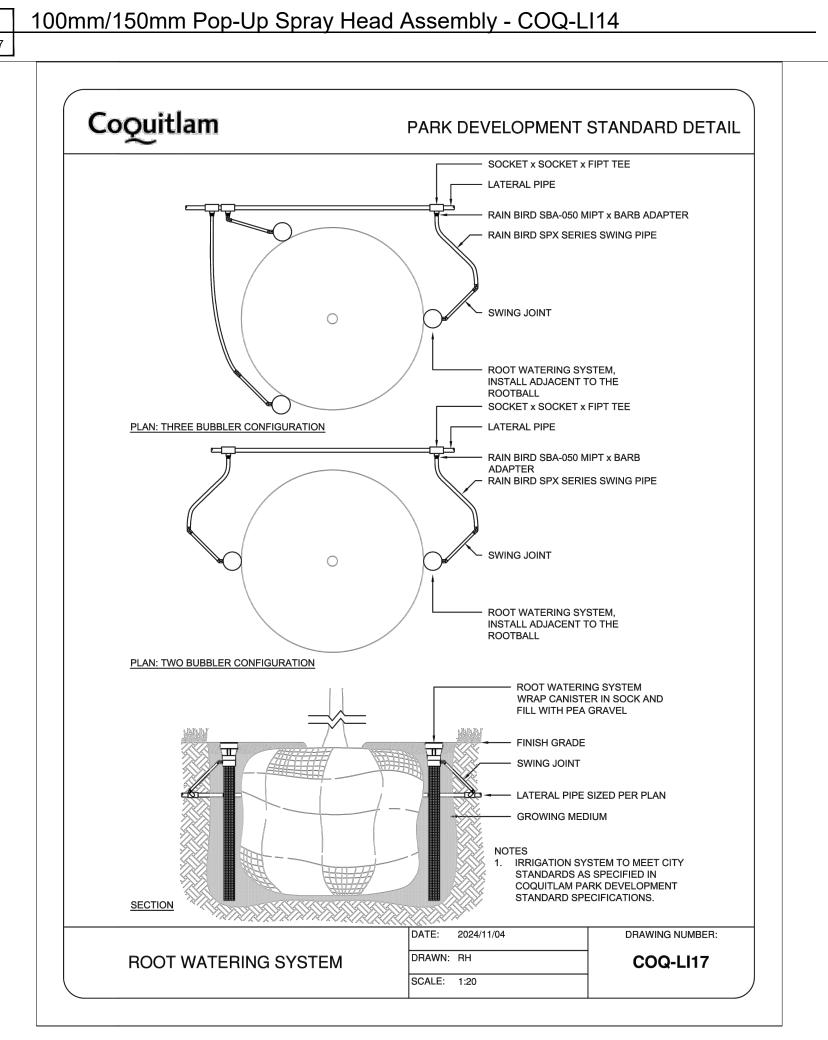

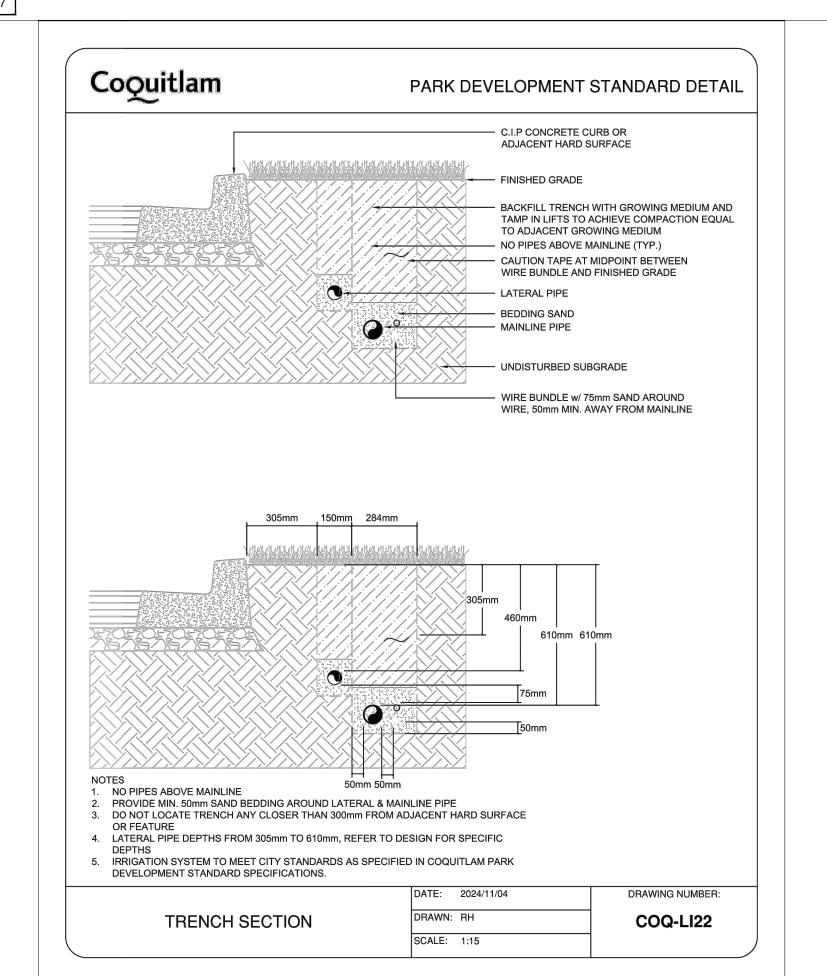

6	DEP	Issued for RFP	May 05, 2024	
5	DEP	100% Design	March 24, 2025	
4	DEP	Issued for Final 100% Design	Jan. 17, 2025	
3	DEP	Issued for 100% Draft Review	Dec. 16, 2024	
2	DEP	Re-Issued for 95% Review	Nov. 30, 2024	
1	DEP	Issued for 95% Review	Nov. 28, 2024	
No.	Ву:	Description	Date	
		ISIONS TABLE FOR DRA	_	
0	VDZ+A	nt reserved. This drawing and design is to and may not be reproduced or used for opermission.		
No.	Ву:	Description	Date	
REVISIONS TABLE FOR SHEET				
Project:				
1 10,000.				
BURKE MOUNTAIN PARK				

Location:

Drawn:

D.E.P.

Checked:

Approved:

TM

TM

Scale:

COQUITLAM, BC

Original Sheet Size:

CONTRACTOR SHALL CHECK ALL DIMENSIONS ON THE WORK AND REPORT

ANY DISCREPANCY TO THE CONSULTANT BEFORE PROCEEDING, ALL DRAWINGS AND SPECIFICATIONS ARE THE EXCLUSIVE PROPERTY OF THE OWNER AND MUST BE RETURNED AT THE COMPLETION OF THE

WORK. ALL REZONING/DP/PPA/FHA/BP DRAWINGS MUST NOT BE PRICED FOR CONSTRUCTION UNLESS LABELED ISSUED

FOR TENDER/CONSTRUCTION.

3 3390 & 3400 DAVID AVENUE.

0

10 19mm Inlet 125mm Pop-Up Rotor Head Assembly - COQ-LI16

**ROTOR** 

11 Double Root Watering System - COQ-LI17 IR-07

12 Typical Trench Section - COQ-LI22

6 COPPER GROUNDING PLATE - 100mm x 900mm LONG WITH GROUND CLAMP INSTALL THE GROUNDING PLATE IN ACCORDANCE WITH MANUFACTURERS SPECIFICATIONS

REFER TO MANUFACTURER'S WEBSITE AT: www.toro.com

13 Toro Two-Wire Surge Protection & Grounding Detail

TORO 2-WIRE SURGE PROTECTION & GROUNDING INSTALLATION NOTES:

- 2. THE COMMUNICATION CABLE MUST BE GROUNDED NO FURTHER THAN 300m FROM
- 3. NO DECODER CAN BE MORE THAN 150m FROM A SURGE PROTECTION DEVICE and/or GROUNDING PLATE.
- 4. THE SURGE PROTECTION DEVICE (TORO: SB-BLA) MUST BE CONNECTED TO A COPPER GROUNDING PLATE THAT IS AT LEAST 100mm X 900mm X 12mm IN SIZE.

  5. THE MINIMUM DISTANCE BETWEEN THE SURGE PROTECTION DEVICE AND THE GROUNDING PLATE
- SHOULD BE 1 METER.
- 6. TORO RECOMMENDS A SPLIT BOLT CONNECTION TO BE USED TO CONNECT THE SURGE DEVICE TO THE GROUND WIRE WITH A DBY/R WATERPROOF ELECTRICAL CONNECTOR.

SCALE: N.T.S.


(1) CARSON INDUSTRIES/NDS PRO SERIES PLASTIC VALVE BOX - 910-12 ROUND (with GREY LID - MARKED ELECTRICAL) (2) DBY/R 2-WIRE WATER PROOF ELEC. CONNECTOR (QTY 2) - IN-LINE PATH WIRE SPLICE (3) PAIGE ELECTRIC - TORO 2-WIRE CABLE - RED JACKETED TWISTED PAIR (BLACK and WHITE CONDUCTOR) - IN 4) PAIGE ELECTRIC - TORO 2-WIRE CABLE - RED JACKETED TWISTED PAIR (BLACK and WHITE CONDUCTOR) - OUT SECTION/ELEVATION

\*NOTE: SUPPLY & INSTALL ALL VALVE BOXES per City of Coquitlam SPECIFICATIONS. - TYP.\*

14 Toro Two-Wire - Wire Splice Detail

SEE PLANS, LEGEND AND SPECIFICATIONS FOR ADDITIONAL INSTALLATION

SCALE: N.T.S.

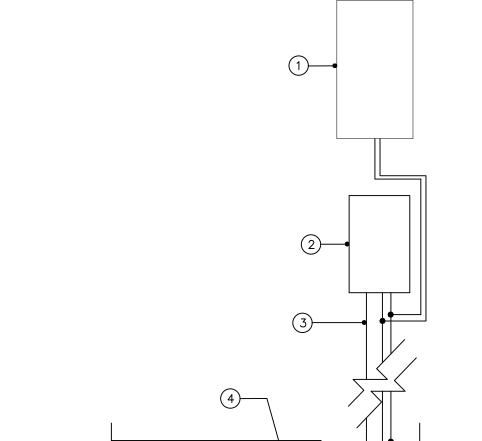

- (1) TORO AC 2-WIRE FIELD DECODER: SB-DAC-1 (SINGLE STATION)
- (2) TORO AC 2-WIRE LINE SURGE PROTECTOR MODEL: SB-BLA
- (3) SURGE PROTECTION 2-WIRE PATH TO GROUND (GREEN WIRE)
- (4) PATH TO EARTH GROUND AS PER MANUFACTURERS SPECIFICATIONS
- 5) PAIGE ELEC. 2-WIRE CABLE RED JACKETED SINGLE TWISTED PAIR (BLACK and WHITE CONDUCTORS) WIRE: PAIGE ELECTRIC P7350D, 14AWG/2C GAUGE, PE UL.
- (6) DBY/R WIRE CONNECTOR (QTY 2) SURGE PROTECTION DEVICE TO 2-WIRE PATH
  - 2-WIRE SURGE PROTECTION DEVICE INSTALLATION NOTES:
  - 1. ALL SURGE PROTECTION CABLE SPLICES MUST ALWAYS FOLLOW THE COLOR CODE. (BLACK TO BLACK WIRES and WHITE TO WHITE WIRES and GREEN FOR GROUND) 2. MAXIMUM DISTANCE BETWEEN SURGE PROTECTION DEVICES IS LIMITED TO 300m. (NO ECV IS TO BE FARTHER THAN 150m FROM A SURGE PROTECTOR DEVICE).
  - 3. ALL SURGE PROTECTION DEVICES MUST BE GROUNDED IN ACCORDANCE WITH MANUFACTURERS SPECIFICATIONS. 4. SECURE THE SURGE PROTECTION DEVICE WITH SCREWS TO THE SIDE WALL OF THE

VALVE BOX. COIL UP SLACK WIRE AND PLACE IN VALVE BOX.

SCALE: N.T.S.

SECTION/ELEVATION


\*NOTE: SUPPLY & INSTALL ALL VALVE BOXES per City of Coquitlam SPECIFICATIONS. — TYP.\*

- 1) TORO TWO-WIRE PATH RED JACKETED/TWISTED PAIR (BLK and WHT WIRE) WIRE: PAIGE ELECTRIC P7350D, 14AWG/2c GAUGE, PE UL.
- (2) DBR/Y WIRE CONNECTOR DECODER TO ECV
- (3) RED/RED/BLACK WIRES TO VALVE SOLENOID (COLORS MUST MATCH)
- (4) TORO 1 OR 2 STATION DECODER MODEL # SBDAC-1 / SBDAC-2
- (5) DBR/Y WIRE CONNECTOR (QTY 2) PATH WIRE TO SURGE ARRESTOR
- (6) INSTALL DECODERS AND OR SURGE ARRESTORS WITH A MINIMUM OF 1m SLACK OF WIRE PER UNIT
- 7 TO EARTH GROUND INSTALLED PER MANUFACTURERS RECOMMENDED SPECIFICATIONS FOR TWO—WIRE DECODER GROUNDING
- (8) TORO SURGE ARRESTOR MODEL # SB-BLA
- (9) CARSON/NDS PLASTIC VALVE BOX 1320B-12
  - TORO AC DECODER INSTALLATION NOTES:
- ALL COMMUNICATION CABLE SPLICES MUST ALWAYS FOLLOW THE COLOR CODE.
   (BLACK TO BLACK WRES and WHITE TO WHITE WRES)
   ALL ELECTRIC CONTROL VALVES MUST BE EQUIPPED WITH A 24V AC
   COLEMNIA (TORO MODEL)
- SOLENOID. (TORO MODEL R811)
  3. ALL DECODER TO SOLENOID WIRES MUST BE CONNECTED WITH THE CORRECT WRE ORDER TO PROPERLY OPERATE THE SOLENOID.

  4. THE DECODER'S SOLID OUTPUT WIRE IS CONNECTED TO THE RED SOLENOID
- WIRE. THE DECODER'S OUTPUT WIRE WITH BLACK STRIPE IS CONNECTED TO THE BLACK SOLENOID WIRE. 5. IF REMAINING STATION OUTPUT WIRES ARE NOT BEING USED, INSTALL A WIRE
- NUT ON EACH WIRE AND PLACE THEM IN A DBR/Y WATERPROOF SPLICE KIT. 6. SECURE THE DECODER AND/OR SURGE ARRESTÓR UNIT WITH SCREWS TO THE SIDE WALL OF THE VALVE BOX. COIL UP SLACK WIRE AND PLACE IN VALVE BOX.

Toro Two-Wire - ECV to Decoder Wiring Detail with Surge Protection

SCALE: N.T.S.

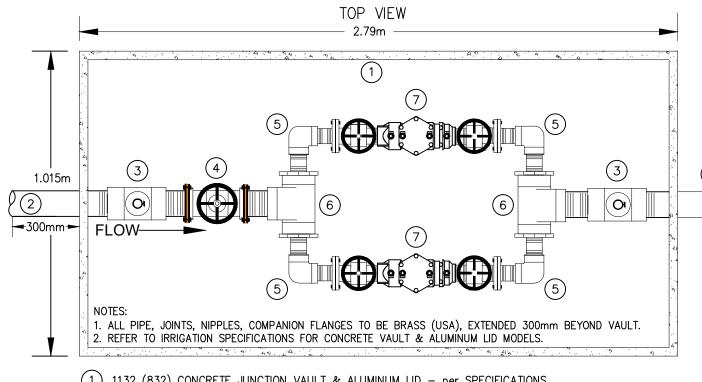

Toro Two-Wire - Surge Protection Detail


- (1) 1132 (832) CONCRETE JUNCTION VAULT & ALUMINUM LID per SPECIFICATIONS
- (1A) 1102 CONCRETE VAULT & ALUMINUM LID per SPECIFICATIONS
- (2) 75mm WATER SERVICE FROM STREET BY CITY OF COQUITLAM FORCES
- 75mm TEE with 25mm BRASS BALL VALVE c/w 25mm x 100mm LONG NIPPLE (INSTALL DOWN USED FOR DRAIN)
- (4) 75mm ISOLATION GATE VALVE F x F CLOW F6102 GEAR OPERATED
- 5 50mm BRASS (USA) 90 DEGREE ELBOW w/ 50mm x 100mm LONG NIPPLE
- (6) 75mm BRASS (USA) TEE c/w 75mm x 50mm REDUCING BUSHING TO 50mm x 100mm LONG NIPPLE (x2)

75mm Point of Connection Assembly

- TOP VIEW 1.89m 9 3. SUPPLY AND INSTALL A MIN. OF FOUR (4) ADJ. STEEL PIPE STANDS FOR SUPPORT/VAULT 4. IRRIGATION VAULT TO INCLUDE A PRE-FAB CONCRETE BASE FROM THE SAME SUPPLIER.  $^\circ$ ]5. ALL THREADED CONNECTIONS TO BE MADE WITH TEFLON TAPE & THREAD SEALANT.
  - 7) 50mm DOUBLE CHECK VALVE ASSEMBLY MODEL WATTS 007QT
  - (8) 75mm BRASS (USA) PIPE CUT & THREADED TO FIT

<u>PLAN VIEW</u>

- (9) 75mm BRASS (USA) COUPLING & 75mm x 150mm LONG NIPPLE
- (10) 75mm BRASS (USA) COMPANION FLANGE c/w RUBBER GASKET & BOLT KIT 75mm NETAFIM HYDROMETER - MODEL: LHM3FG0205-MEL. SUPPLY & INSTALL A SINGLE STATION TWO-WIRE DECODER FOR
- THE MASTER VALVE. SUPPLY & INSTALL A SINGLE STATION TWO-WIRE SENSOR DECODER FOR THE FLOW SENSOR. 12) MASTER VALVE & FLOW SENSOR WIRES ARE TO BE CONNECTED TO THE TWO-WIRE PATHWAY per PLANS.
- 75mm BRASS (USA) TEE with 38mm BRASS BALL VALVE c/w 38mm x 100mm LONG NIPPLE (INSTALL UP MAIN BLOW OUT)
- (14) TO IRRIGATION SYSTEM TRANSITION TO CSA SCH40 PVC MAINLINE SIZE per PLANS
- SEE PLANS, LEGEND AND SPECIFICATIONS FOR ADDITIONAL INSTALLATION NOTES.

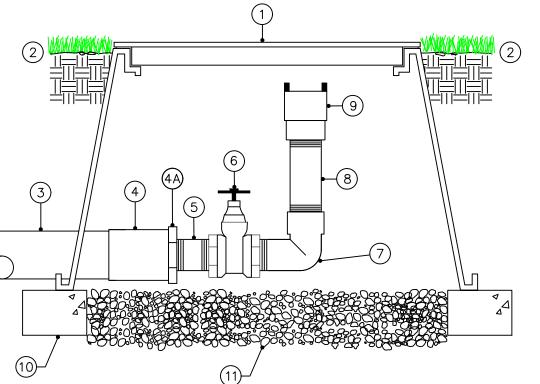

\*NOTE: SUPPLY & INSTALL ALL VALVE BOXES per City of Coquitlam SPECIFICATIONS. — TYP.\*

SECTION/ELEVATION

- 2 FINISHED GRADE (3) 75mm CSA SCH40 PVC MAINLINE PIPE (4) 75mm SCH80 PVC COUPLING SLIP
  - (4A) 75mm x 50mm SCH80 RED. BUSHING SxT

(1) CARSON/NDS/RAINBIRD-VB: 1419B-12 REC.

- 50mm x 100mm LONG BRASS NIPPLE
- (6) 50mm RED & WHITE 206A GATE VALVE 50mm SCH80 PVC ST. 90 ELL
- 50mm x 200mm LONG SCH80 PVC NIPPLE
- 9) 50mm SS FEMALE x 50mm FIPT. CAM LOCK
- CONTINUOUS BRICK SUPPORTS (x4 BRICKS per BOX)
- (12mm MINUS) PEA GRAVEL SUMP (100mm DEPTH)

50mm Mainline Drain Valve Assembly

SEE PLANS, LEGEND AND SPECIFICATIONS FOR ADDITIONAL INSTALLATION NOTES.

CONTRACTOR SHALL CHECK ALL Scale: DIMENSIONS ON THE WORK AND REPORT ANY DISCREPANCY TO THE CONSULTANT BEFORE PROCEEDING, ALL DRAWINGS AND SPECIFICATIONS ARE THE EXCLUSIVE PROPERTY OF THE OWNER AND MUST BE RETURNED AT THE COMPLETION OF THE WORK. ALL REZONING/DP/PPA/FHA/BP DRAWINGS MUST NOT BE PRICED FOR CONSTRUCTION UNLESS LABELED ISSUED FOR TENDER/CONSTRUCTION.

Original Sheet Size:

FORT LANGLEY STUDIO | MOUNT PLEASANT STUDIO 101-9181 Church St | 102-355 Kingsway Fort Langley, BC | Vancouver, BC V1M 1A0 V5T 3J7

DnA

**Irrigation Design** 

and Consulting  $\blacksquare$ 

DEP Issued for Final 100% Design | Jan. 17, 2025

Issued for 100% Draft Review

REVISIONS TABLE FOR DRAWINGS

• Copyright reserved. This drawing and design is the property of

VDZ+A and may not be reproduced or used for other projects

REVISIONS TABLE FOR SHEET

**BURKE MOUNTAIN PARK** 

3390 & 3400 DAVID AVENUE.

DEP Re-Issued for 95% Review

Description

Issued for 95% Review

DEP Updated Notes to all Details

Description

Project:

Location:

Checked:

Approved:

COQUITLAM, BC

May 05, 2024

March 24, 2025

Dec. 16, 2024

Nov. 30, 2024

Nov. 28, 2024

250 - 212 - 0352 dnadesigns07@gmail.co

DEP Issued for RFP

DEP 100% Design

www.vdz.ca

604-882-0024