DRAWING INDEX						
DRAWING INDEX						
SHEET	DRAWING NAME	REVISION	DRAWING TITLE			
GENERAL						
1	2205-01-G-100	0	COVER PAGE & DRAWING INDEX			
CIVIL						
2	2205-01-C-101	0	GRADING PLAN			
3	2205-01-C-102	0	CIVIL DETAILS			
STRUCTURAL						
4	2205-01-S-101	0	GENERAL NOTES			
5	2205-01-S-102	0	GENERAL ARRANGEMENT			
6	2205-01-S-103	0	SOUTH ABUTMENT - REPAIR DETAILS			
7	2205-01-S-104	0	NORTH ABUTMENT - REPAIR DETAILS			
8	2205-01-S-105	0	EAST ABUTMENT - REPAIR DETAILS			
9	2205-01-S-106	0	EXPANSIONS JOINT DETAILS			
10	2205-01-S-107	0	PARAPET & NOISE BARRIER DETAILS			
11	2205-01-S-108	0	MISCELLANEOUS REPAIR DETAILS			

CITY OF COQUITLAM BR230 MARINER WAY OVERPASS STRUCTURAL REHABILITATION





CITY OF COQUITLAM

BR230 MARINER WAY OVERPASS STRUCTURAL REHABILITATION

2025-2205-01

DRAWING	REVISION	SHEET
2205-01-G-100	0	1







PERMIT TO PRACTICE ASSOCIATED ENGINEERING (B.C.) LTD. PERMIT NUMBER: 1000163 Engineers & Geoscientists BC


					7	CITY OF COQUI
_						BR230 MARINEF STRUCTURAL R
	20250528	R. BOWLEY	J. PADAM	ISSUED FOR TENDER		2025-2205-01
REV	DATE	DESIGN	DRAWN	DESCRIPTION		SCALE: AS SHOWN

230 MARINER WAY OVERPASS UCTURAL REHABILITATION

CIVIL

GRADING PLAN	
DRAWING	REVISION

2205-01-C-101

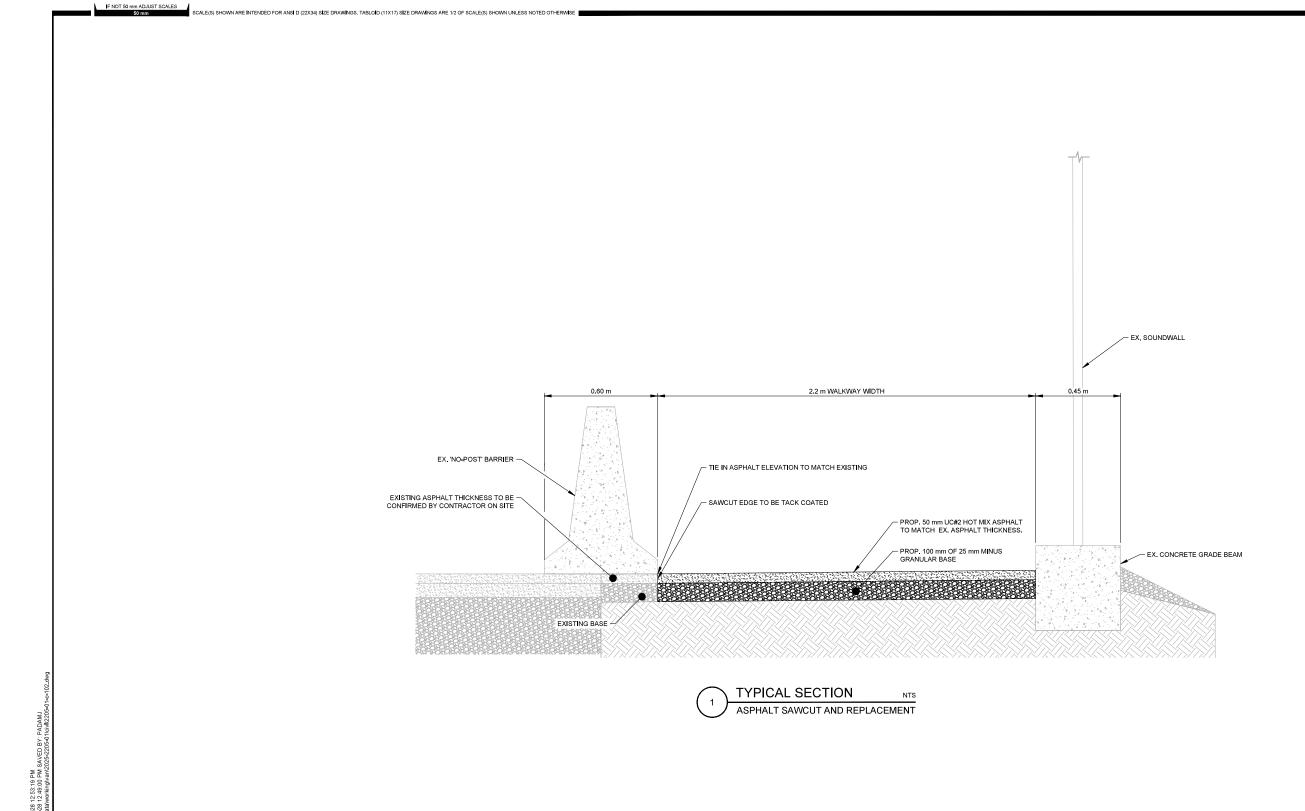





PERMIT TO PRACTICE ASSOCIATED ENGINEERING (B.C.) LTD. PERMIT NUMBER: 1000163 Engineers & Geoscientists BC

REV DATE DESIGN DRAWN DESCRIPTION SCALE: AS SHOWN

CITY OF COQUITLAM

BR230 MARINER WAY OVERPASS STRUCTURAL REHABILITATION

2025-2205-01

CIVIL CIVIL DETAILS

DRAWING REVISION 3 2205-01-C-102

SHEET

2025-05-28 10:38:05 AM 2025-05-28 10:35:23 AM

GENERAL:

- SPECIFICATIONS PROVIDED ARE MINIMUM REQUIREMENTS, U.N.O.
- THE LATEST EDITION OF STANDARDS AND CODES REFERENCED IN THESE NOTES SHALL
- ALL DIMENSIONS ARE IN MILLIMETRES, U.N.O.
- THESE DRAWINGS SHALL BE READ IN CONJUNCTION WITH THE CONTRACT DOCUMENTS AND
- DESIGN IN ACCORDANCE WITH THE CSA-S6:19 CANADIAN HIGHWAY BRIDGE DESIGN CODE
- ANY CHANGES TO THE DESIGN DURING FABRICATION AND CONSTRUCTION SHALL REQUIRE PRIOR WRITTEN APPROVAL FROM THE CONTRACT ADMINISTRATOR
- WHERE "EQUIVALENT" PRODUCTS ARE PROPOSED TO THOSE SPECIFIED, THEIR EQUIVALENCE SHALL BE DETERMINED SOLELY BY THE CONTRACT ADMINISTRATOR.
- CONTRACTOR SHALL PLAN AND IMPLEMENT TRAFFIC CONTROL OF THE CITY OF COQUITLAM AND CITY OF BURNABY TO PROTECT WORKERS AND PUBLIC IN ACCORDANCE WITH THE CONTRACT DOCUMENTS AND SPECIFICATIONS.
- THE CONTRACTOR IS RESPONSIBLE FOR RESTORATION OF THE SITE TO PRE-CONSTRUCTION CONDITION FOLLOWING COMPLETION OF THE WORKS. THIS INCLUDES, BUT IS NOT LIMITED TO, REPAIRING DAMAGE TO THE STRUCTURE AND/OR SURROUNDING STRUCTURES CAUSED BY THE CONTRACTOR AND RESTORATION OF ANY AREAS DISTURBED DURING THE COMPLETION

DESIGN:

- NEW COMPONENTS DESIGNED IN ACCORDANCE WITH S6:19.
- TEMPERATURE IN COQUITLAM (ANTICIPATED VALUES FROM S6:25)
- 2.1. MAX DAILY MEAN TEMPERATURE CURRENT: +28 °C
 2.2. MAX DAILY MEAN TEMPERATURE W/ CLIMATE CHANGE: +33 °C
- MIN DAILY MEAN TEMPERATURE CURRENT: -15 °C
- MIN DAILY MEAN TEMPERATURE W/ CLIMATE CHANGE: -9 °C
- 2.5. DESIGN DAILY MEAN TEMPERATURE RANGE: 9 °C TO +33 °C

EXISTING STRUCTURE:

- ELEVATIONS AND DIMENSIONS SHOWN FOR THE EXISTING CONDITIONS AND COMPONENTS HAVE BEEN TAKEN FROM THE ORIGINAL BRIDGE DESIGN DRAWINGS WITHOUT FIELD VERIFICATION. THE CONTRACTOR SHALL BE WHOLLY RESPONSIBLE FOR DETERMINING RELEVANT EXISTING ELEVATIONS AND DIMENSIONS IN THE FIELD PRIOR TO ORDERING AFFECTED MATERIALS, PRODUCING SHOP OR TEMPORARY WORK DRAWINGS, OR FABRICATING AFFECTED COMPONENTS, CONTRACTOR SHALL NOTIFY THE CONTRACT ADMINISTRATOR OF ANY DISCREPANCIES AND ADJUST AFFECTED COMPONENTS TO SUIT
- THE CONTRACTOR SHALL DOCUMENT THE EXISTING CONDITION OF THE BRIDGE USING PHOTOGRAPHS PRIOR TO START OF CONSTRUCTION AND PROVIDE COPIES OF DOCUMENTATION TO THE CITY AND THE CONTRACT ADMINISTRATOR.
- EXISTING UTILITIES SHALL NOT BE DAMAGED OR INTERRUPTED DURING CONSTRUCTION.

CONSTRUCTION AND TEMPORARY WORK:

- THE CONTRACTOR SHALL BE RESPONSIBLE FOR THE DESIGN, CONSTRUCTION AND REMOVAL OF ALL TEMPORARY WORKS, TEMPORARY WORKS TO BE DESIGNED AND SEALED BY A PROFESSIONAL ENGINEER REGISTERED WITH EGBC AND IN ACCORDANCE WITH WORKSAFE BC REQUIREMENTS.
- CONTRACTOR TO PROVIDE TEMPORARY SCREENS AND HOARDING TO PROTECT ADJACENT PROPERTY AND PEDESTRIANS FROM CONSTRUCTION DEBRIS.
- THE CONTRACTOR SHALL PROTECT STRUCTURE FROM DAMAGE DURING CONSTRUCTION.
- CONSTRUCTION STAGES AND LOADS ARE THE RESPONSIBILITY OF THE CONTRACTOR.
- THE CONTRACTOR SHALL BE RESPONSIBLE FOR PERMITTING REQUIRED FOR CONSTRUCTION.

CONCRETE:

- CONCRETE TO HAVE A MINIMUM COMPRESSIVE STRENGTH OF 45 MPa AT 28 DAYS.
- CONCRETE: CLASS C-1 CONCRETE TO CSA A23.1-19.
- THE CONTRACTOR SHALL BE RESPONSIBLE FOR THE DESIGN AND QUALITY CONTROL OF ALL CONCRETE USED ON THIS PROJECT.
- ALL CONCRETE WORK, INCLUDING CONCRETE MATERIALS, TESTS AND PROCEDURES, SHALL ALL DUTINES IE WOME, INCLUDING CONCRETE MATERIALS, TESTS AND PROCEDURE CONFORM TO THE REQUIREMENTS OF CSA A23.1-19/A23.2-19 AND THE CONTRACT SPECIFICATIONS.
- CONTRACTOR SHALL SUPPLY ALL REPAIR PROCEDURES, MATERIAL DATA SHEETS AND MIX DESIGNS TO THE CONTRACT ADMINISTRATOR FOR ACCEPTANCE AT LEAST 2 WEEKS BEFORE COMMENCEMENT OF WORKS.

- 6. ALL SURFACE FINISHES TO MATCH EXISTING ADJACENT CONCRETE SURFACES
- ALL REPAIRS TO CONCRETE SURFACES, CRACKS, DELAMINATION AND SPALLED AREAS SHALL BE REPAIRED WITH A SUITABLE PATCHING MATERIAL SELECTED FROM THE MINISTRY OF TRANSPORTATION AND TRANSIT'S RECOGNIZED PRODUCTS LIST, OR APPROVED EQUAL, TO THE ACCEPTANCE OF THE CONTRACT ADMINISTRATOR.
- 8. EXPOSED EDGES TO BE CHAMFERED 20 mm, U.N.O.
- ALL EXISTING CONCRETE SURFACES TO RECEIVE NEW CONCRETE OR GROUT SHALL BE POWER WASHED TO REMOVE ALL LOOSE MATERIAL, LAITANCE AND CORROSION PRODUCTS FROM THE
- 10. CURING OF CONCRETE SHALL BE COMPLETED IN ACCORDANCE WITH PROJECT SPECIFICATIONS.
- ALL EXISTING CONCRETE SURFACES TO RECEIVE NEW CONCRETE SHALL BE PREPARED IN ACCORDANCE WITH CSA A23.1-19. ROUGHEN SURFACE TO MINIMUM 6mm AMPLITUDE.
- 12. SATURATE THE CONCRETE REPAIR SURFACE WITH CLEAN WATER. ENSURE THE SUBSTRATE IS SATURATED, SURFACE DRY (SSD) WITH NO STANDING WATER DURING APPLICATION WHEN

REINFORCING STEEL

- REINFORCING STEEL BARS SHALL BE SUPPLIED AND INSTALLED TO CSA A23.1 AND THE REINFORCING STEEL MANUAL OF STANDARD PRACTICE BY THE REINFORCING STEEL INSTITUTE OF
- ALL REINFORCING STEEL TO CONFORM TO CSA G30.18 GRADE 400W, U.N.O.
- COVER TO REINFORCEMENT TO MATCH EXISTING, U.N.O.
- WELDING OF REINFORCEMENT BARS IS NOT PERMITTED
- SPLICE REINFORCING STEEL WHERE REQUIRED AS FOLLOWS:

BAR SIZE	SPLICE LENGTH
10M	420
15M	630
20M	840

- CARBINE TIPPED BITS AND STANDARD HOLE CLEANING USING MULTIPLE BRUSHING OR AIR BLAST STEPS OR ANOTHER EQUIVALENT METHOD APPROVED BY THE CONTRACT ADMINISTRATOR AND
- ADHESIVE FOR DOWELS TO BE HILTI HIT-HY 200 V3 EPOXY ADHESIVE INSTALLED IN ACCORDANCE WITH THE MANUFACTURER'S RECOMMENDATIONS. INSTALLATION SHALL BE PERFORMED B PERSONNEL TRAINED TO INSTALL THE SYSTEM.
- DOWELS SHALL HAVE MINIMUM EMBEDMENT AS FOLLOWS, U.N.O.

BAR SIZE	MINIMUM EMBEDMENT
10M	150
15M	200
20M	270

9. ALL REINFORCEMENT TO HAVE CLEAR COVER AS FOLLOWS, U.N.O.:

	LOCATION	CLEAR COVER			
TOP SURFACE		70			
	VERTICAL SURFACE	70			
	POTTOM SUIDEACE	60			

- 10. ALL REINFORCING BARS WITH HOOKED ENDS SHALL HAVE STANDARD HOOK LENGTHS, U.N.O.
- 11. ANCHOR BOLTS / THREADED RODS SHALL CONFORM TO ASTM A193 GRADE B7.
- 12. CONCRETE CORING IS NOT PERMITTED, U.N.O.
- MECHANICAL SPLICES ARE NOT PERMITTED UNLESS APPROVED BY THE CONTRACT ADMINISTRATOR. MECHANICAL COUPLERS SHALL BE FABRICATED OF MATERIALS COMPATIBLE WITH REINFORCEMENT TO BE SPLICED AND SHALL CONFORM TO CSA S6:19 CLAUSE 8:4:4.4. THE WITH REINFORCEMENT TO BE SPICED AND SPILEL CONTROL AS 38-12 CLAUSE S.4.4.4. THE LOCATION OF ALL SPILECS SHALL BE SHOWN ON THE REINFORCING SHOP DRAWINGS. TECHNICAL INFORMATION ON PROPOSED COUPLERS AND THE SHOP DRAWINGS SHALL BE SUBMITTED TO THE CONTRACT ADMINISTRATOR FOR REVIEW AND APPROVAL.
- EXISTING DECK REINFORCEMENT IS EPOXY COATED. ANY EPOXY COATED BAR WITH COATING DAMAGE SHALL BE REPAIRED WITH TWO PART EPOXY COATING IN ACCORDANCE WITH ASTM

STEELWORK:

- EXISTING STEEL COMPONENTS INDICATED FOR REPAIR ON THE DRAWINGS SHALL BE CLEANED AND FREE OF CORROSION AND OTHER FOREIGN MATERIALS AND COATED WITH TWO COATS OF ZINGA OR APPROVED EQUAL PRIOR TO ANY REPAIRS TAKING PLACE.
- STEEL TO CONFORM TO CSA G40.20/G40.21
- ALL WELDS TO BE COMPLETED IN ACCORDANCE WITH CSA W59.
- MIN 6 mm FILLET WELD, U.N.O.
- STEEL FABRICATOR TO BE CERTIFIED FOR DIVISION 3 IN ACCORDANCE WITH CSA 47.1
- ALL STEEL WORK TO BE HOT DIP GALVANIZED TO ASTM A123M AND ASTM A385, MINIMUM 610 g/m² THICKNESS OF COATING, U.N.O. SAFEGUARD AGAINST EMBRITTLEMENT TO ASTM PRACTICE
- DAMAGE TO GALVANIZING AND FIELD WELDS TO BE TOUCHED UP WITH TWO COATS OF ZINGA IN ACCORDANCE WITH MANUFACTURER'S SPECIFICATIONS.
- 8. STUD CONNECTORS SHALL BE IN ACCORDANCE WITH ASTM A108, GRADE 1010 OR 1020.

REMOVAL AND DEMOLITION:

- THE CONTRACTOR IS RESPONSIBLE FOR ALL NECESSARY MEASURES REQUIRED TO REMOVE AND DISPOSE OF ALL MATERIALS IN ACCORDANCE WITH PROJECT SPECIFICATIONS AND SHOWN ON THE DRAWINGS AS WELL AS PREVENT CONSTRUCTION DEBRIS OR OTHER DELETERIOLIS MATERIAL FROM FALLING INTO THE ROADWAY. DO NOT REMOVE MORE CONCRETE THAN SHOWN ON THE REPAIRS WITHOUT THE APPROVAL OF THE CONTRACT ADMINISTRATOR.
- REMOVE CONCRETE USING MAX 7 kg CHIPPING HAMMERS UNLESS APPROVED BY THE CONTRACT
- ALL EXISTING REINFORCING BARS TO REMAIN U.N.O. DO NOT DAMAGE EXISTING REINFORCEMENT. ANY DAMAGED REINFORCEMENT TO BE REINSTATED OR REPLACED AS DIRECTED BY THE CONTRACT ADMINISTRATOR.
- THE LOCATION, SIZE, SPACING AND EXTENT OF EXISTING REINFORCING BARS MAY VARY SIGNIFICANTLY FROM THAT SHOWN. THE CONTRACTOR SHALL LOCATE ALL REINFORCING BARS PRIOR TO REMOVING ANY CONCRETE
- WHERE REINFORCING BARS ARE EXPOSED, ENSURE MIN 20 mm OF CONCRETE REMOVAL AROUND WHERE REINFORCING BARS ARE EXPOSED, ENGURE WILL 20 IIIII OF CONCRETE REINFORCING AROUNT REINFORCING STEEL OF ALL TRACES OF RUST AND CONCRETE. THE STEEL SHOULD BE HIGH-PRESSURE WASHED WITH CLEAN WATER AFTER MECHANICAL CLEANING AND MAINTAINED TO THE CONDITION UNTIL PLACEMENT OF NEW CONCRETE OR PATCH REPAIR MATERIAL, SUPPLEMENT DETERIORATED OR DAMAGED REINFORCING BARS IN ACCORDANCE WITH PROJECT SPECIFICATIONS.
- 6. EXISTING REINFORCING WITH SECTION LOSS EXCEEDING 2 mm SHALL BE REPLACED.

EXPANSION JOINTS AND SEALS:

- EXPANSION JOINT ASSEMBLIES SHALL BE COMPLETE WITH ERECTION SETTING ANGLES.
- PRIOR TO FINAL PLACEMENT IN THE BLOCKOUT, THE ASSEMBLY SHALL BE ADJUSTED TO ITS FINAL
- THE EXPANSION JOINT SHALL BE PLACED INTO ITS FINAL POSITION IN THE BLOCKOUT AND
- 4. ENSURE THAT THE JOINT WIDTH IS UNIFORM ALONG THE ENTIRE JOINT LENGTH
- IMMEDIATELY AFTER THE JOINT HAS BEEN TIED INTO THE BLOCKOUT, ALL PRESET AND LIFTING
- PROTECT THE TOP OF THE EXPANSION JOINT DURING PLACEMENT OF CONCRETE.
- THE STRIP SEAL SHALL BE INSTALLED IN A SINGLE CONTINUOUS LENGTH FOR THE ENTIRE WIDTH
- THE JOINT ARMOUR SHALL BE WELDED AT CONSTRUCTION JOINTS IN ACCORDANCE WITH THE MANUFACTURER'S RECOMMENDATIONS TO ENSURE WATER-TIGHTNESS, AS REQUIRED TO ACCOMMODATE TRAFFIC STAGING
- FOLLOWING INSTALLATION, COMPLETE A FLOOD WATER TEST IN ACCORDANCE WITH PROJECT

ABREVIATIONS:

C/W	COMPLETE WITH	
C/C	CENTRE TO CENTRE	
DEG	DEGREES	
DWG	DRAWING	
LG	LONG	
MAX	MAXIMUM	
MIN	MINIMUM	
O/C	ON CENTRE	
PL	PLATE	
SYMM	SYMMETRICAL	
TYP	TYPICAL	
U.N.O.	UNLESS NOTED OTHERWISE	
W/ WITH		





PERMIT TO PRACTICE ASSOCIATED ENGINEERING (B.C.) LTD. PERMIT NUMBER: 1000163

2025-05-28 J. YANEZ ROJAS T. JOHNSTON ISSUED FOR TENDER DESIGN DRAWN REV DATE DESCRIPTION

BR230 MARINER WAY OVERPASS STRUCTURAL REHABILITATION

2025-2205-01


SCALE: AS SHOWN

CITY OF COQUITLAM

STRUCTURAL

GENERAL NOTES

SHEET DRAWING REVISION 2205-01-S-101 0

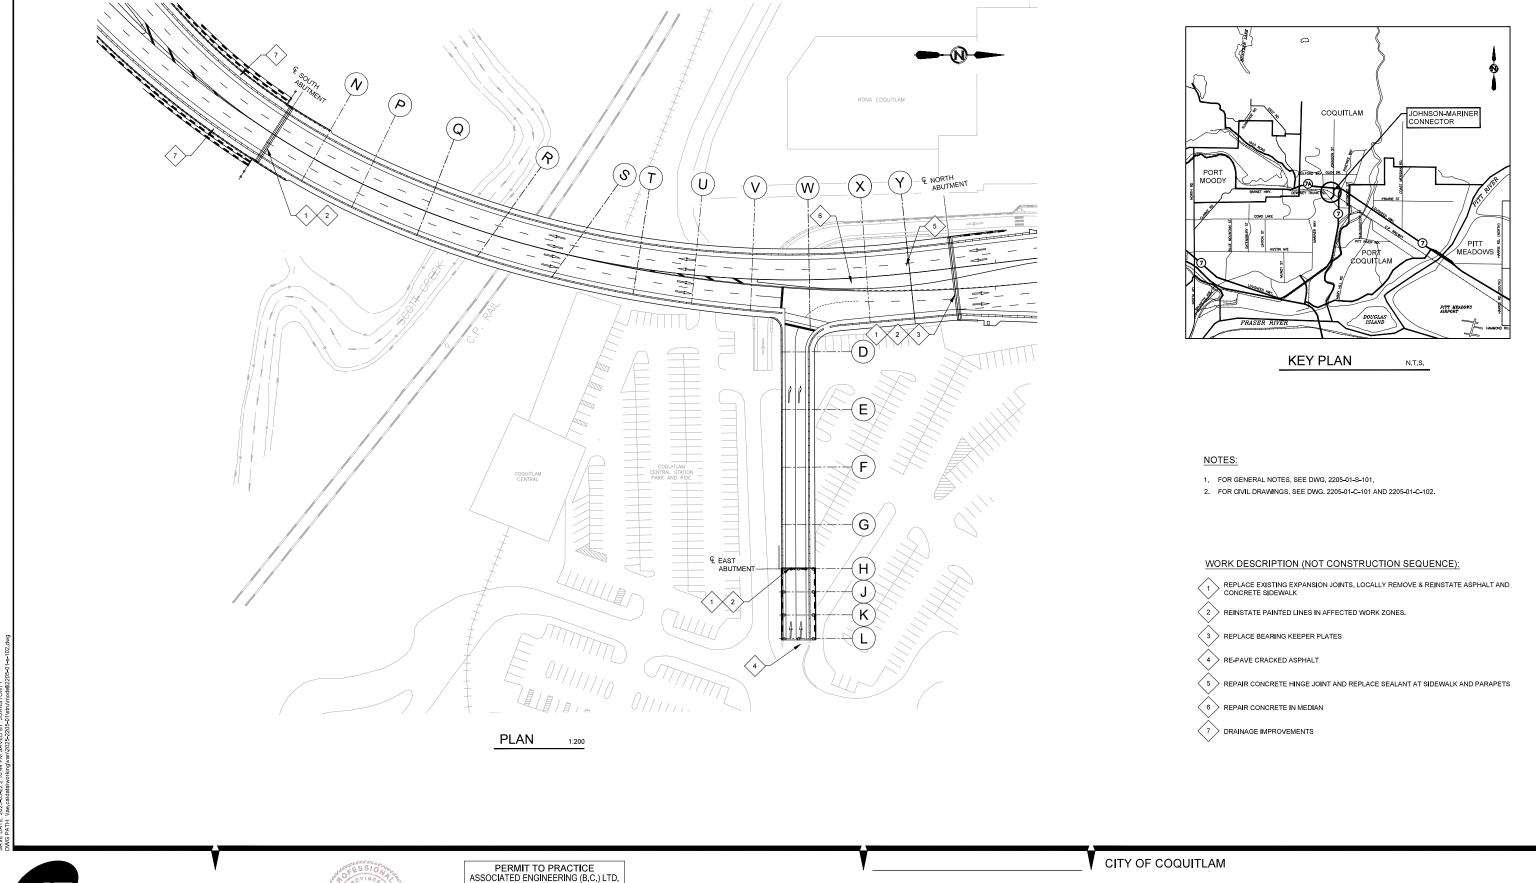







ARE INTENDED FOR ANSI D (22X34) SIZE DRAWINGS, TABLOID (11X17) SIZE DRAWINGS ARE 1/2 OF SCALE(S) SHOWN UNLESS NOTED OTHERWISE

PERMIT TO PRACTICE ASSOCIATED ENGINEERING (B.C.) LTD. PERMIT NUMBER: 1000163 Engineers & Geoscientists BC

-

BR230 MARINER WAY OVERPASS STRUCTURAL REHABILITATION


2025-2205-01


SCALE: AS SHOWN


STRUCTURAL
GENERAL ARRANGEMENT


 DRAWING
 REVISION
 SHEET


 2205-01-S-102
 0
 5

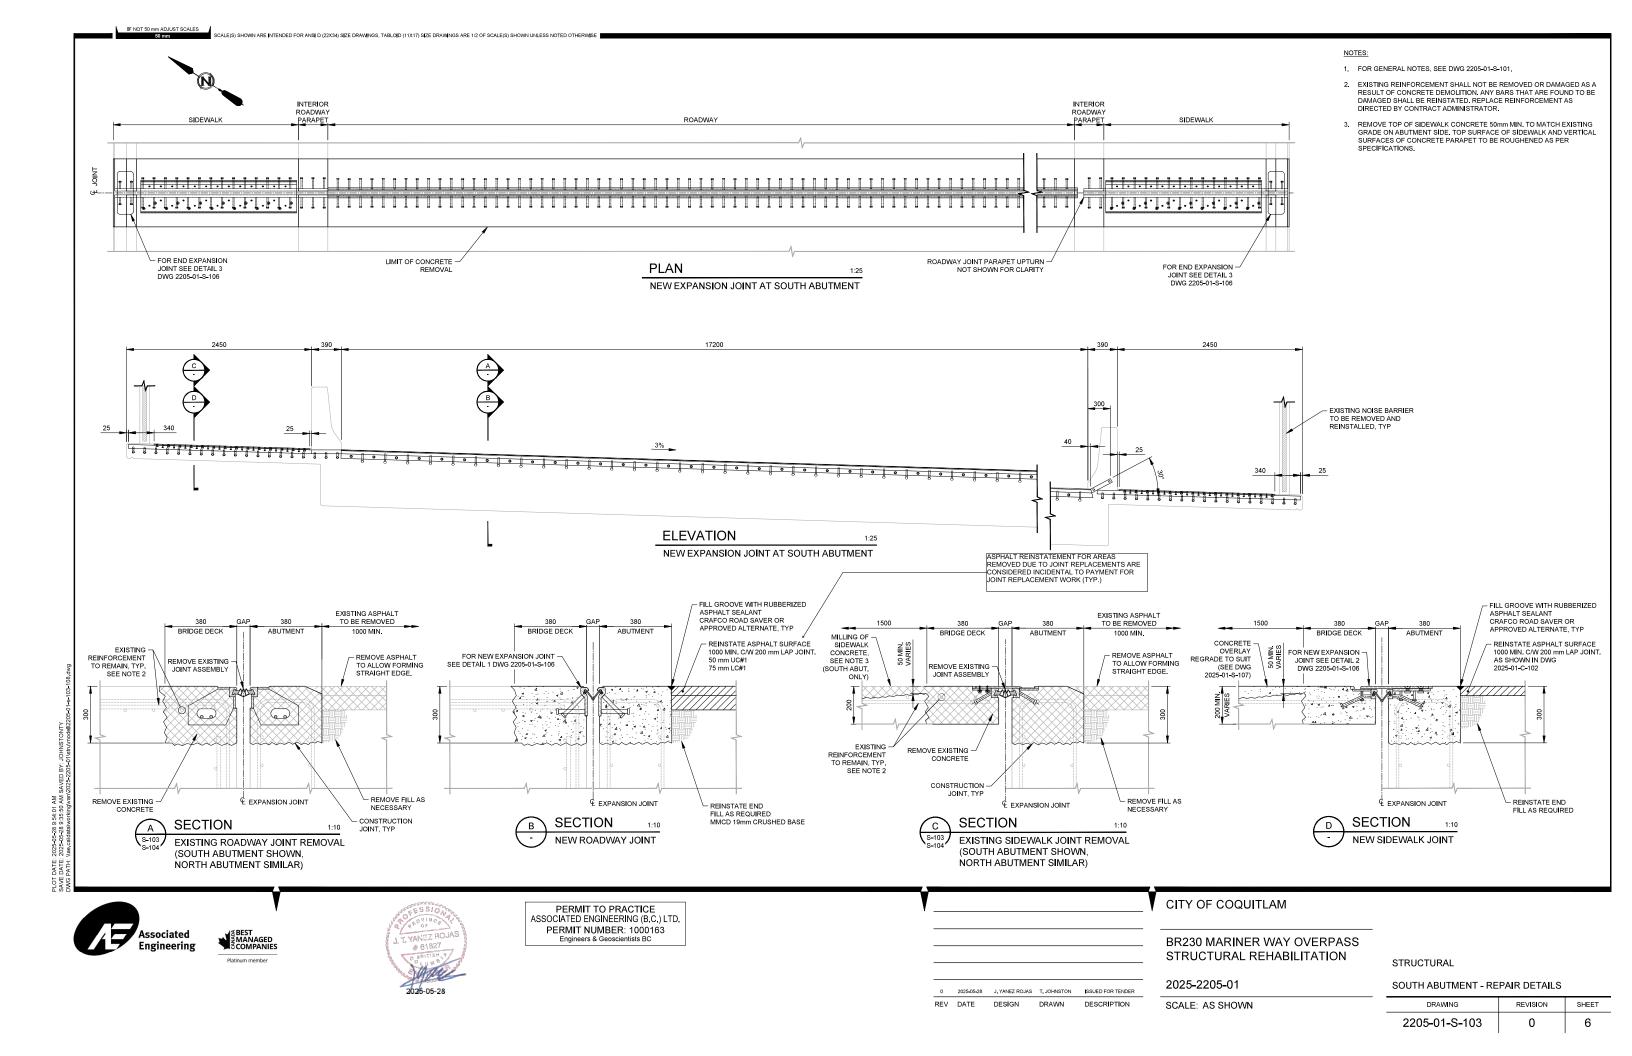

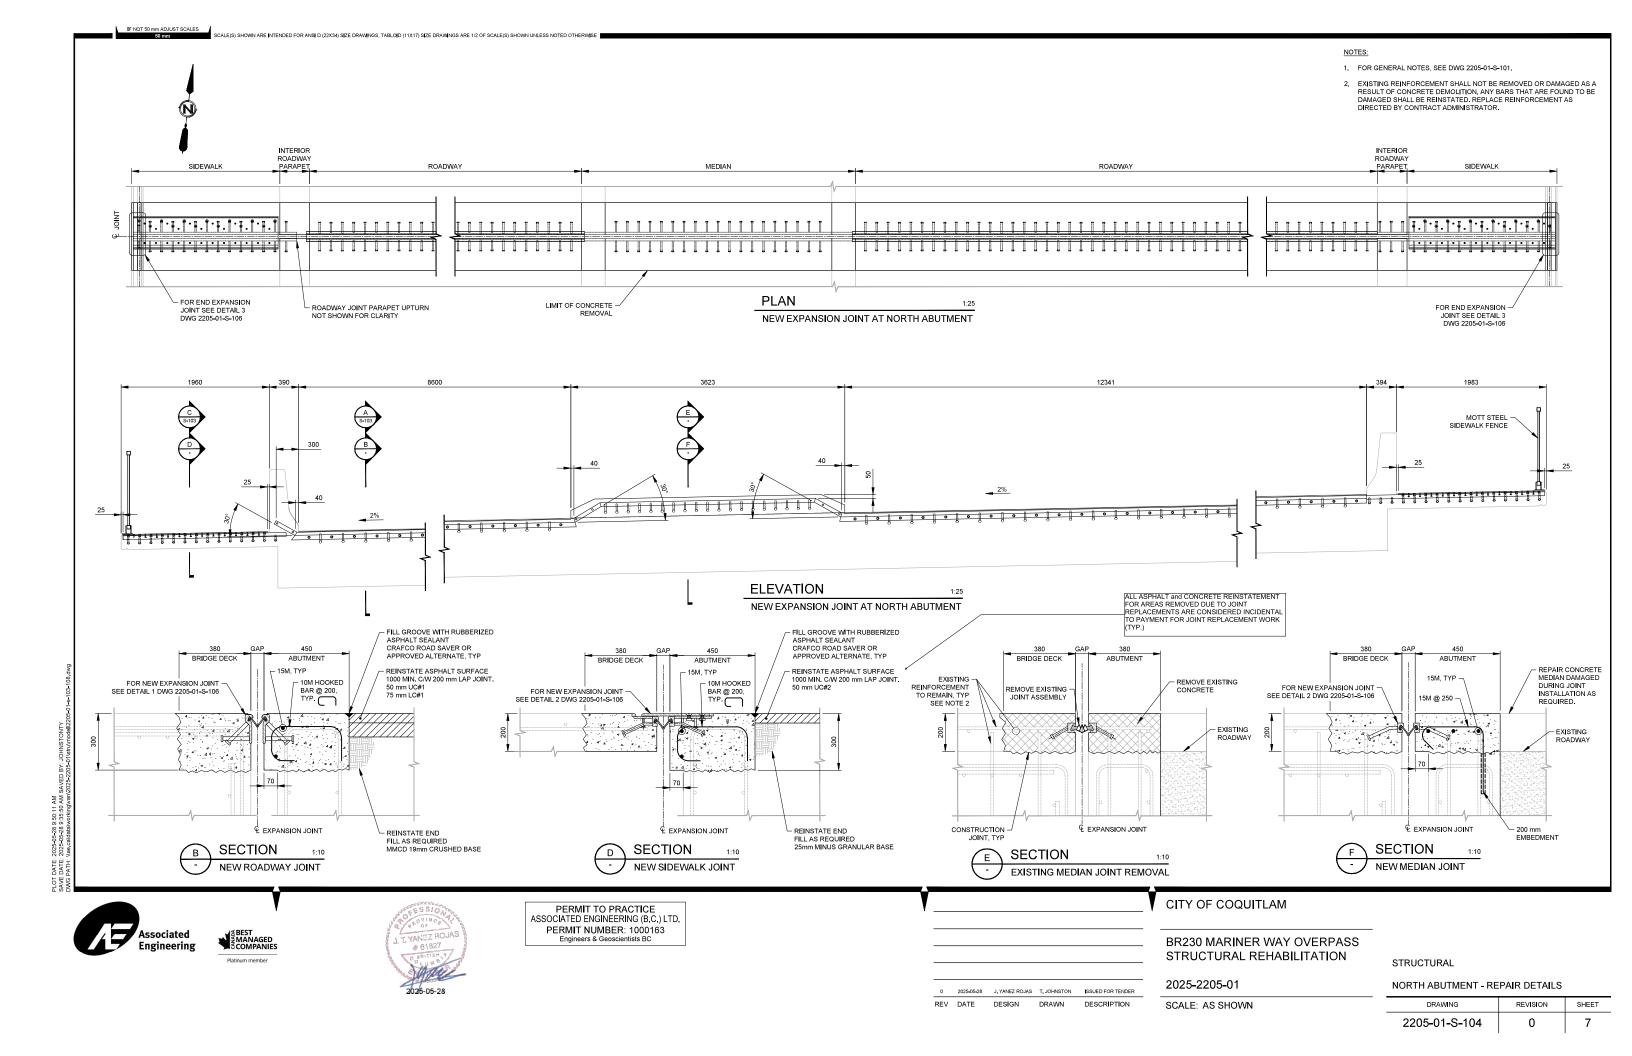

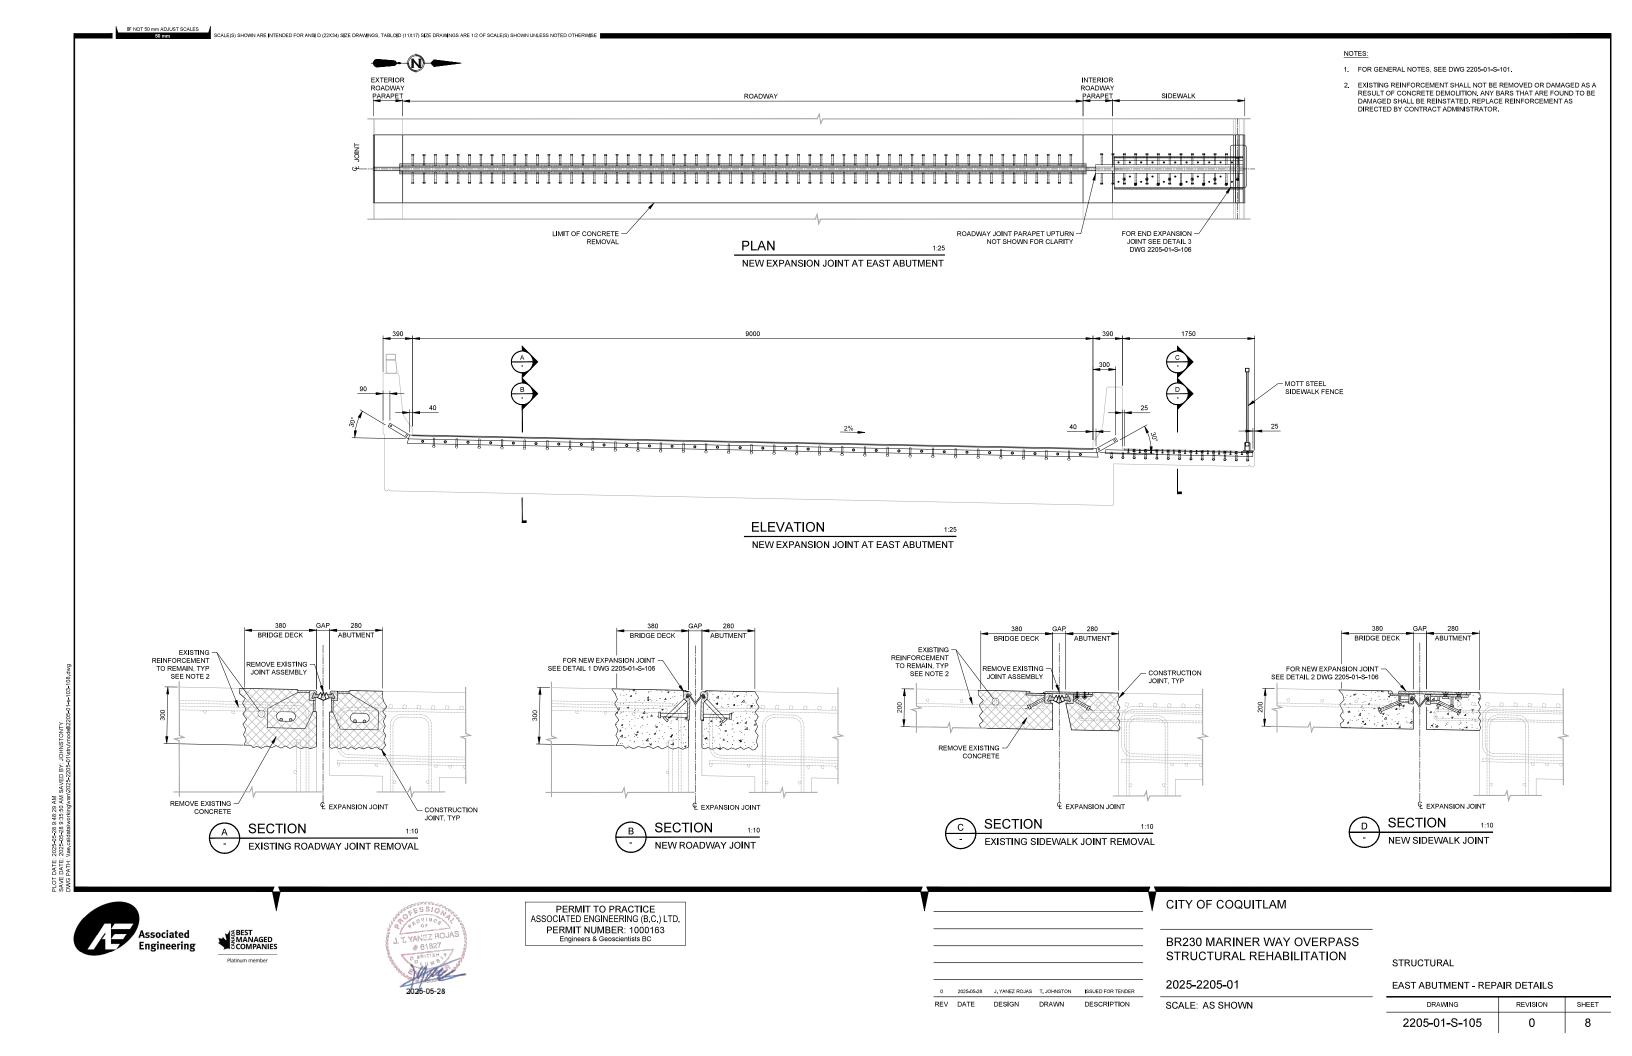

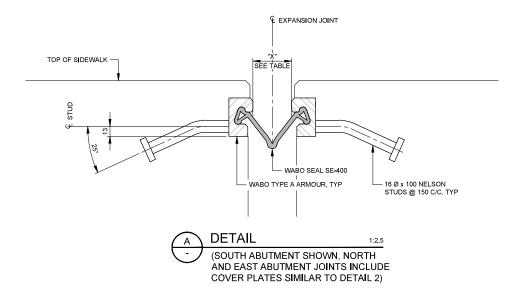

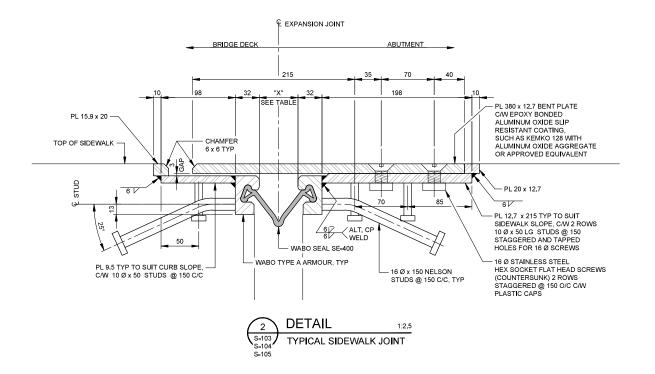

JOINT GAP "X" SETTING DETAIL						
TEMPERATURE (°C)	0	5	10	15	20	25
"X" (mm)	76	70	63	57	51	45

0 2025-05-28 J. YANEZ ROJAS T. JOHNSTON ISSUED FOR TENDER REV DATE DESIGN DRAWN DESCRIPTION

- 1. FOR GENERAL NOTES, SEE DWG 2205-01-S-101.
- 2. JOINT TO BE INSTALLED IN TEMPERATURES BETWEEN 0°C AND 25°C. FOR INSTALLATION OUTSIDE OF THE RANGE, CONTACT CONTRACT ADMINISTRATOR.





PERMIT TO PRACTICE ASSOCIATED ENGINEERING (B.C.) LTD. PERMIT NUMBER: 1000163

BR230 MARINER WAY OVERPASS STRUCTURAL REHABILITATION

2025-2205-01


SCALE: AS SHOWN

CITY OF COQUITLAM

STRUCTURAL

EXPANSION JOINT DETAILS

DRAWING	REVISION	SHEET
2205-01-S-106	0	9

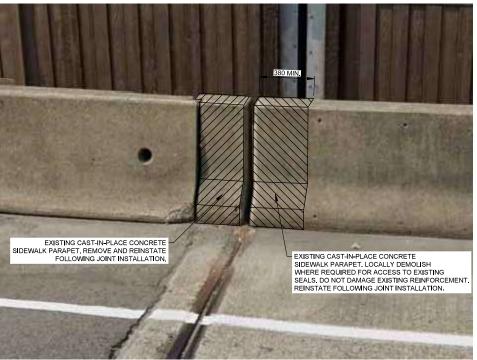

PARAPET DEMOLITION AND REINSTATEMENT INTERIOR PARAPET AT SOUTH ABUTMENT SHOWN (SIMILAR AT NORTH AND EAST ABUTMENT)



SIDEWALK CONCRETE OVERLAY EXPANSION JOINT AT SOUTH ABUTMENT







PERMIT TO PRACTICE ASSOCIATED ENGINEERING (B.C.) LTD. PERMIT NUMBER: 1000163



STEEL FENCE ON SIDEWALK EXPANSION JOINT AT SIDEWALK

CITY OF COQUITLAM

BR230 MARINER WAY OVERPASS STRUCTURAL REHABILITATION

SCALE: AS SHOWN

STRUCTURAL

PARAPET AND NOISE BARRIER DETAILS

DRAWING REVISION SHEET 2205-01-S-107 10 0





2025-2205-01 0 2025-05-28 J. YANEZ ROJAS T. JOHNSTON ISSUED FOR TENDER

REV DATE DESIGN DRAWN DESCRIPTION

CALE(S) SHOWN ARE INTENDED FOR ANSI D (22X34) SIZE DRAWINGS, TABLOID (11X17) SIZE DRAWINGS ARE 1/2 OF SCALE(S) SHOWN UNLESS NOTED OTHERWISE


SEALANT REPLACEMENT PARAPET AND SIDEWALK




CONCRETE REPAIR NORTH END - MEDIAN





REPLACEMENT OF BEARING KEEPER PLATES NORTH ABUTMENT

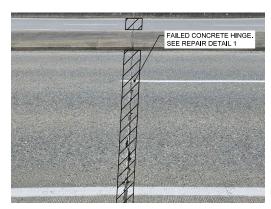

CONCRETE HINGE JOINT REPAIR PIER Y

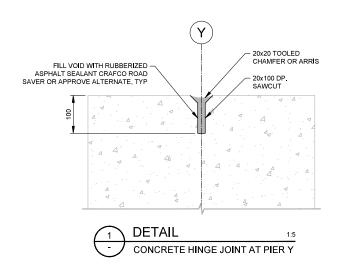

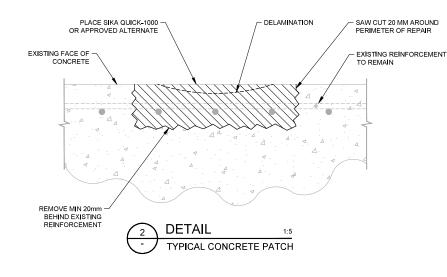

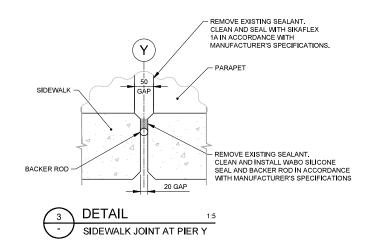

- 1. FOR GENERAL NOTES, SEE DWG 2205-01-S-101.
- 2. REPAIR LOCATIONS SHOWN ARE INDICATIVE ONLY. CONTRACTOR AND CONTRACTOR ADMINISTRATOR TO FIELD CONFIRM LOCATIONS AND EXTENT OR REPAIR REQUIRED.







PERMIT TO PRACTICE ASSOCIATED ENGINEERING (B.C.) LTD. PERMIT NUMBER: 1000163

BR230 MARINER WAY OVERPASS

2025-2205-01 0 2025-05-28 J. YANEZ ROJAS T. JOHNSTON ISSUED FOR TENDER REV DATE DESIGN DRAWN DESCRIPTION SCALE: AS SHOWN

STRUCTURAL REHABILITATION

CITY OF COQUITLAM

STRUCTURAL


MISCELLANEOUS REPAIR DETAILS


DRAWING REVISION SHEET 2205-01-S-108 11 0

CITY OF COQUITLAM

3000 GUILDFORD WAY, COQUITLAM, BC V3B 7N2

MARINER TRANSIT RAMP IMPROVEMENTS ISSUED FOR TENDER

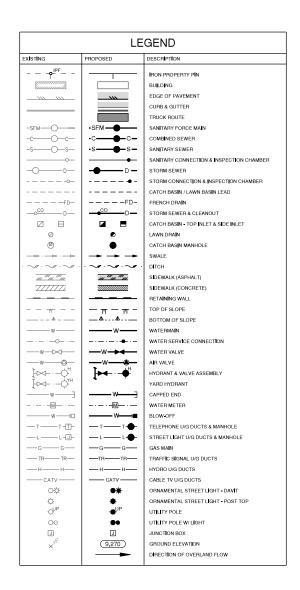

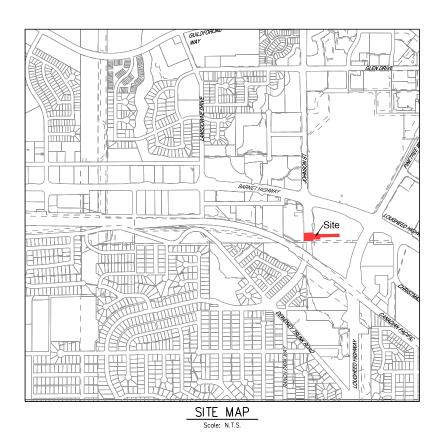

DRAWING INDEX					
SHEET#	DRAWING TITLE	DWG#			
00	COVER SHEET	24-0442-CV			
01	ROADWORKS - MARINER OVERPASS	24-0442-R1			
	COVER SHEET	EN024-1670-S000			
	GENERAL NOTES	EN024-1670-S100			
	WORKING DRAWINGS	EN024-1670-S101			
	CONCRETE MEDIAN DETAILS	EN024-1670-S102			
	TRAFFIC SIGNAL	8250-24-01			
	TRAFFIC SIGNAL	8250-24-02			





R.F. BINNIE & ASSOCIATES LTD. 300 - 4940 Canada Way,

Burnaby, BC V5G 4K6
TEL 604 420 1721
BINNIE COM

BENCHMARK:

MARINER WAY

File: 24-0442-R1

MARINER WAY TRANSIT RAMP

PAVEMENT MARKINGS AND SIGNS

Eng. Project No. 24-0442

Coouitlam

Engineering & Public Works

3000 Guildford Way, Coquittam, B.C. V3B 7N

GEODETIC ELEVATIONS ARE DERIVED FROM G.P.S OBSERVATIONS. MARINER WAY TRANSIT RAMP DATUM IS [CGVD28 (GVRD 2018)]

GENERAL CONSTRUCTION NOTES

- ALL MATERIALS SUPPLIED AND CONSTRUCTION PERFORMED SHALL BE IN ACCORDANCE WITH THE CITY OF COQUITLAM SUBDIVISION AND DEVELOPMENT SERVICING BYLAW No. 3558, THE 2009 MMCD PLATINUM BOOK, AND THE CURRENT COQUITLAM SUPPLEMENTARY
- REMOVE AND DISPOSE OF EX. AC PIPE IN ACCORDANCE WITH WORKSAFE BC AND OTHER PERTINENT REGULATIONS.
- ALL EXCAVATION WITHIN EXISTING TREE DRIPLINES TO BE BY HAND OR
- CONTRACTOR SHALL RECORD COMPLETE AND ACCURATE AS-BUILT INFORMATION ON A SET OF CURRENT CONSTRUCTION DRAWINGS DURING CONSTRUCTION AND SUBMIT THE INFORMATION TO THE CONTRACT ADMINISTRATOR (CA). AS-BUILT INFORMATION SHALL INCLUDE:
- LIMITS OF PAVEMENT REPAIRS
 PIPE INVERTS

- PIPE INVERTS
 PIPE GRADES
 VALVE AND FITTING LOCATIONS
 SERVICE WYE LOCATIONS
 CONNECTIONS
- MANHOLES
- SERVICE ELEVATIONS @ IC'S PROPERTY LINE OFFSETS
- THE LOCATIONS OF THE EXISTING UTILITIES, AS SHOWN ON THE DESIGN DRAWINGS, ARE APPROXIMATE ONLY AND THIS INFORMATION MAY NOT BE FULLY ACCURATE OR COMPLETE. PRIOR TO THE START OF CONSTRUCTION, THE CONTRACTOR SHALL LOCATE AND EXPOSE ALL EXISTING UTILITIES AT ALL TIE-IN POINTS, AT ALL POINTS WHERE A CONFLICT MAY ARISE DURING THE CONSTRUCTION OF THE PROPOSED WORKS, AND TO CONFIRM DESIGN LECTATIONS, IN THE EVENT OF A CONFLICT, THE CONTRACTOR SHALL IMMEDIATELY NOTIFY THE CONTRACT ADMINISTRATOR.
- EXISTING UNDERGROUND UTILITY TRENCHES ADJACENT TO THE PROPOSED UNDERGROUND UTILITY INSTALLATION SHALL BE ADEQUATELY PROTECTED FROM SLOUGHING IN ORDER TO PREVENT OVER MEDIT LYCAMATION. OVER-WIDTH EXCAVATION.
- ALL SURVEY MONUMENTS, BENCHMARKS, AND LEGAL PINS MUST BE PROTECTED AND ANY DAMAGE CAUSED BY THE CONTRACTOR SHALL BE REPAIRED AT THE CONTRACTOR'S EXPENSE.


CONTRACTOR TO IDENTIFY ANY SURVEY MONUMENTS AND LEAD PLUGS THAT MAY BE DISTURBED DURING CONSTRUCTION AND ARRANGE WITH THE OWNER'S SURVEY DEPARTMENT 5 DAYS PRIOR TO CONSTRUCTION TO REFERENCE LOCATIONS BEFORE WORK COMMENCES.

ROADWORKS NOTES:

- CONTRACTOR TO ADJUST ALL CATCH BASINS, MANHOLES, VALVE COVERS, AND ALL OTHER APPURTENANCES TO SUIT FINISHED GRADES.
- CONTRACTOR TO REMOVE AND REPLACE INDIVIDUAL DAMAGED SIDEWALK PANELS AND DAMAGED CURB AND GUTTER SECTIONS AS DIRECTED BY THE CONTRACT ADMINISTRATOR.
- ALL PAVEMENT MARKINGS TO BE REINSTATED IN THE PLACE OF WORK UNLESS NOTED CHIERWISE. CONTRACTOR IS RESPONSIBLE TO PERFORM PRE AND POST CONSTRUCTION SURVEY WORK FOR THE REINSTATEMENT OF PAVEMENT MARKINGS.

REINSTATE ALL PAVEMENT MARKINGS AS PER THE LATEST VERSION OF THE M.U.T.C.D CANADA STANDARD. ALL PAVEMENT MARKINGS SHALL BE MMA PAINT.

- LOCATIONS OF DRIVEWAYS AND WHEELCHAIR RAMPS SHALL BE CONFIRMED IN THE FIELD PRIOR TO CONSTRUCTION OF CURB AND GUTTER.
- CHANGES IN GRADE SHALL BE FORMED WITH SMOOTH CURVES.
- CATCH BASIN RIM ELEVATIONS SHALL BE SET 30mm BELOW THE FINISHED GUTTER LINE GRADES. THE GUTTER AND ROAD SURFACE AREA TO BE SHAPED TO FORM A DISH AROUND THE INLET.
- ALL ASPHALT JOINTS MUST BE SMOOTH AND WITHOUT VISIBLE BREAKS IN THE GRADE, THOROUGHLY COMPACTED NEAT JOINTS ARE REQUIRED. CONTRACTOR TO SUBMIT DENSITY TESTS TAKEN ON JOINTS, NO INDIVIDUAL TESTS SHALL BE LESS THAN 95% OF 75 BLOW MARSHALL

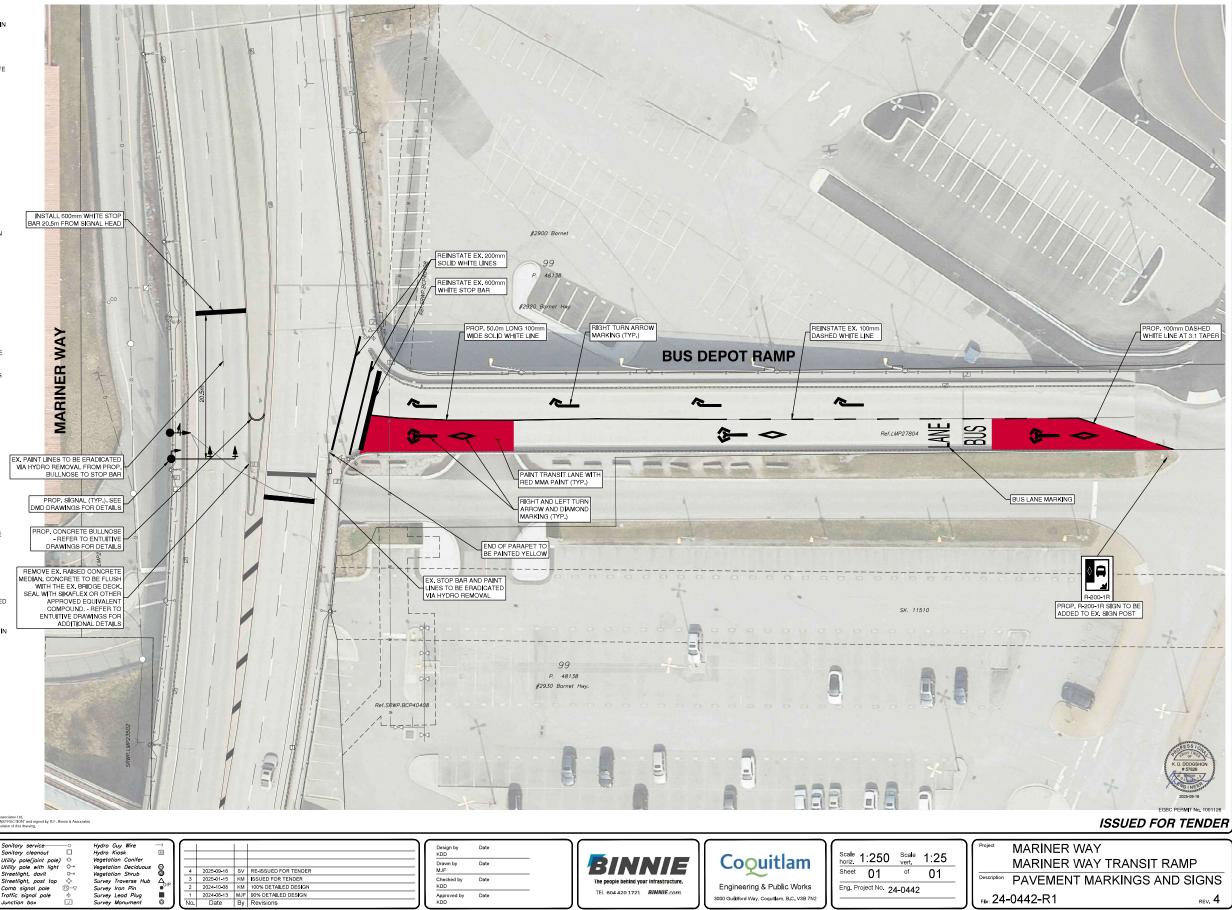

BINNIE

Design by KDD Drawn by MJF

Checked by KDD

2025-01-15 KM ISSUED FOR TENDER 2024-10-08 KM 100% DETAILED DESIGN

Date

DRAWING LIST		
DRAWING#	DRAWING NAME	
S000	COVER PAGE	
S100	GENERAL NOTES	
S101	WORKING DRAWINGS	

© 2024 ENTUITIVE CORPORATION. MUST BE RETURNED UPON REQUEST. "REPRODUCTION OF THESE DRAWINGS, SPECIFICATIONS, RELATED DOCUMENTS AND DESIGNS IN WHOLE OR IN PART IS STRICTLY FORBIDDEN WITHOUT THE PRIOR WRITTEN PERMISSION OF FITUITIVE CORPORATION

MARINER WAY TRANSIT RAMP INTERSECTION IMPROVEMENTS

ENTUITIVE

ISSUED FOR TENDER JANUARY 10, 2025



NOT FOR CONSTRUCTION

□ 2025-01-10					
0	10 01 2025	ISSUED FOR TENDER	FH		
MARK	DATE	REVISIONS	BY		
		TILLTINA			

200 University Avenue, 7th Floor Toronto, ON M5H 3C6 Canada +1 416 477 5832

Coouitlam

Engineering & Public Works

DIECT NAA DINIET

MARINER WAY

EN024-1670

GENERAL NOTES

- 1. VERIFY ALL DIMENSIONS PRIOR TO PROCEEDING WITH THE WORK. REPORT ANY DISCREPANCIES. DO NOT SCALE THESE DRAWINGS.
- 2. FOR DETAILS AND DIMENSIONS NOT GIVEN ON STRUCTURAL DRAWINGS, CO-OPERATE WITH THE CONSULTANT.
- CO-OPERATE WITH THE CONSULTANTS IN GIVING SUFFICIENT NOTIFICATION OF WHEN WORKS ARE TO PROCEED SO THAT SAMPLING CAN BE CARRIED OUT.
- 4. IT IS THE RESPONSIBILITY OF THE CONTRACTOR TO SAFEGUARD THE EXISTING STRUCTURES AFFECTED BY THIS CONSTRUCTION.
- 5. MAKE ADEQUATE PROVISIONS FOR CONSTRUCTION STRESSES, WEATHER PROTECTION AND FOR SUFFICIENT TEMPORARY BRACING AND SHORING TO KEEP THE STRUCTURE PLUMB AND LEVEL DURING ALL PHASES OF THE WORK.

CONCRETE

1. ALL CONCRETE PRODUCTION AND PLACEMENT TO CONFORM TO CSA STANDARD CAN3.A23.1-M.

A. ALL CONCRETE 35MP

B. ALL EXTERIOR CONCRETE 35MPa, 5-7% AIR ENTRAINMENT

2. REINFORCING STEEL

A. REINFORCING STEEL SHALL BE IN ACCORDANCE WITH CSA STANDARD G30.18, GRADE 400.

B. CLEAR COVER TO REINFORCING:

a. TOP AND SIDE 50 b. BOTTOM 75i

4. DO NOT PROVIDE OPENINGS IN THE CONCRETE WORK OTHER THAN THOSE INDICATED ON THE STRUCTURAL DRAWINGS WITHOUT THE APPROVAL OF THE ENGINEER.

5. WHERE NO LAP SPLICE TYPE IS INDICATED, PROVIDE TENSION LAP SPLICE. ALL TENSION LAP SPLICES ARE CLASS B AS PER THE CHBDC.

6. CURE CONCRETE IN ACCORDANCE WITH CSA A23.1, LATEST EDITION.

7. ENSURE REINFORCING IS CLEAN; FREE OF LOOSE SCALE, OIL, DIRT, RUST, AND ANY OTHER FOREIGN COATING THAT AFFECT BONDING CAPACITY BEFORE PLACING REBAR.

PON REQUEST: "REPRODUCTION OF THESE DRAWINGS, PECIFICATIONS, RELATED DOCUMENTS AND DESIGNS IN JHOLE OR IN PART IS STRICTLY FORBIDDEN WITHOUT THE RIOR WRITTEN PERMISSION OF ENTUITIVE CORPORATION"

NOT FOR CONSTRUCTION



MARK	DATE	REVISIONS	BY
0	10 01 2025	ISSUED FOR TENDER	FH

ENTUITIVE

200 University Avenue, 7th Floor Toronto, ON M5H 3C6 Canada +1 416 477 5832

Coouitlam


Engineering & Public Works


N/A


MARINER WAY


GENERAL NOTES

S100

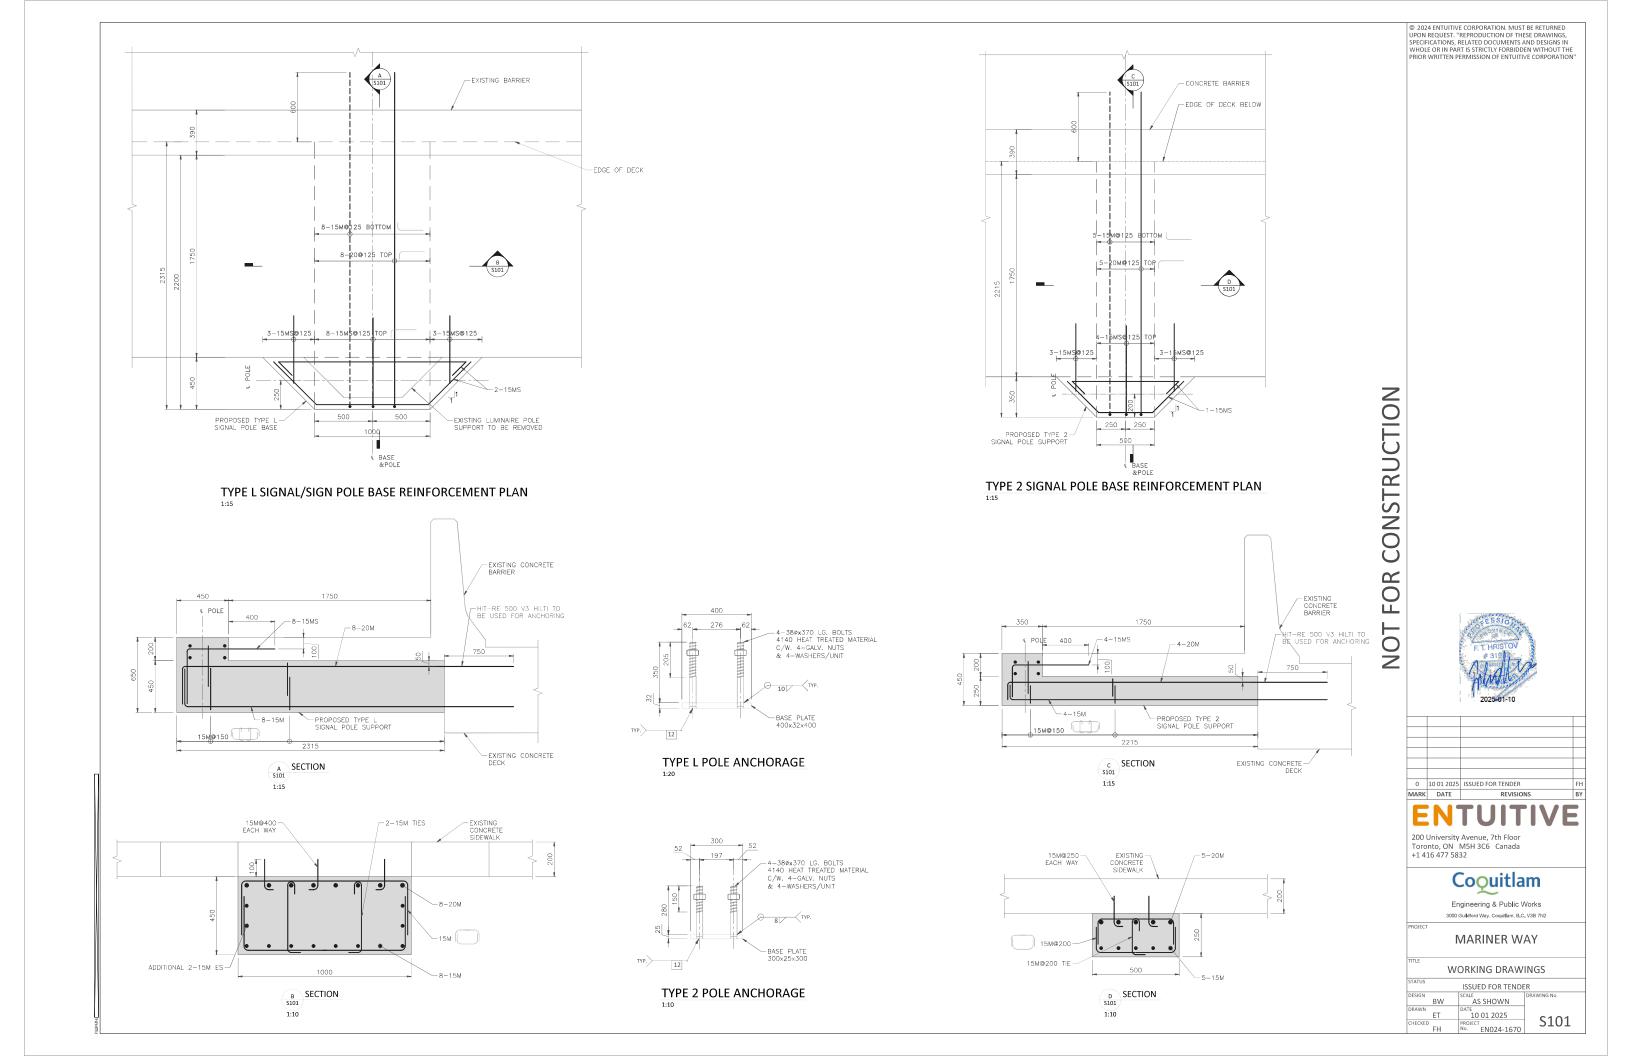

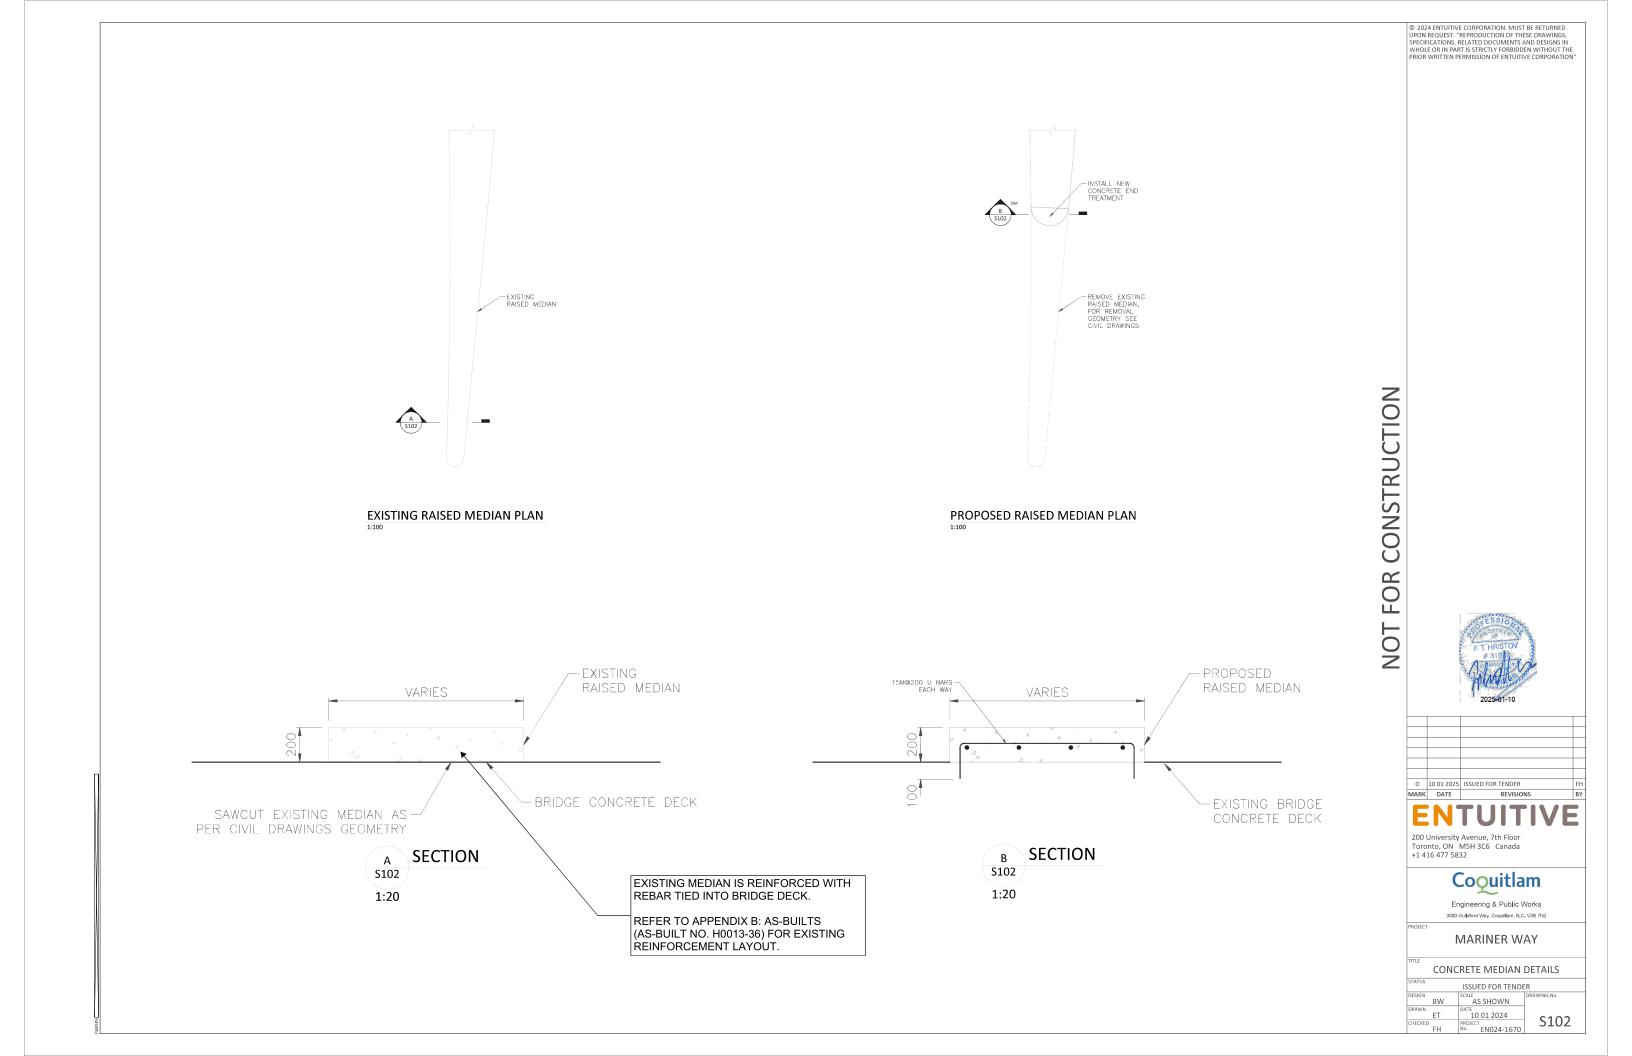

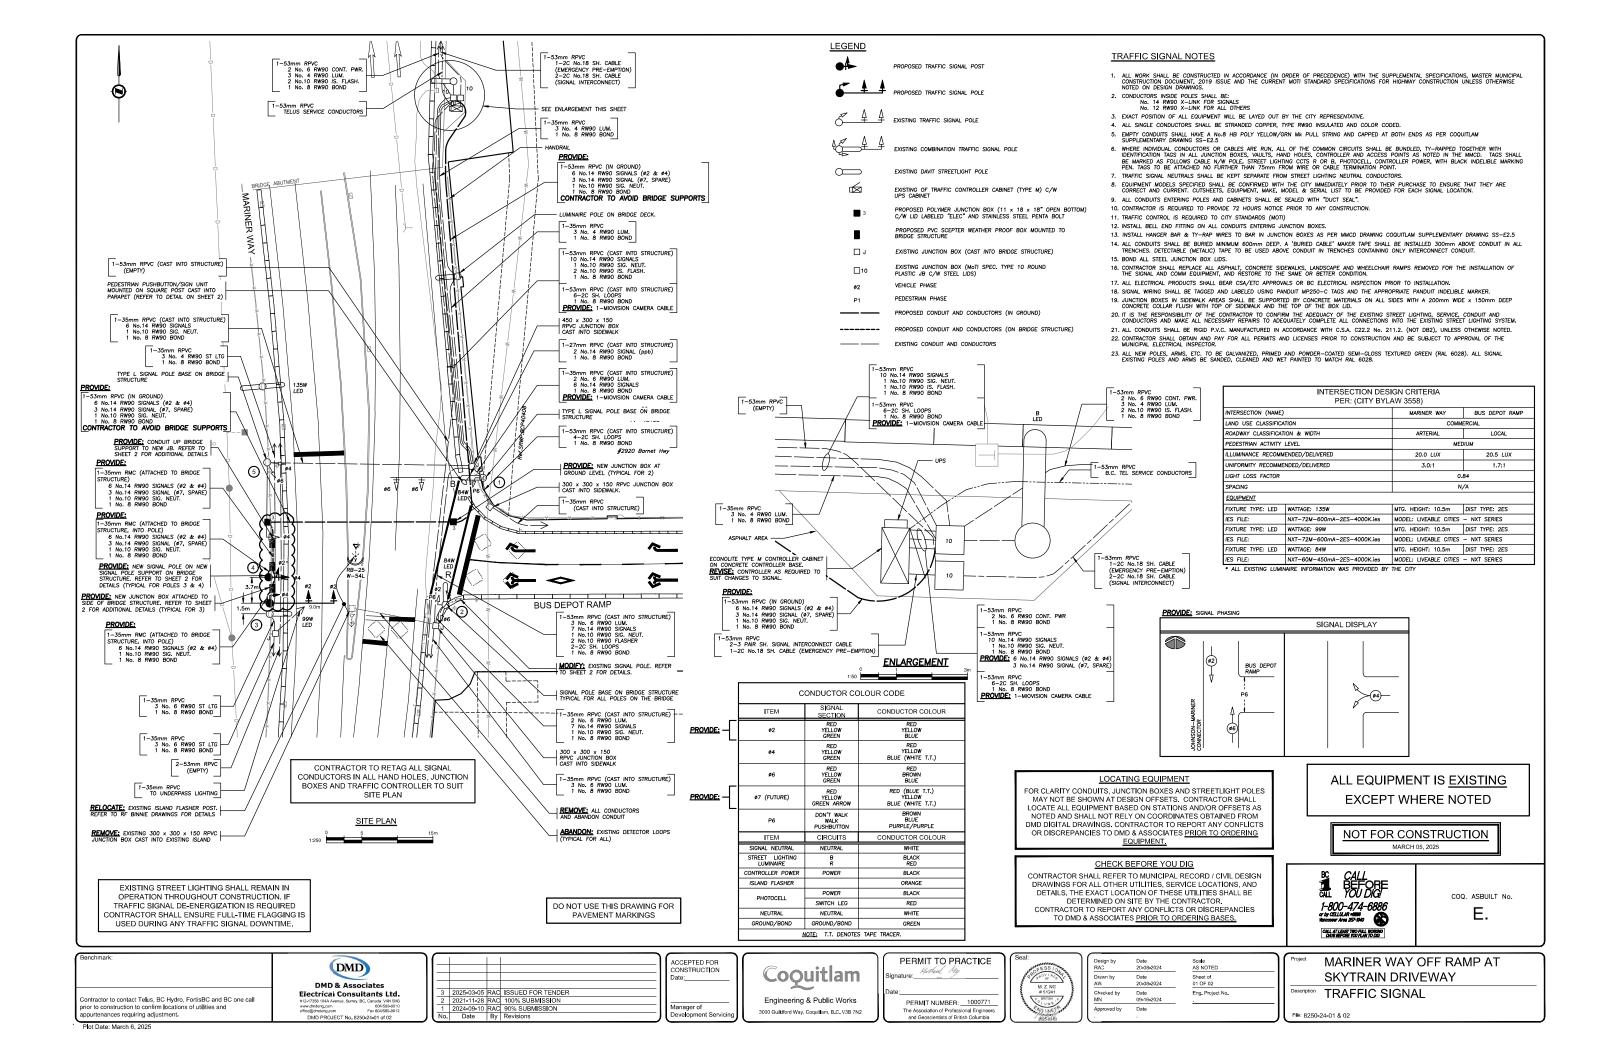

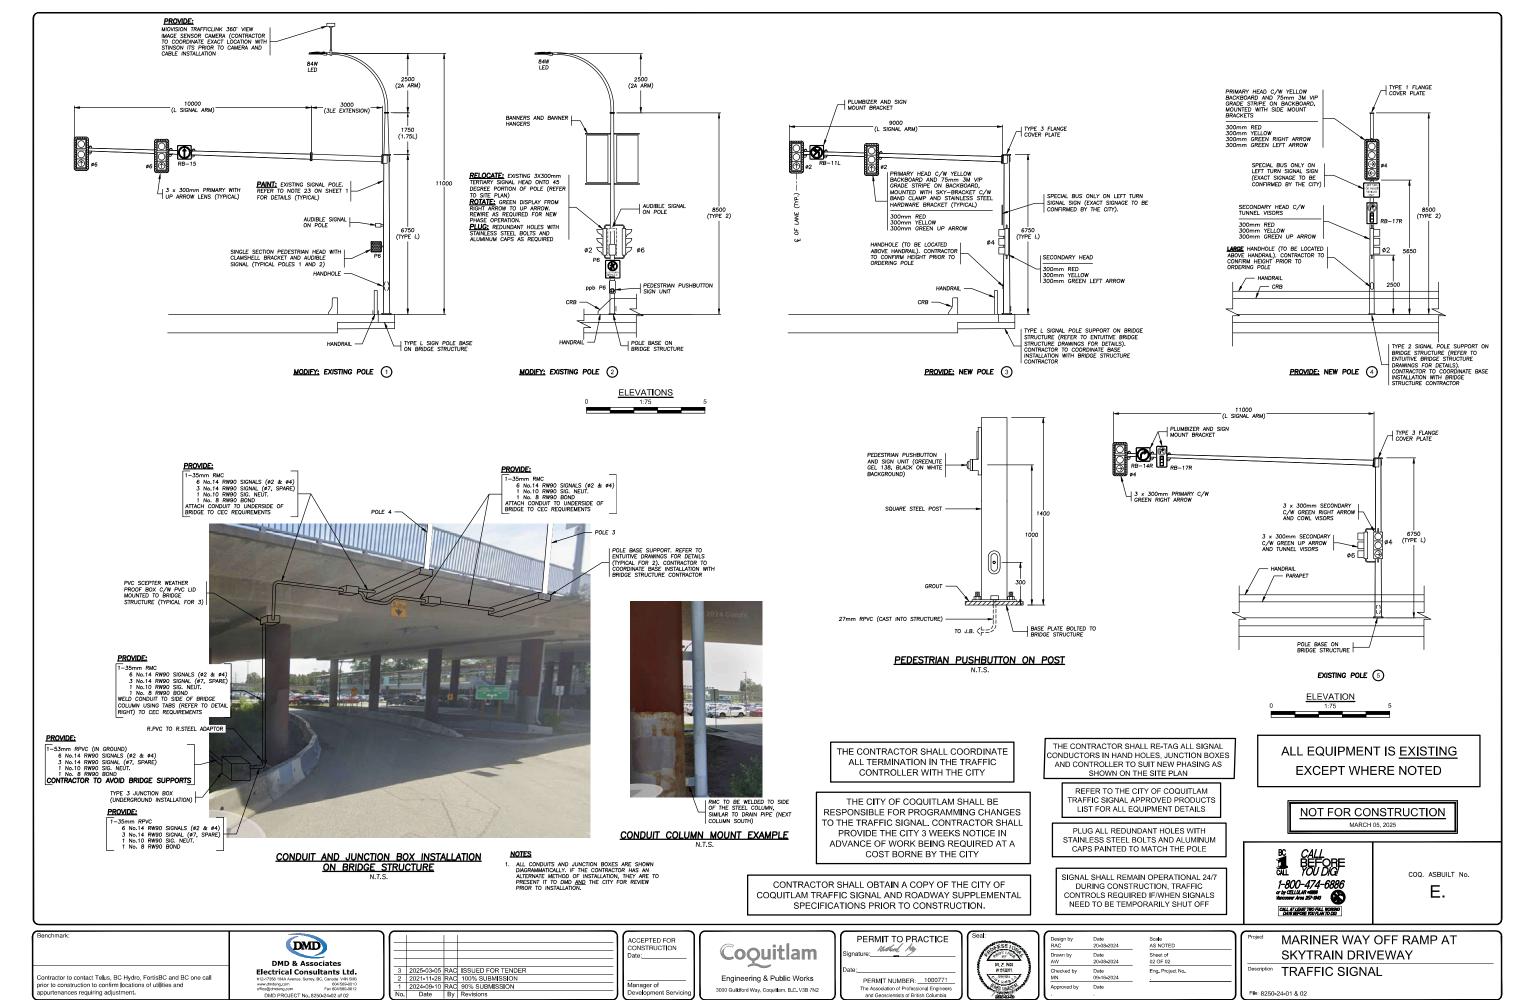

Plot Date: March 6, 2025